

#### SECOND FLOOR SHEAR WALL PLAN

SCALE: 1/8" = 1'-0" (SHEAR WALLS FROM SECOND FLOOR TO THE THIRD FLOOR)

#### PLAN NOTES

- SW-x

  1. SHEAR WALLS NOTED THUS INDICATE SHEAR WALLS FROM THE SECOND FLOOR TO THE THIRD FLOOR. ALL PANEL EDGES SHALL BE BLOCKED AND SHEATHING SHALL BE SECURELY FASTENED 3/8" FROM ALL PANEL EDGES. SW-X INDICATES SHEAR WALL DESIGNATION. SEE SCHEDULE ON SHEET S002 AND DETAILS ON SHEET S501 FOR ADDITIONAL INFORMATION.
- 2. SHEAR WALL SHEATHING SHALL BE CONTINUOUS ON PLANE OF WALL FOR ENTIRE LENGTH WITH NO INTERRUPTIONS TO IT FROM ABUTTING/INTERSECTING WALLS.
- 3. SEE DETAIL E/S501 FOR TERMINATION OF INTERIOR SHEAR WALLS AT INTERFACE WITH EXTERIOR WALLS AND CORRIDOR WALLS.
- 4. "HD" ON PLAN INDICATES (2) 2x STUD MIN WITH SIMPSON COIL STRAP. SEE SECTION H/S502 FOR ADDITIONAL INFORMATION. CONTRACTOR COORDINATE "S1" LOCATIONS WITH JAMBS/ARCHITECTURAL DRAWINGS. STRAPS ARE LOCATED AT INTERFACE BETWEEN FIRST FLOOR WALL AND SECOND FLOOR WALL. ALL "HD" SHALL ALIGN WITH HD LOCATIONS BELOW.
- 5. SEE THE FLOOR FRAMING AND SECTIONS SHOWN ON THE FLOOR FRAMING PLANS FOR DIAPHRAGM ATTACHMENT TO MASONRY ELEVATOR SHAFT.

### Fukui Architects Pc

205 Ross Street Pittsburgh, Pennsylvania 15219 ph 412.281.6001 fx 412.281.6002

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#### **PROVIDENCE**

ENGINEERING CORP

106 Isabella Street, Suite 301 Pittsburgh, PA 15212 Phone: 412-407-2250 Certificate Number: 3869

#### general notes

- Any conflicts in the drawings or between new and existing construction shall be referred to the Architect.
- 2. Contractor shall verify all dimensions and existing conditions in the field and shall advise Fukui Architects, Pc of any discrepancies between, additions to, deletions from, or alterations to any and all conditions prior to proceeding with any phase of work. Do not scale
- 3. All work shall be installed in accordance with applicable codes and regulations.
- 4. Contractor shall be responsible for the patching, repairing, and preparations of all existing floor, wall, and ceiling surfaces as required to receive scheduled finishes. 5. All items shown on drawings are finished construction
- assemblies. Contractor shall provide and install all material required for finished assemblies.
- **6.** All reports, plans, specifications, computer files, field data, notices, and other documents and instruments prepared by the Architect as instruments of service shall remain the property of the Architect. The Architect shall retain all common law statutory, and other reserved rights, including the copyright thereto.

revisions

project title

### Owner:

HACP 200 Ross Street

### **Client:**

Pittsburgh,PA,15219

Allies & Ross Management and Development Corporation (ARMDC) 200 Ross Street Pittsburgh, PA 15219

#### **Project Location:** Northview Heights Midrise

250 Penfort Street Pittsburgh, PA 15214

drawing title


SECOND FLOOR SHEAR WALL PLAN

As Noted

December 3rd, 2023

**S302** 

**Sheet No.** 

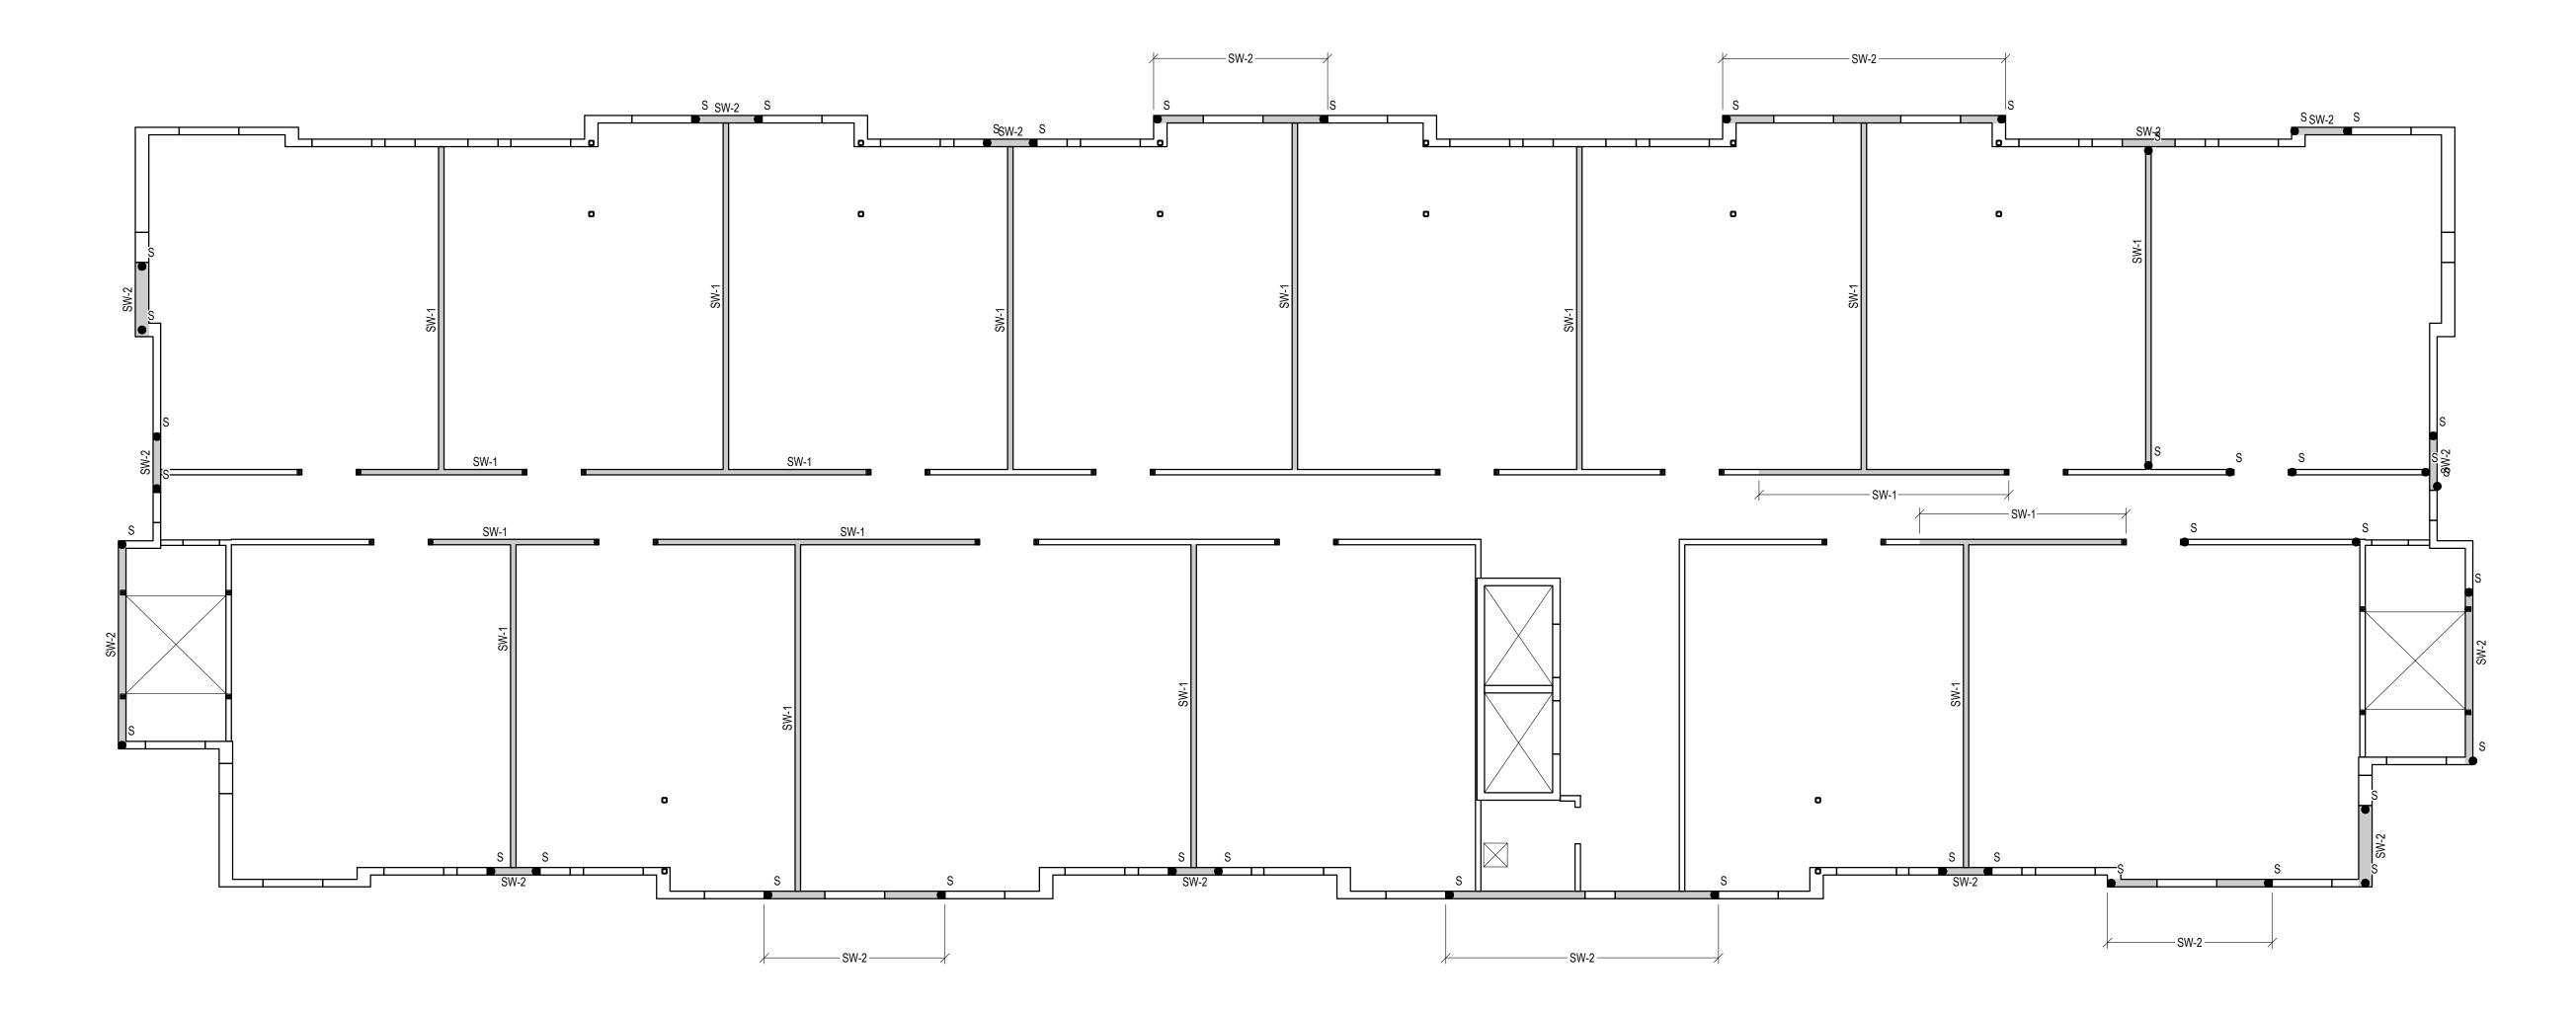

#### THIRD FLOOR SHEAR WALL PLAN

SCALE: 1/8" = 1'-0" (SHEAR WALLS FROM THIRD FLOOR TO THE FOURTH FLOOR)

#### PLAN NOTES

- SW-x

  1. SHEAR WALLS NOTED THUS INDICATE SHEAR WALLS FROM THE THIRD FLOOR TO THE FOURTH FLOOR. ALL PANEL EDGES SHALL BE BLOCKED AND SHEATHING SHALL BE SECURELY FASTENED 3/8" FROM ALL PANEL EDGES. SW-X INDICATES SHEAR WALL DESIGNATION. SEE SCHEDULE ON SHEET S002 AND DETAILS ON SHEET S501 FOR ADDITIONAL INFORMATION.
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- 5. SEE THE FLOOR FRAMING AND SECTIONS SHOWN ON THE FLOOR FRAMING PLANS FOR DIAPHRAGM ATTACHMENT TO MASONRY ELEVATOR SHAFT.

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### **Project Location:**

Northview Heights Midrise 250 Penfort Street Pittsburgh, PA 15214

drawing title


THIRD FLOOR SHEAR WALL PLAN

As Noted

December 3rd, 2023

**S303** 

Sheet No.

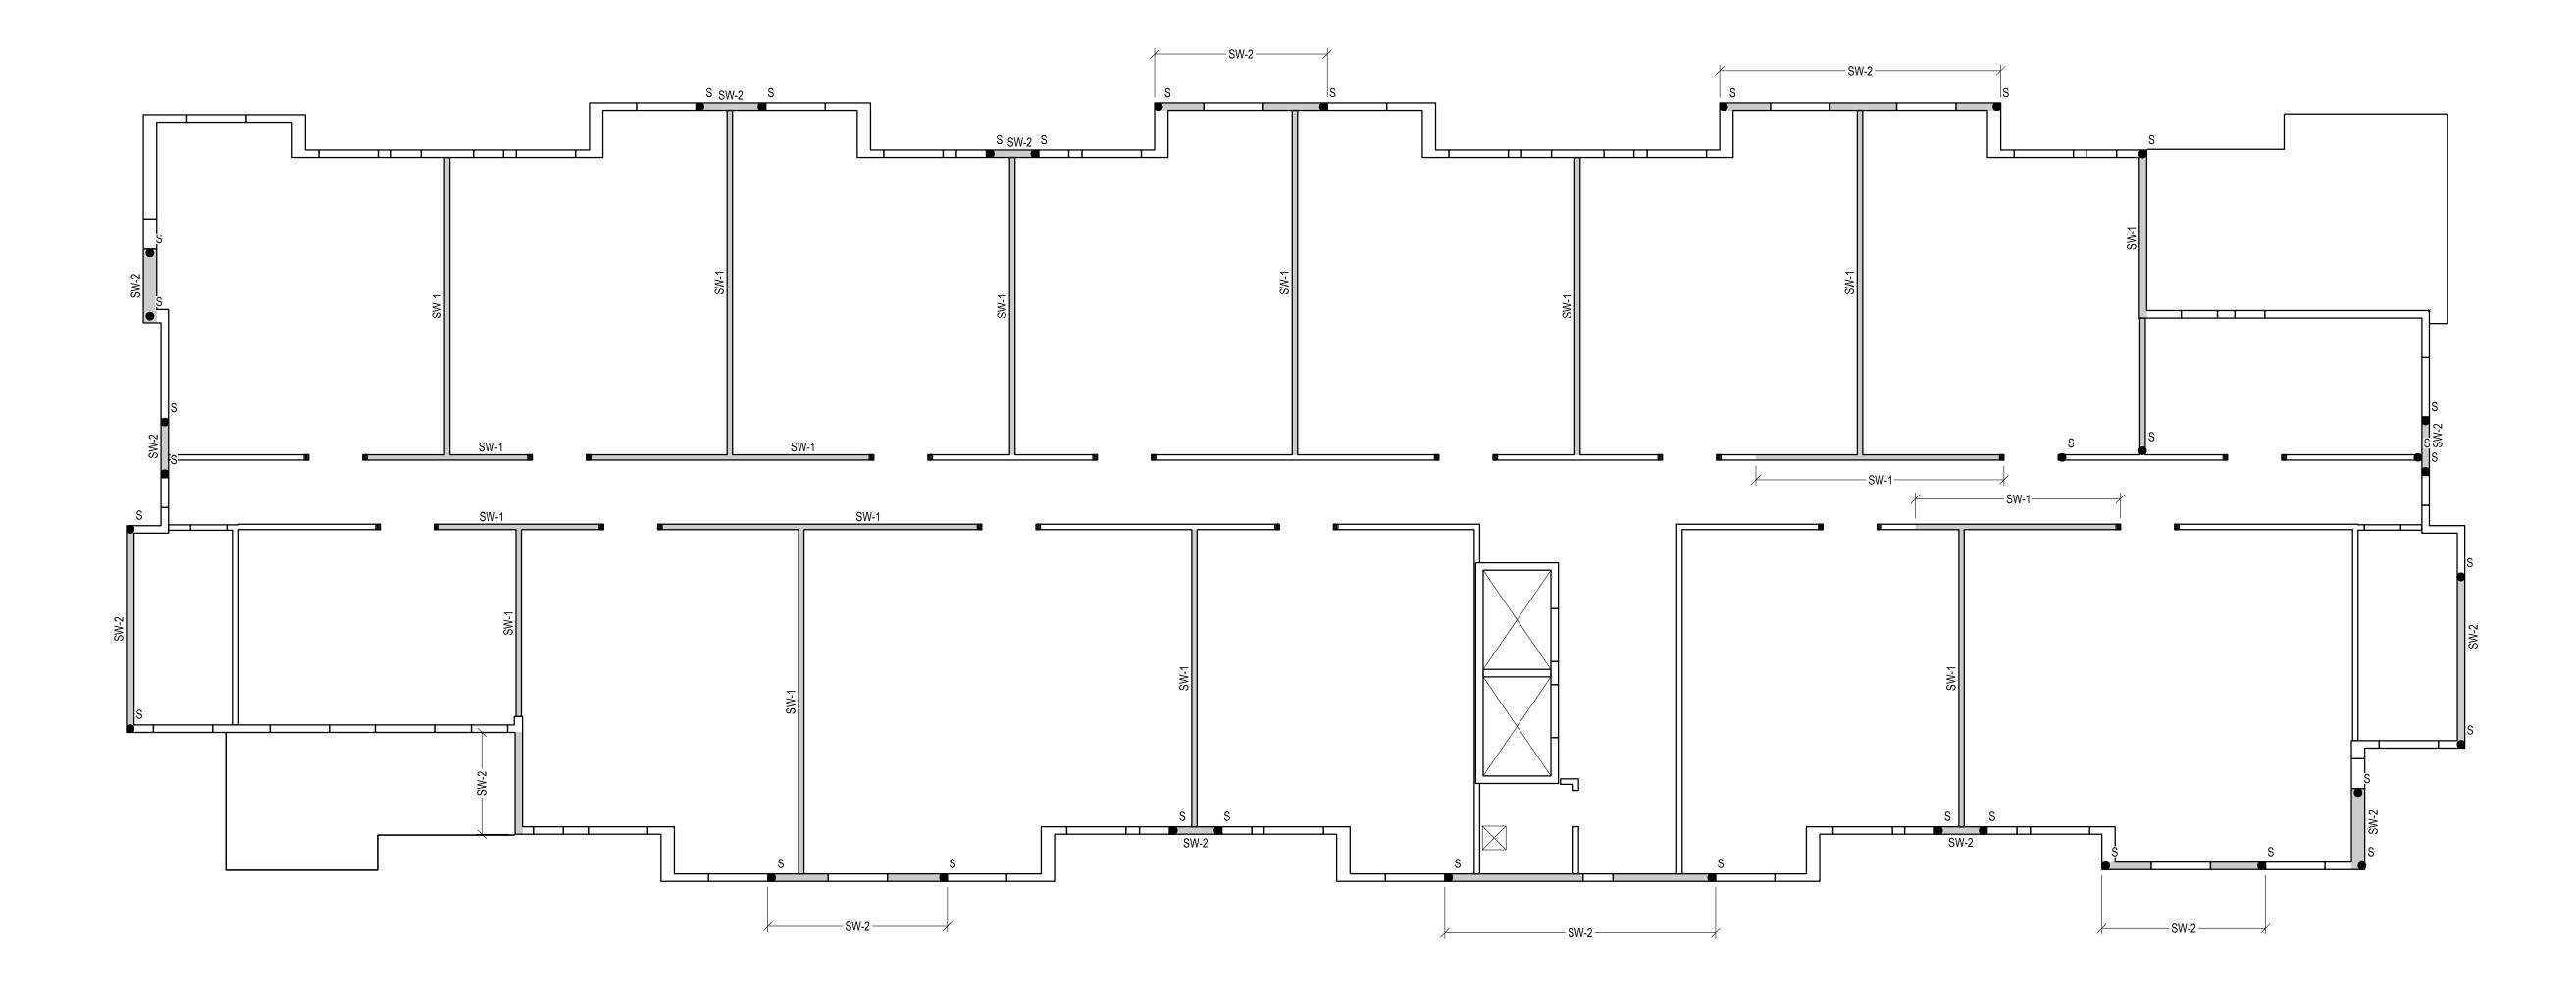

#### FOURTH FLOOR SHEAR WALL PLAN

SCALE: 1/8" = 1'-0" (SHEAR WALLS FROM FOURTH FLOOR TO THE ROOF)

#### PLAN NOTES

- SW-x

  1. SHEAR WALLS NOTED THUS INDICATE SHEAR WALLS FROM THE FOURTH FLOOR TO THE ROOF. ALL PANEL EDGES SHALL BE BLOCKED AND SHEATHING SHALL BE SECURELY FASTENED 3/8" FROM ALL PANEL EDGES. SW-X INDICATES SHEAR WALL DESIGNATION. SEE SCHEDULE ON SHEET S002 AND DETAILS ON SHEET S501 FOR ADDITIONAL INFORMATION.
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- 5. SEE THE FLOOR FRAMING AND SECTIONS SHOWN ON THE FLOOR FRAMING PLANS FOR DIAPHRAGM ATTACHMENT TO MASONRY ELEVATOR SHAFT.



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#### PROVIDENCE

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drawing title


FOURTH FLOOR SHEAR WALL PLAN


As Noted

December 3rd, 2023

**S304** 

**Sheet No.** 

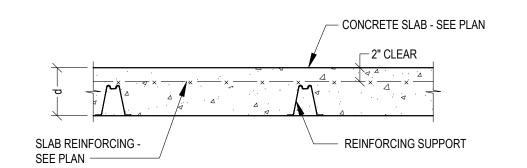

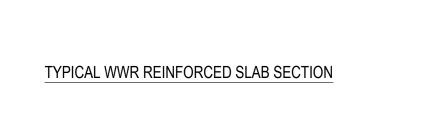

TYPICAL SAWCUT CONTRACTION JOINT

- CONCRETE SLAB - SEE PLAN


1/8" WIDE SAWCUT. CUT WHEN SLAB

IS FIRM ENOUGH SO THAT IT IS NOT

WITH JOINT FILLER IN ACCORDANCE

WITH GENERAL STRUCTURAL NOTES.

DAMAGED BY BLADE. FILL JOINT

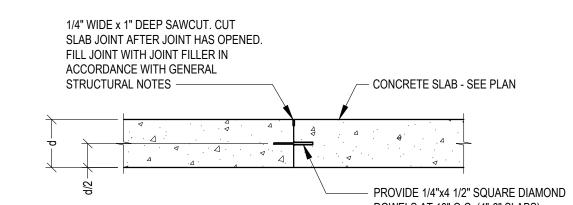

1. PLACE AND SUPPORT REINFORCEMENT PRIOR TO CONCRETE PLACEMENT TO MAINTAIN

LOCATION, DURING CONCRETE PLACEMENT, SHOWN ON THESE DETAILS AND WITHIN


TOLERANCES INDICATED IN ACI 117. REINFORCEMENT SUPPORTS SHALL CONFORM TO


SPACING SHALL NOT EXCEED 12 INCHES PERPENDICULAR TO THE DIRECTION OF SPAN.


3. IF VAPOR RETARDER/BARRIER IS PRESENT, REINFORCEMENT SUPPORTS SHALL NOT DAMAGE VAPOR RETARDER/BARRIER. PROVIDE CONTINUOUS PLATES ON BOTTOM OF BOLSTERS AND


2. WWR W4.0/D4.0 AND SMALLER SHALL HAVE CONTINUOUS SUPPORT. THE CONTINUOUS SUPPORT

TYPICAL CONSTRUCTION JOINT

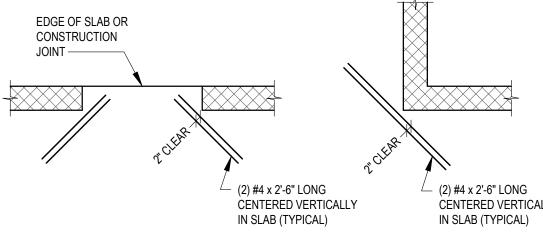

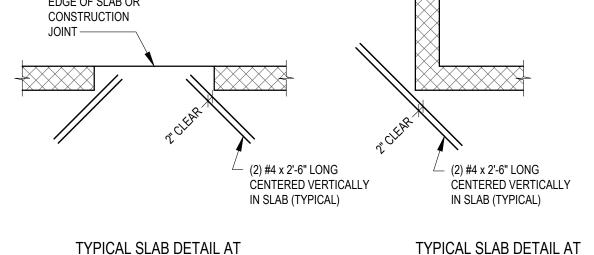


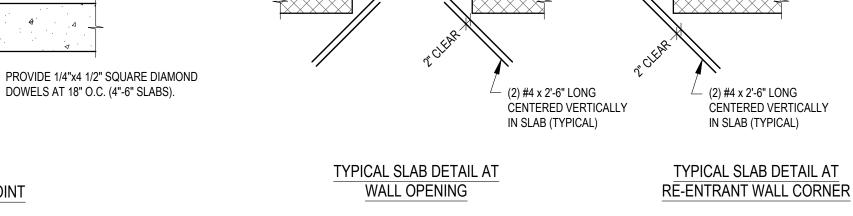


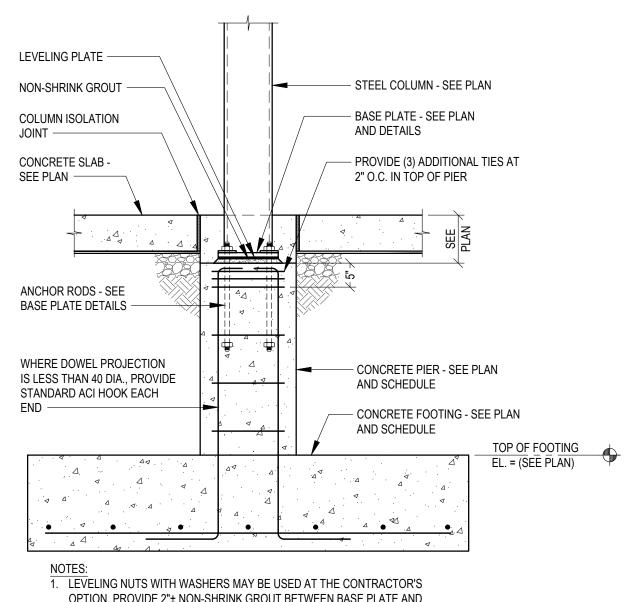

OPTION. PROVIDE 2"± NON-SHRINK GROUT BETWEEN BASE PLATE AND FOUNDATION.


- 2. COLUMN BASE AND BASE PLATE BELOW TOP OF SLAB TO RECEIVE (2) COATS BITUMINOUS PAINT OR 3" MINIMUM CONCRETE COVER.
- 3. TACK WELD NUTS TO BOTTOM OF ANCHOR RODS.

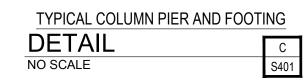


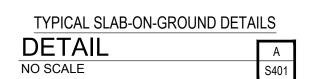



REINFORCEMENT NOTES:


PROVIDE PLATES ON INDIVIDUAL CHAIRS.

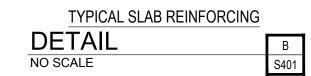

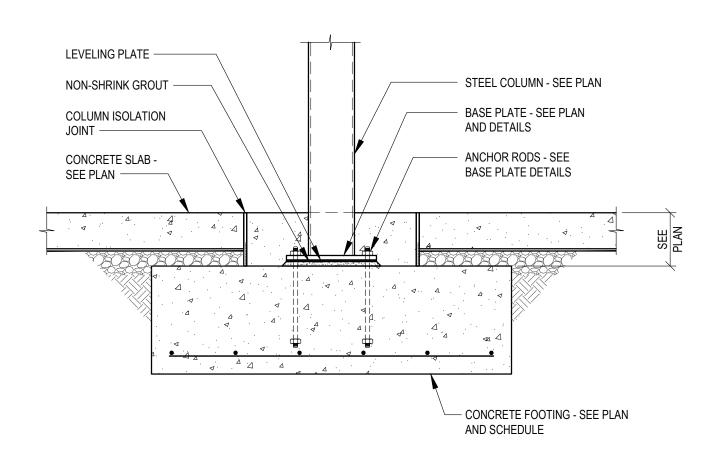


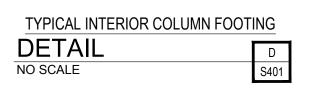


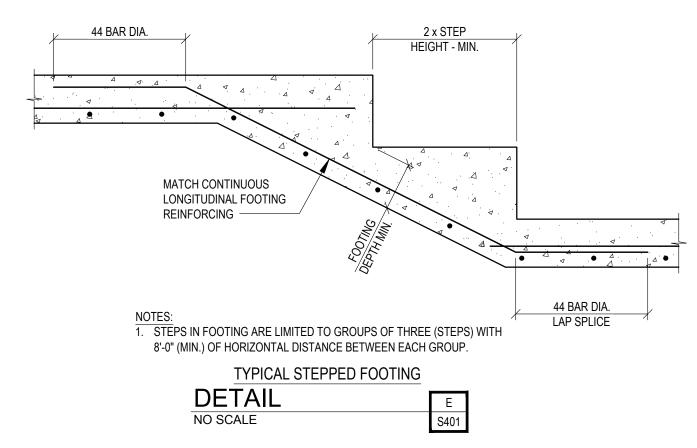


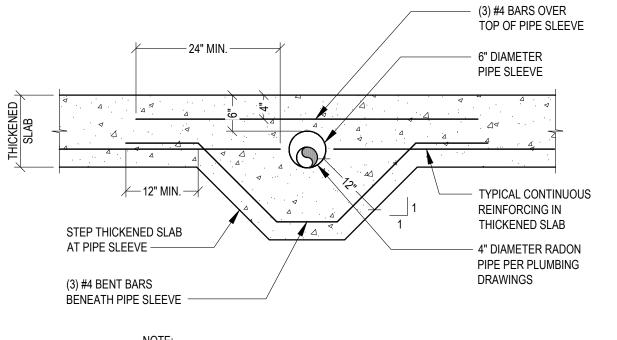



OCCURS WHERE RADON PIPING IS RUNNING PERPENDICULAR TO BEARING WALL THICKENED SLABS.

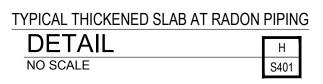

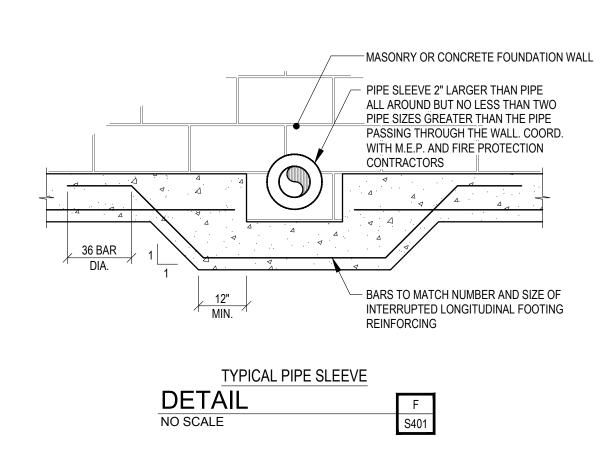

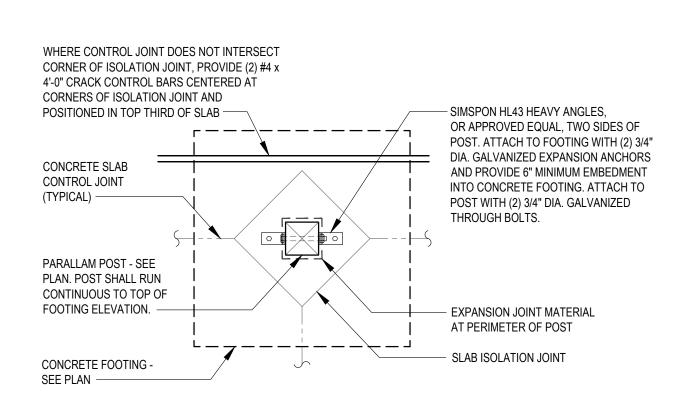

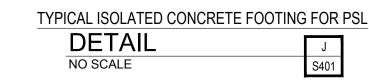

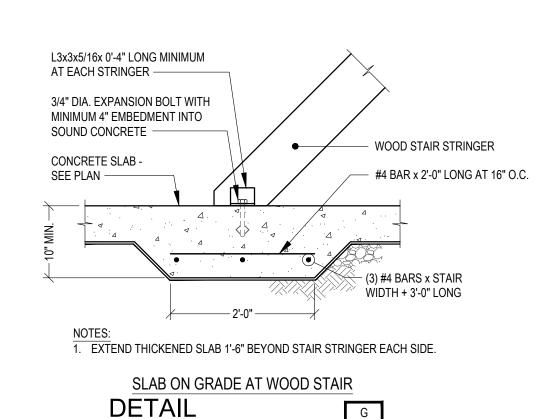

NO SCALE

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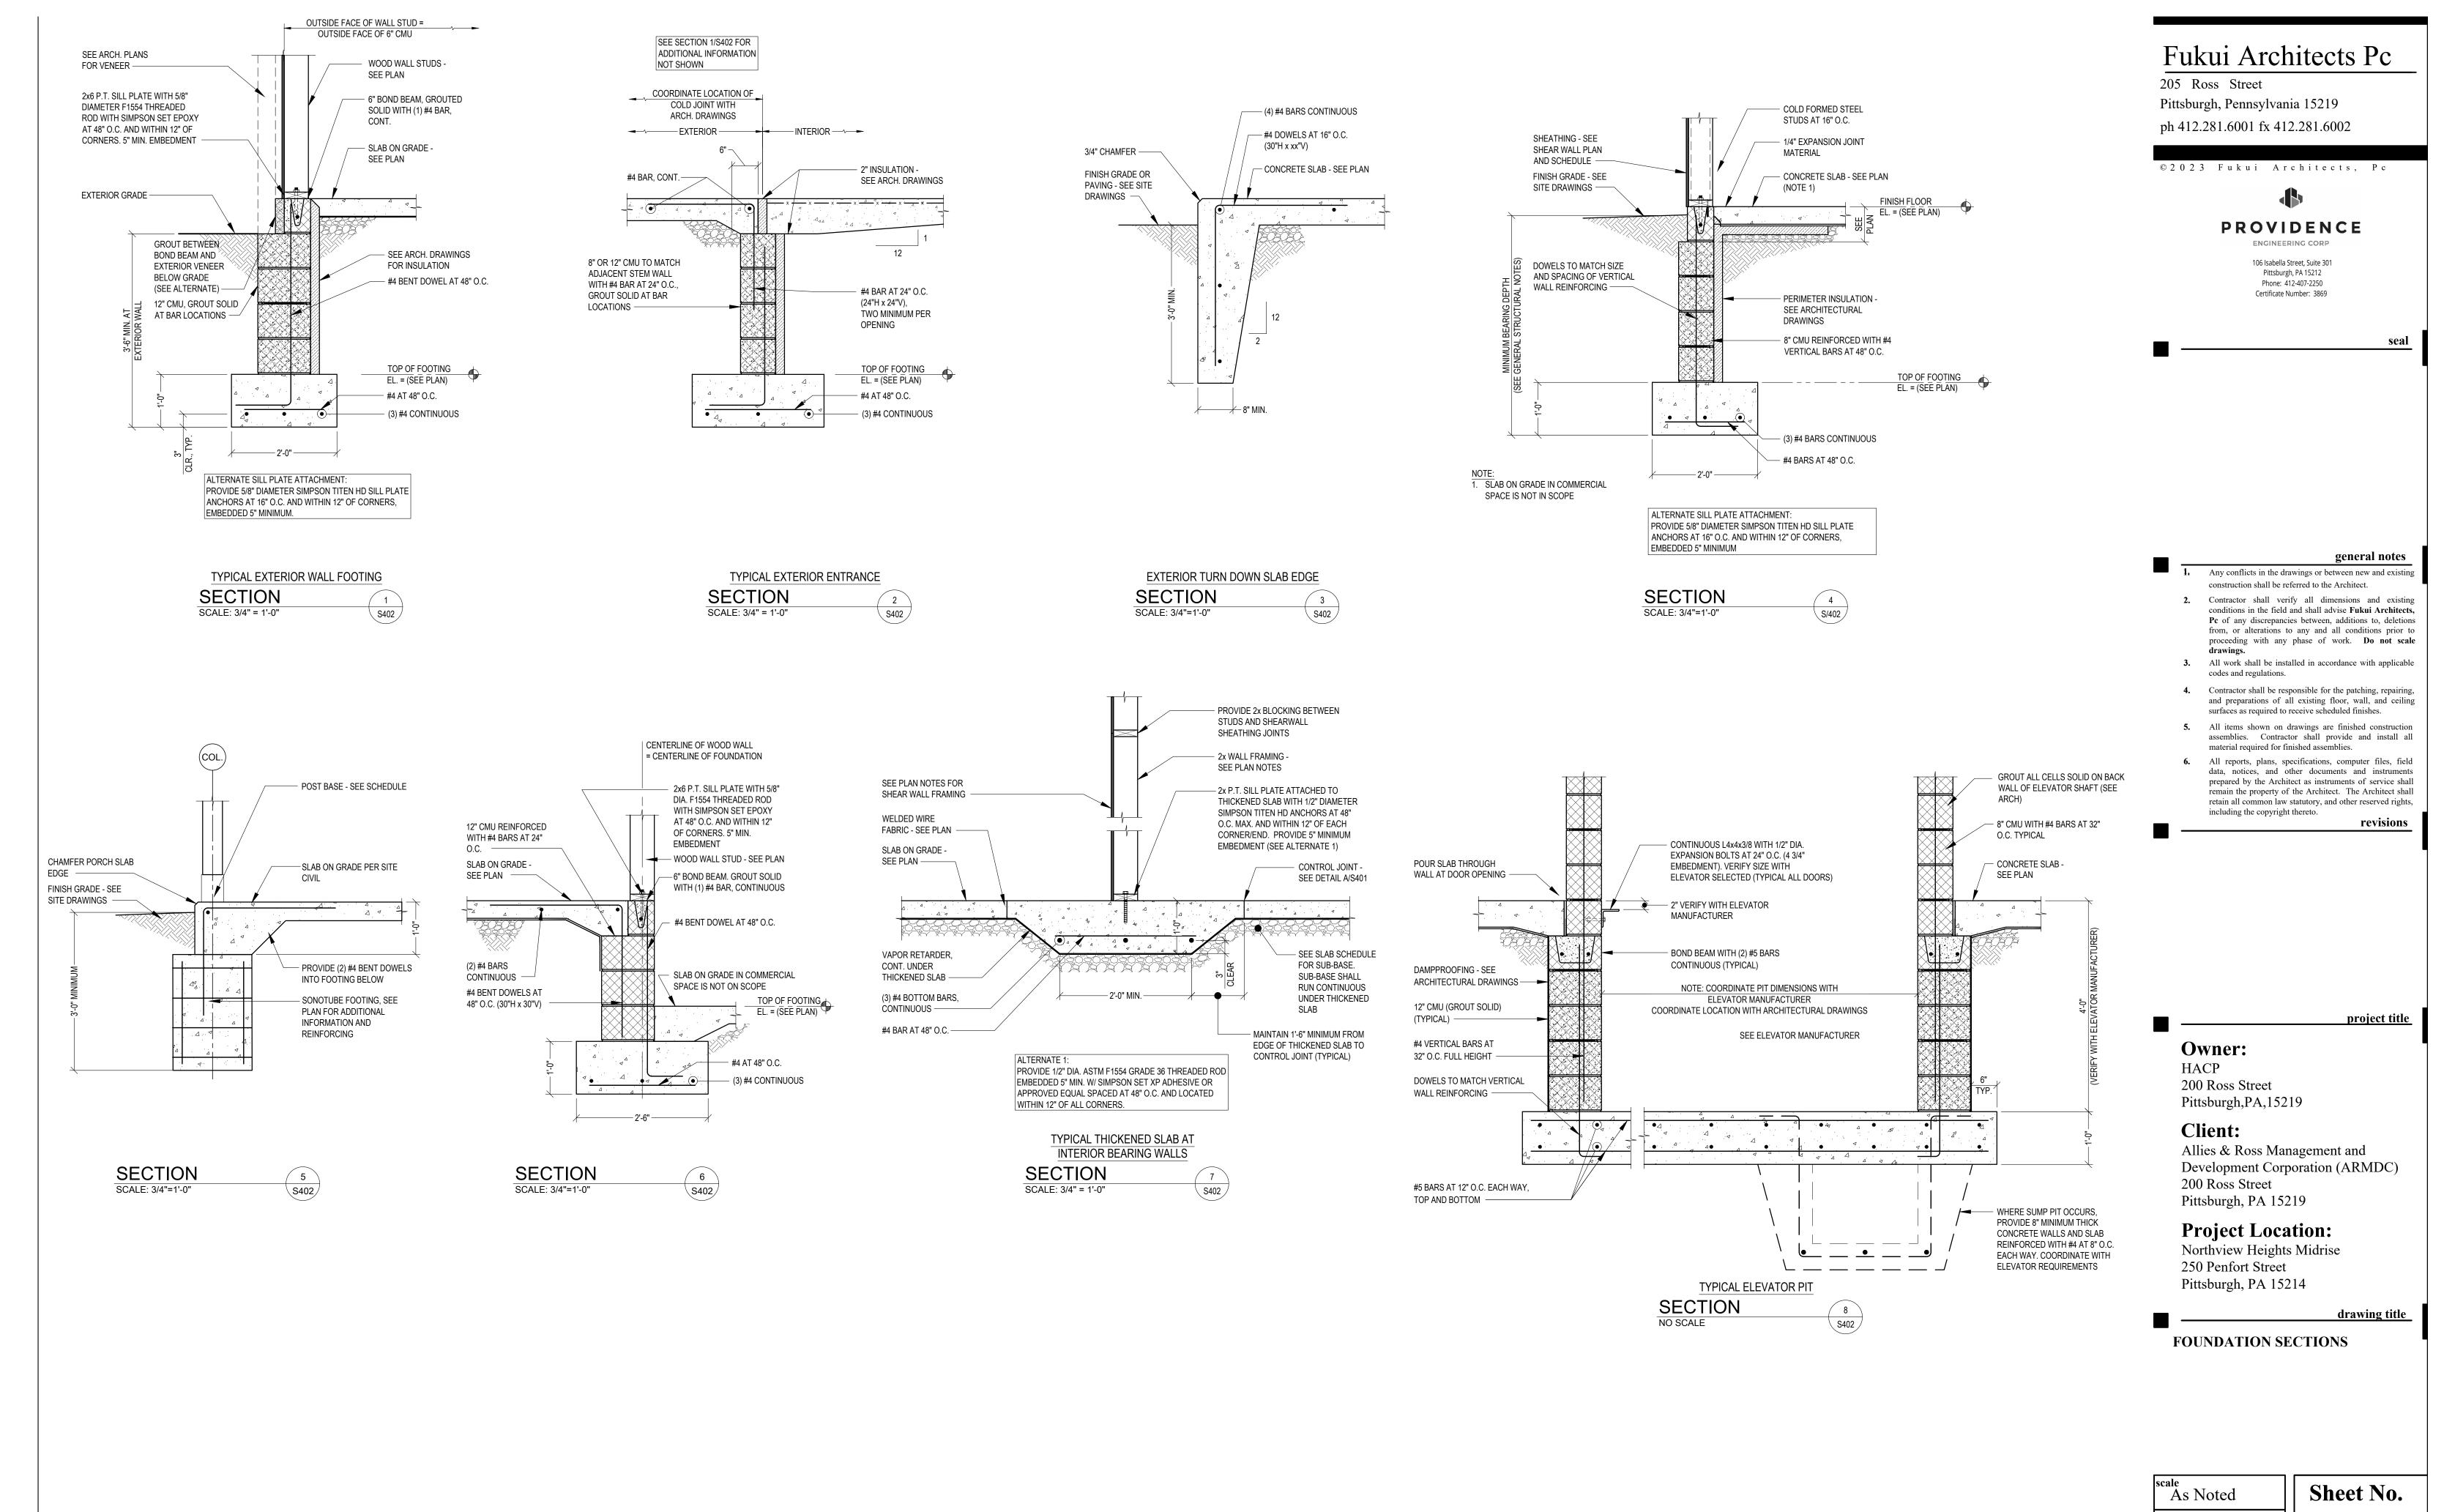
drawing title

FOUNDATION DETAILS

As Noted December 3rd, 2023

**Sheet No.** 


**S401** 



**S402**Project #2040

December 3rd, 2023

159 | 233

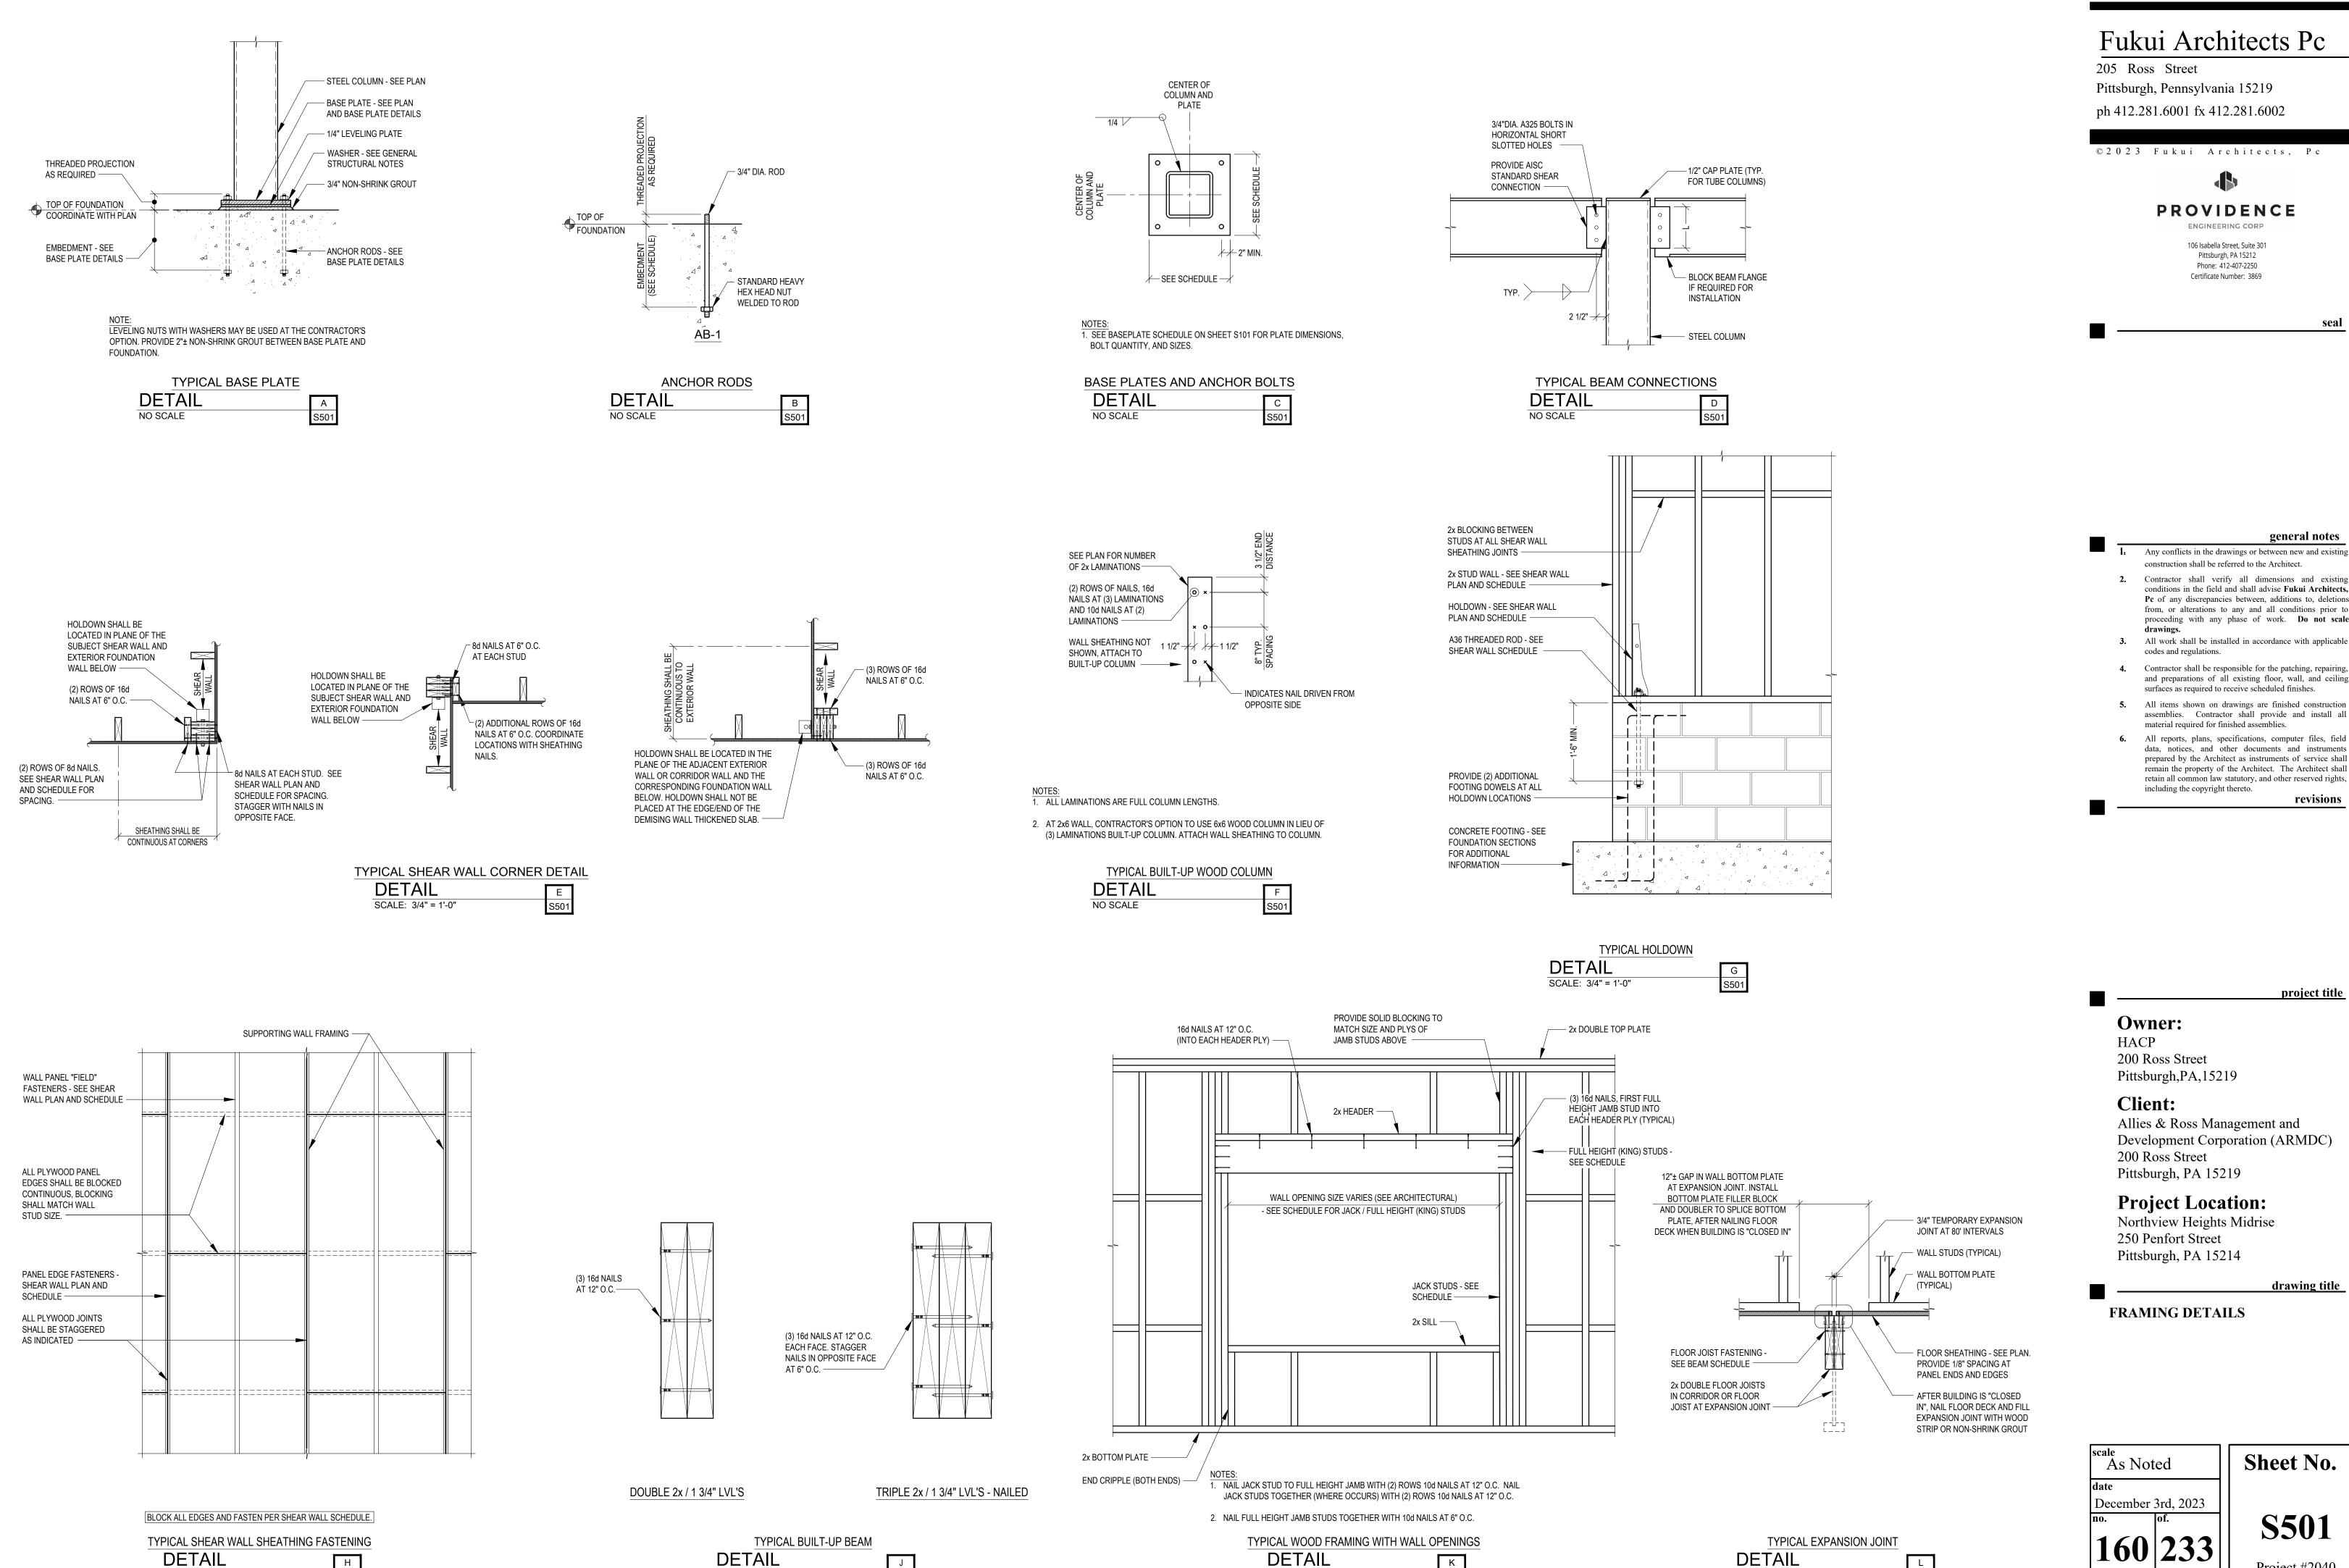

NO SCALE

NO SCALE

NO SCALE

NO SCALE

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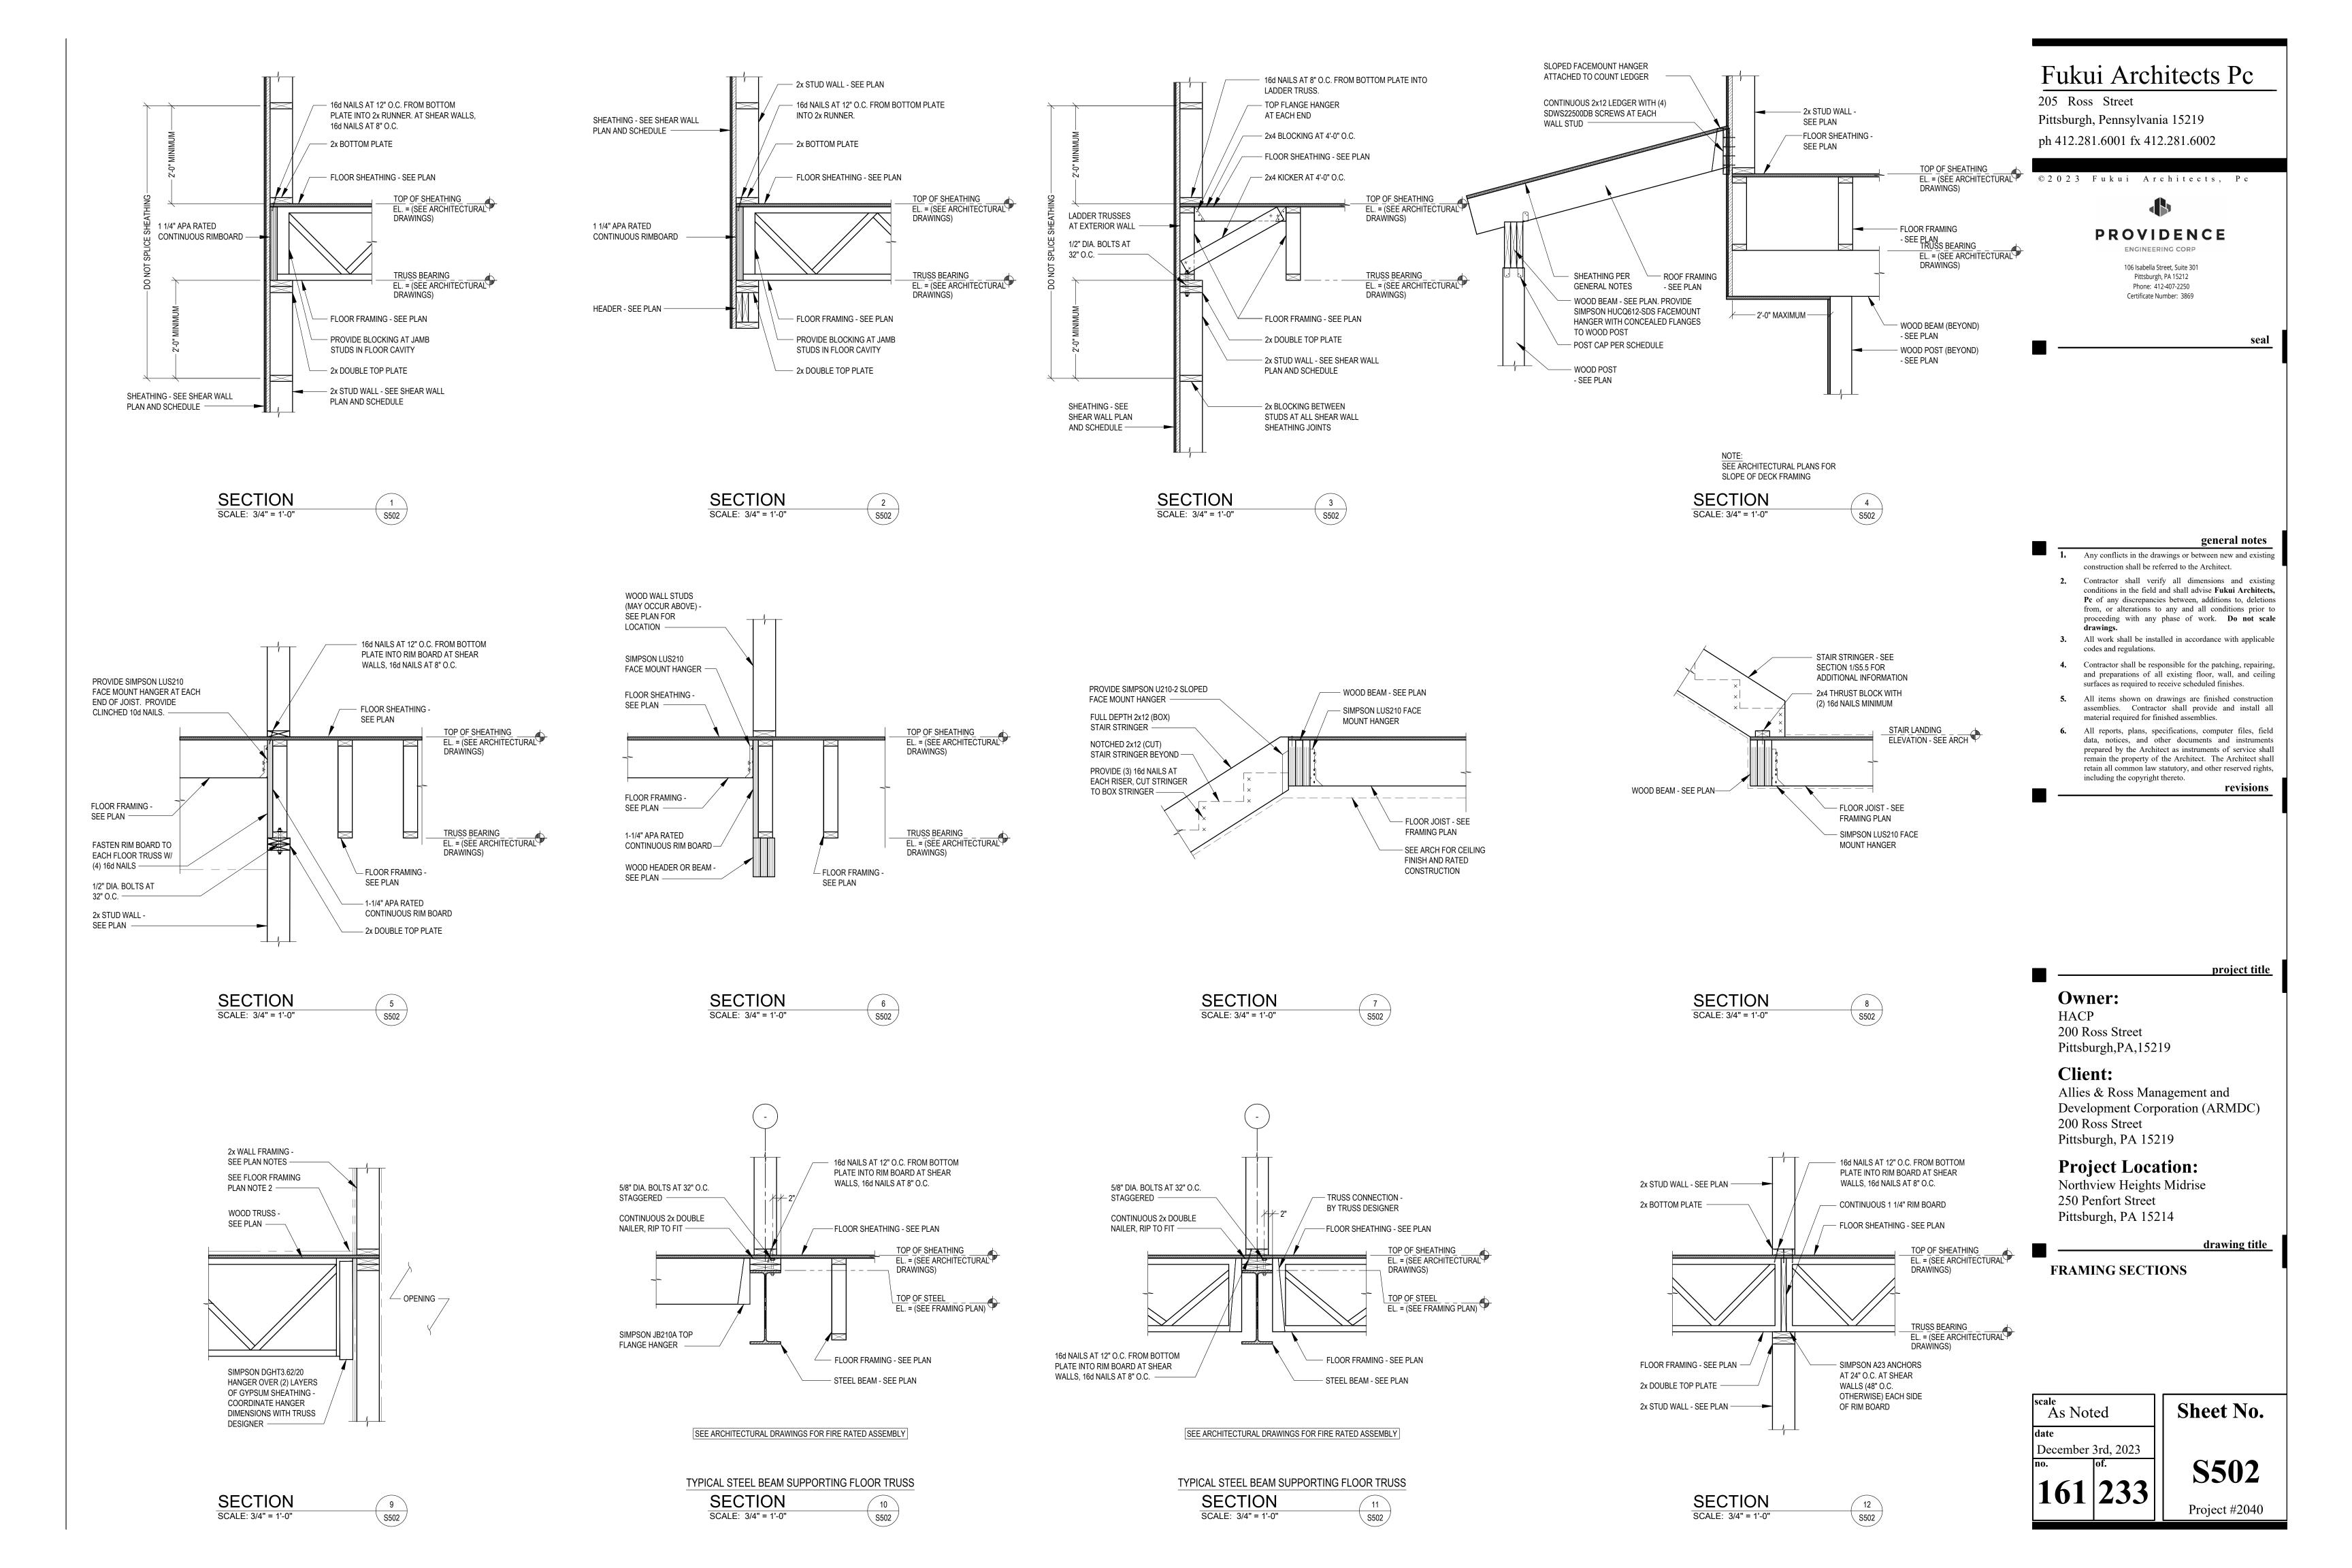
revisions


project title


Allies & Ross Management and Development Corporation (ARMDC)

drawing title

**S501** 



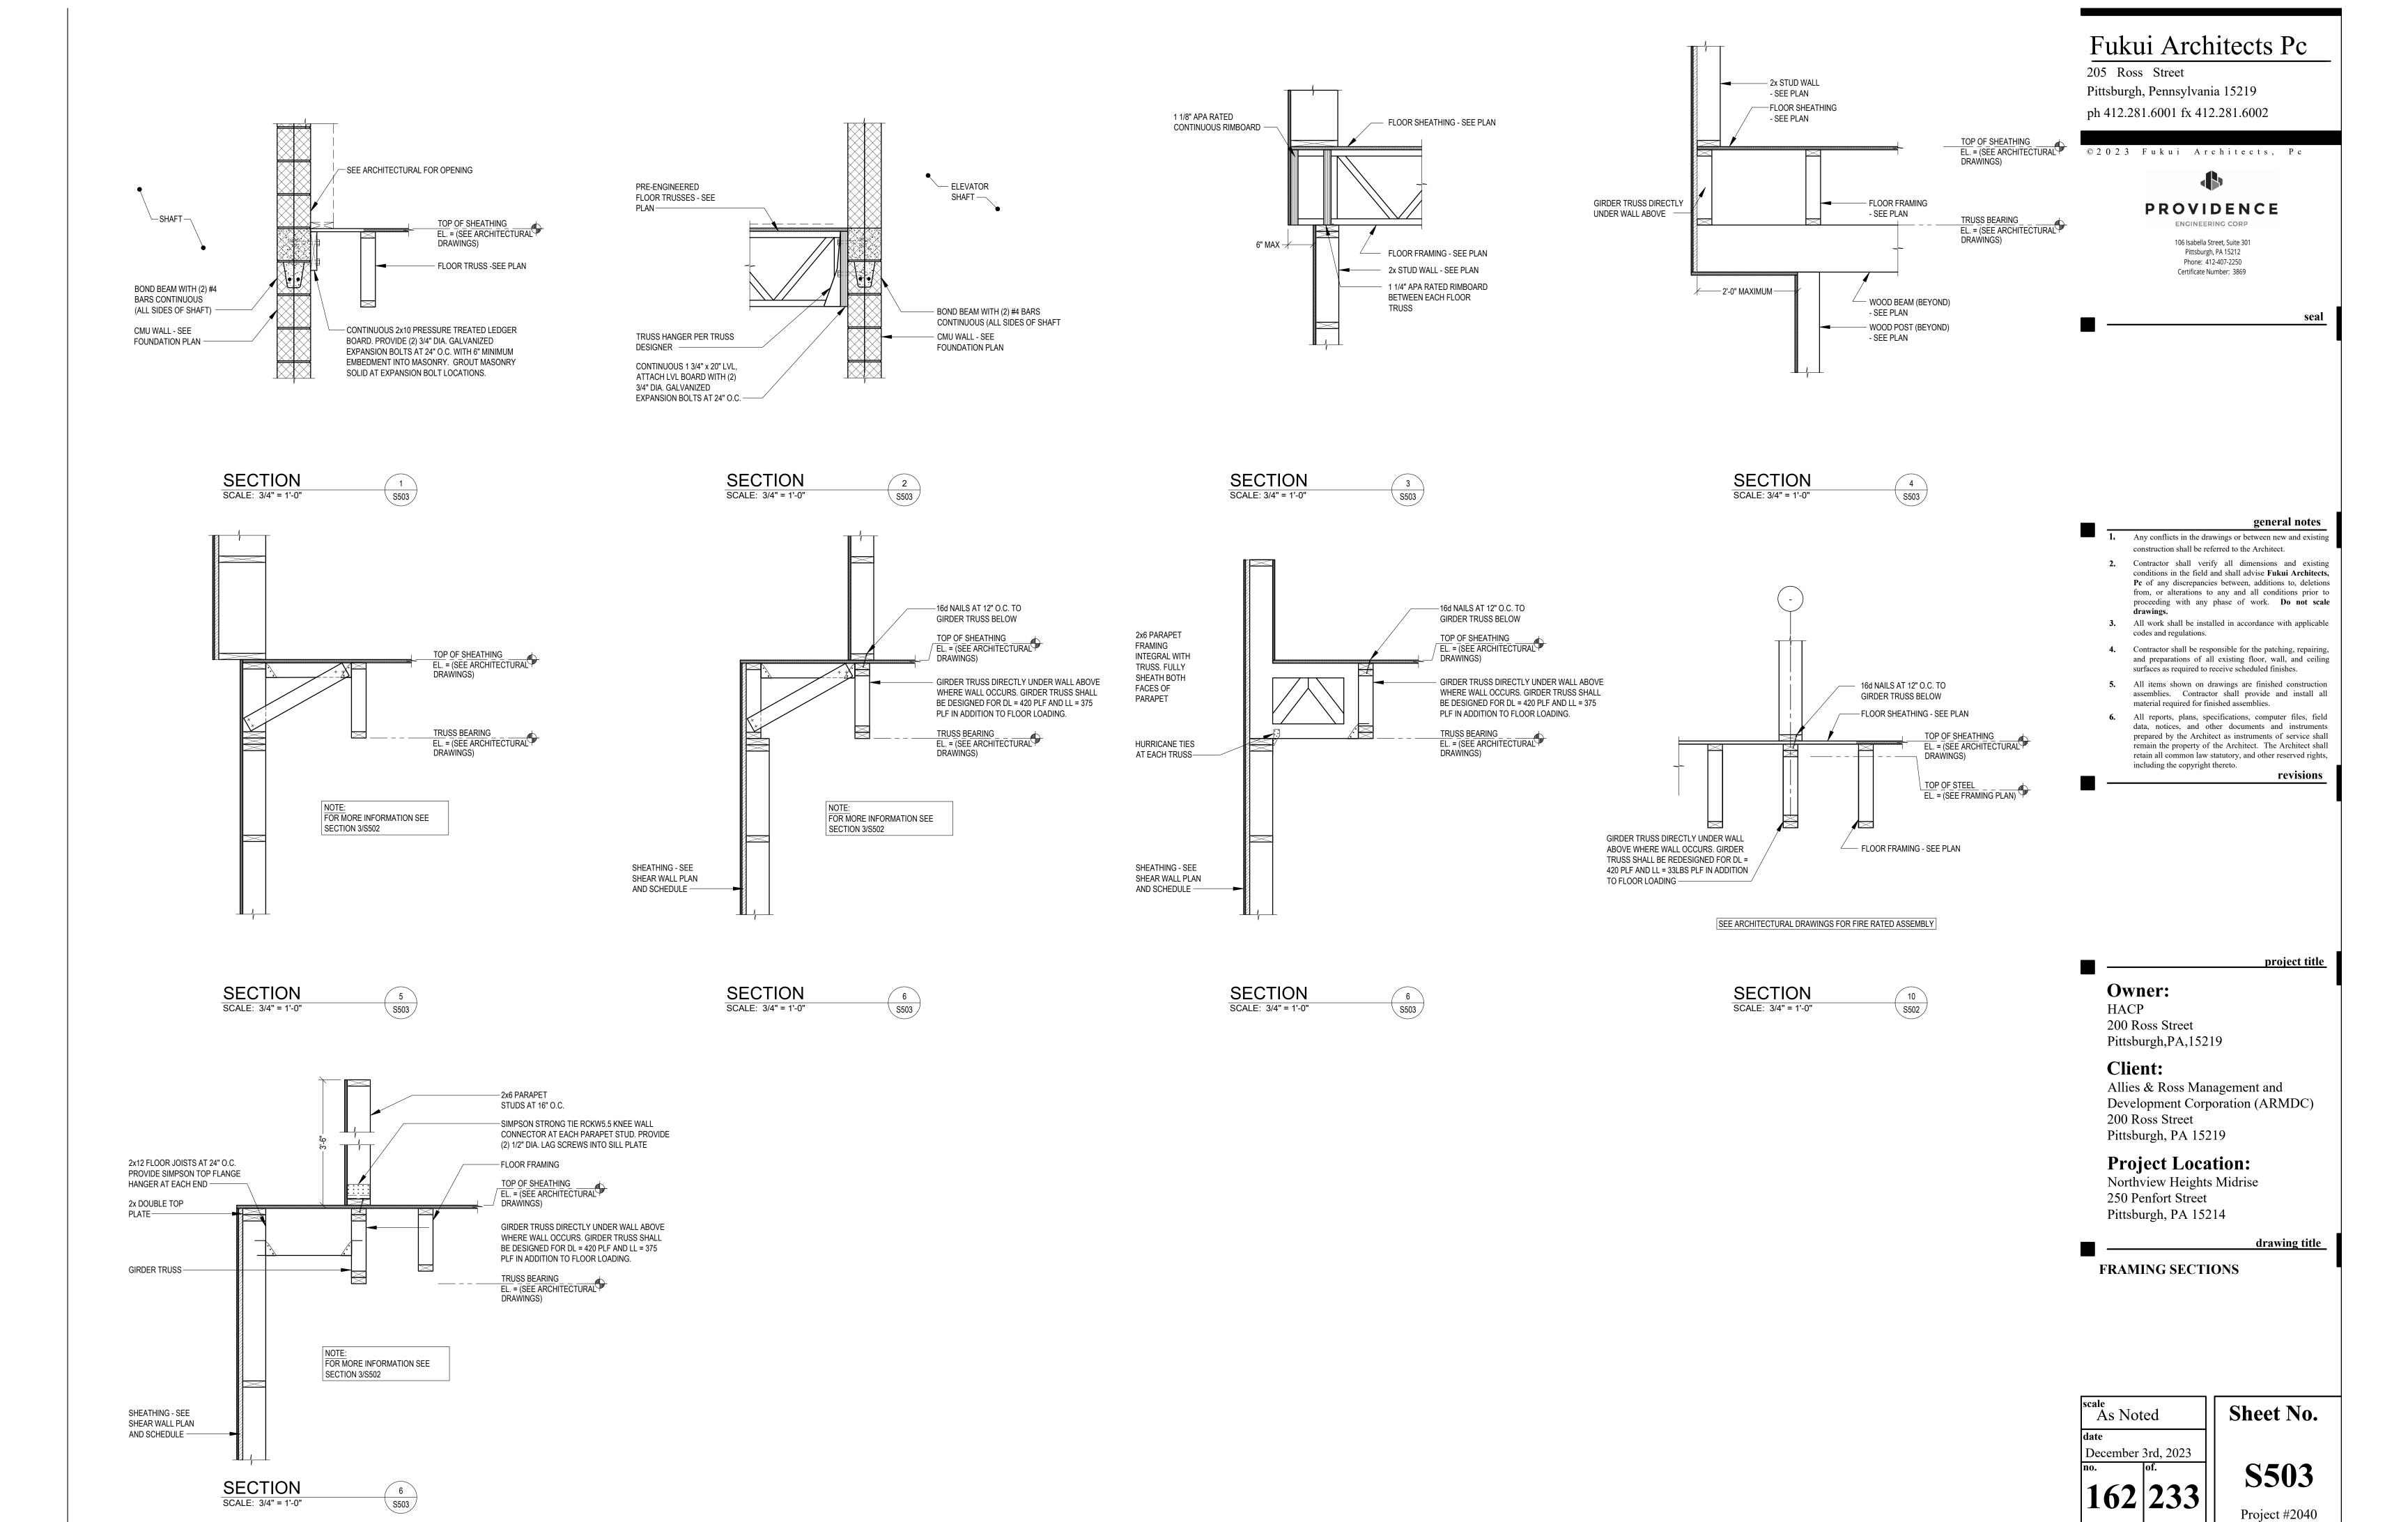

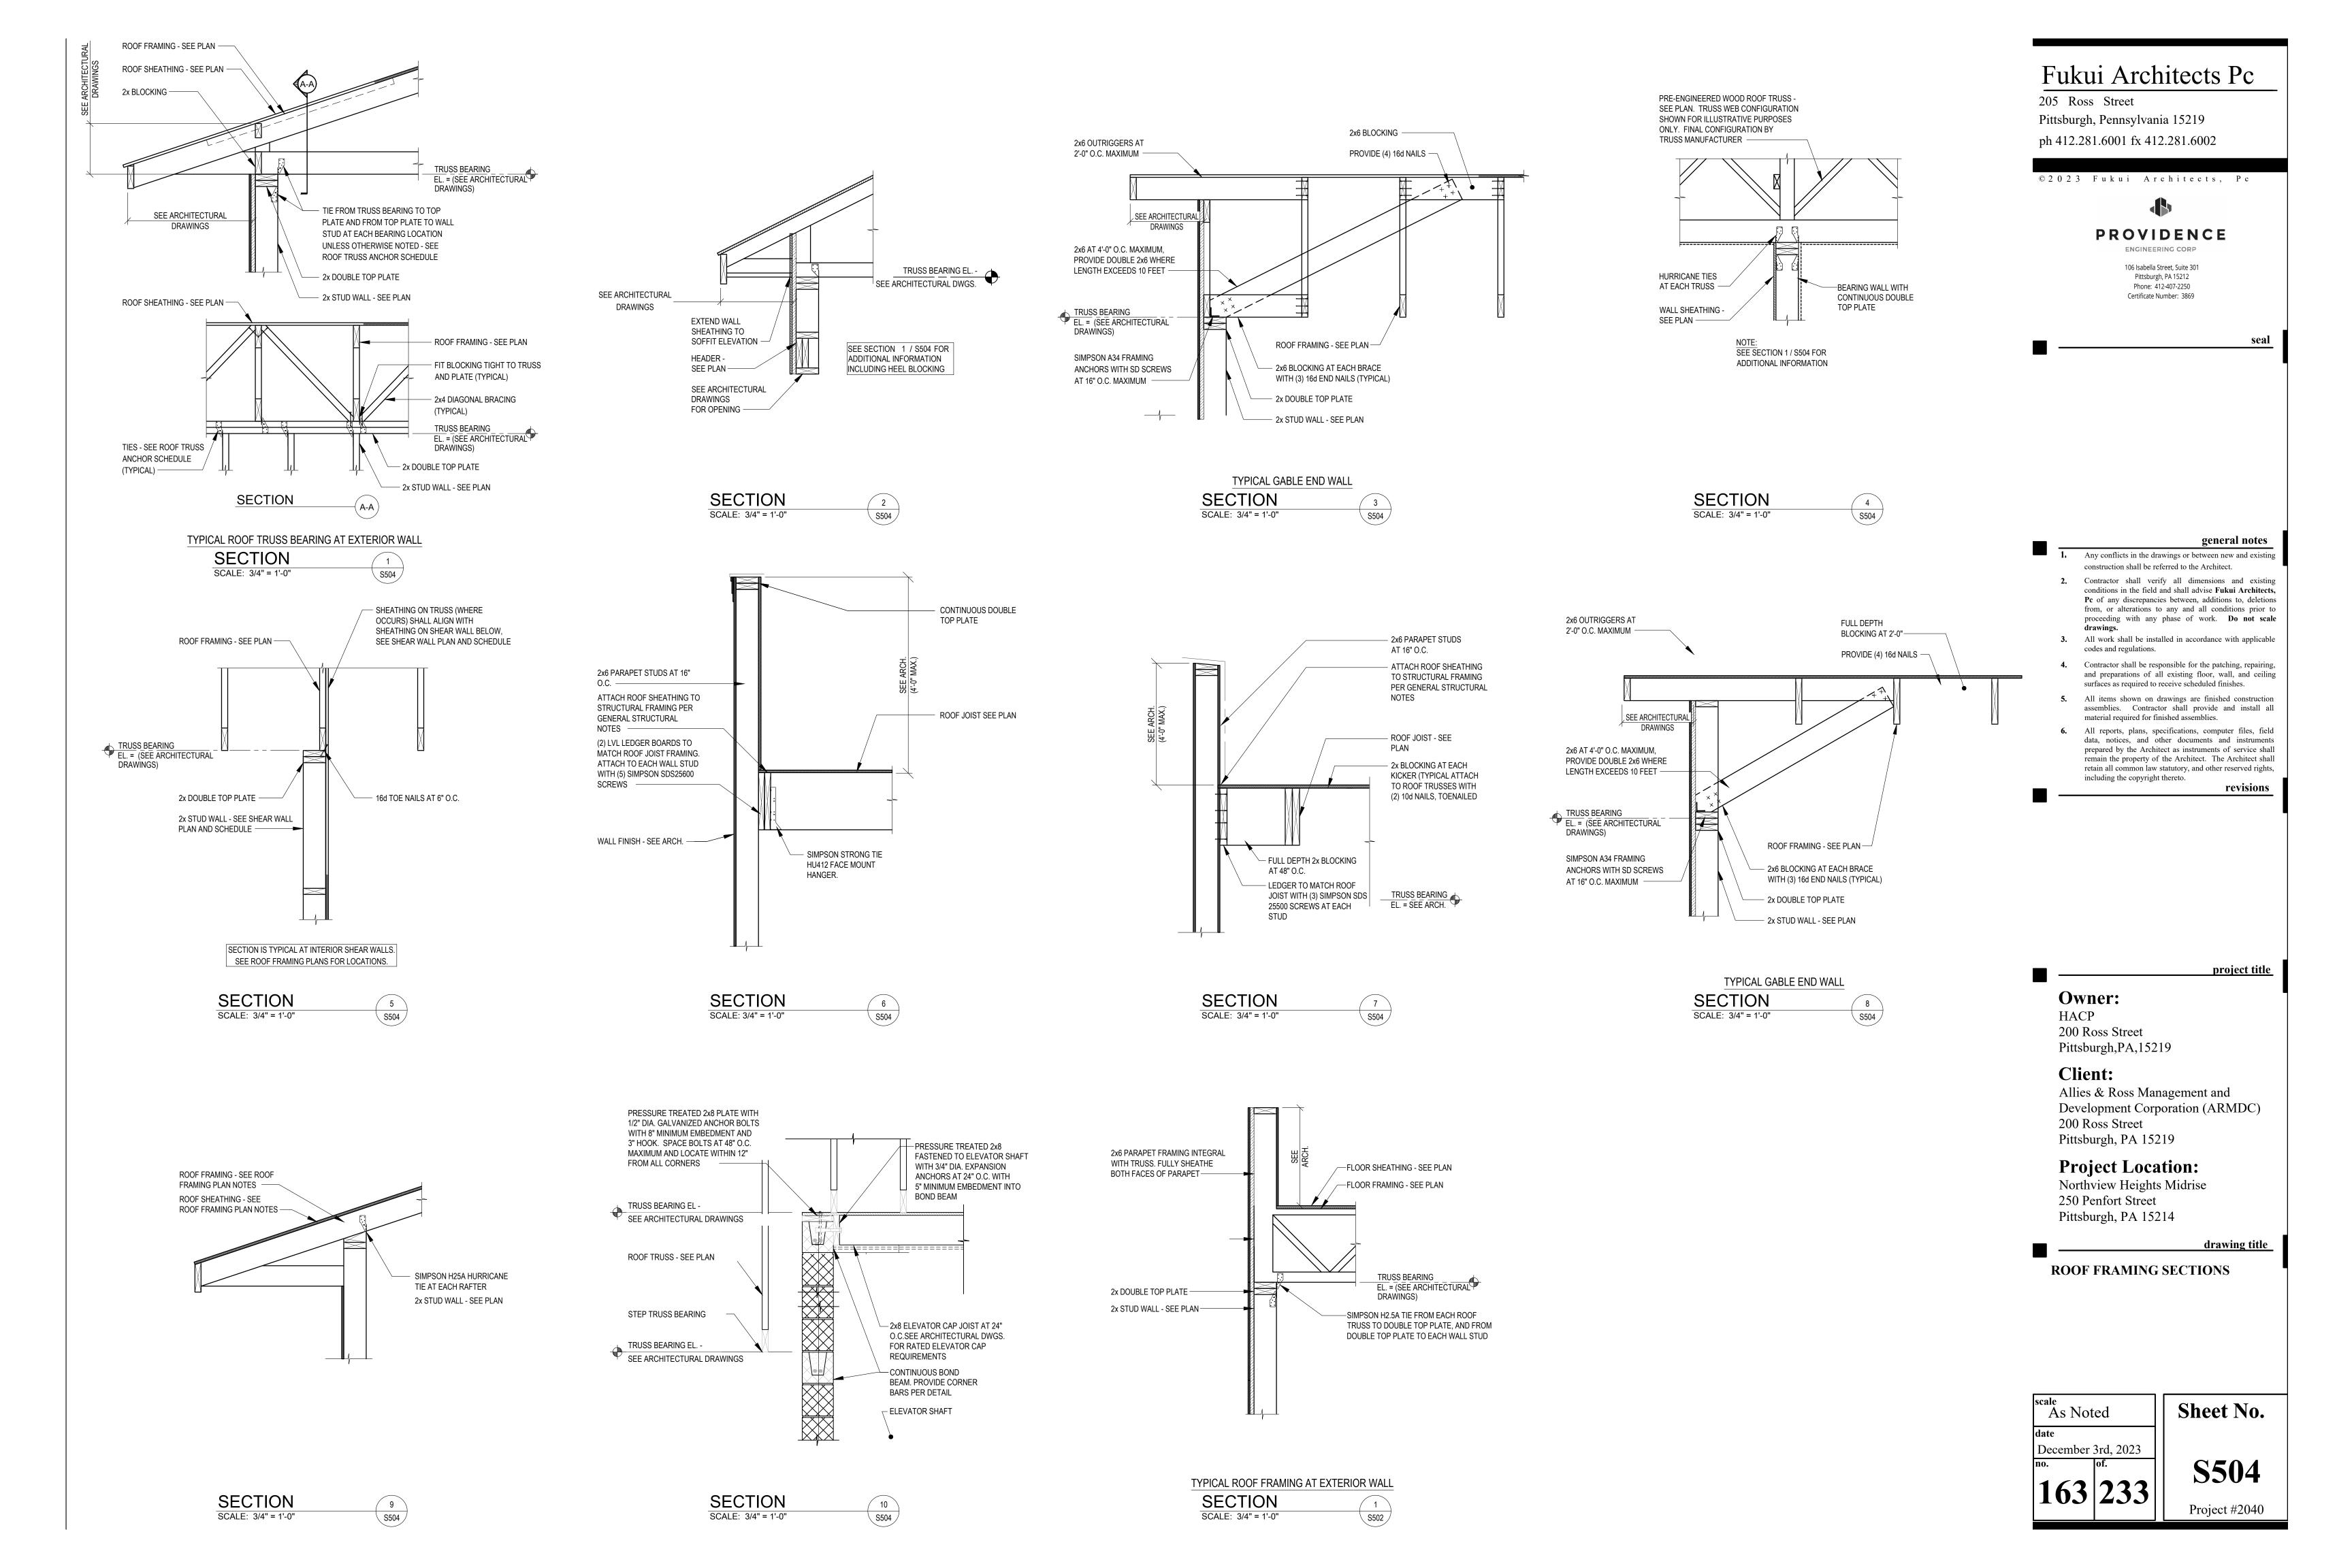

			PLUMBING SYM	BOLS AND	LEGEND			
DESCRIPTION	SYMBOL	ABBREVIATION	DESCRIPTION	SYMBOL	ABBREVIATION	DESCRIPTION	SYMBOL	ABBREVIATION
AIR ADMITTANCE VALVE	P	AV	GATE VALVE	内	GTV	REFERENCE		REF
BACK FLOW PREVENTER	77	BFP	GREASE INTERCEPTOR		Gl	SANITARY ABOVE FLOOR		SAN
BALANCING VALVE	凶	BV	HOSE BIBB	あ	НВ	SANITARY BELOW FLOOR		SAN
BALL VALVE	•	BV	HOT WATER RETURN		HWR	SANITARY TRAP	<b>−</b> √	TRAP
BATH TUB/ HANDICAP BATH TUB		BT/HBT	ICE MAKER		IM	SCHEDULE		SCHED
BRITISH THERMAL UNIT		BTU	INDIRECT CONNECTION	Ý	IC	SHOWER	$\boxtimes$	SHR
BUTTERFLY VALVE	П	BTV	KEYED NOTE	(#)		SLOPE		SL
CAPPED PIPE	E	САР	KITCHEN SINK	<u></u>	KS	SOLENOID VALVE	及	SV
CHECK VALVE	†Z	CV	LAVATORY/HANDICAP LAVATORY		LAV/HLAV	STORM DRAIN	0	SD OR RD
CLEAN OUT	•	CO OR FCO	LINT INTERCEPTOR		LI	STORM PIPING ABOVE FLOOR	<del></del> ST	ST OR RWC
CONCENTRIC REDUCER			MAXIMUM		MAX	STORM PIPING BELOW FLOOR	— —ST— —	ST
CONNECT TO EXISTING	•	СТЕ	METER	M	М	STRAINER	Ŋ	
CONTINUATION	<del></del>	CONT	MINIMUM		MIN	SUMP PUMP	SP	SP
DISHWASHER		DW	MOP BASIN		МВ	TEMPERATURE		TEMP
DOMESTIC COLD WATER		CW	NATURAL GAS	—— G ——	G	TEMPERATURE GAUGE	×	TG
DOMESTIC HOT WATER		HW	NON-POTABLE COLD WATER	—NPCW	NPCW	TRAP PRIMER	—TP—	TP
DOMESTIC WATER HEATER	Ţ	DWH	NOT TO SCALE		NTS	TRASH CHUTE		TC
DRAIN PAN		DP	OVERFLOW	-ov- <b>o</b>	OV	TRENCH DRAIN	ЧПППП	TD
ELEVATION		EL	PEX MANIFOLD	_	PM	UNION CONNECTION	1 1	UC
FILTER		FLT	PIPE DOWN	——э		URINAL/HANDICAP URINAL	û	UR/HUR
FINISHED FLOOR		FF	PIPE TEE DOWN			VACUUM BREAKER	<b>▷</b> →	VB
FLOOR DRAIN	0—	FD	PIPE UP	-0-		VENT		V
FLOOR SINK	₽	FS	PIPE UP AND DOWN			VERTICAL VALVE	——> <b>⊸</b>	GV/BV
FOOT/FEET		FT	POUNDS PER SQUARE INCH	PSI	PSI	WALL CLEAN-OUT	⊩	WCO
GARBAGE/WASTE DISPOSER		WD	PRESSURE GAUGE	<b>0</b>		WASHING MACHINE		WFA
GAS FRYER		FR	PRESSURE REDUCING VALVE	Ŕ	PRV	WATER HAMMER ARRESTOR	Q	WHA
GAS GRIDDLE		GR	PUMP	0	PUMP	WATER CLOSET/HANDICAP WATER CLOSET	2	WC/HWC
GAS SHUT OFF VALVE	<b>→</b>	GV	RECIRULATING	<b>(</b> )	RECIRC			

### **PLUMBING GENERAL NOTES:**

- 1. PIPE LOCATIONS ARE DIAGRAMMATIC. ALL PIPING TO BE RUN CONCEALED IN FINISHED SPACES, UNLESS OTHERWISE NOTED.
- 2. ALL WORK PLUMBING WORK SHALL COMPLY WITH ALL APPLICABLE CODES, LAWS, REGULATIONS, AND ACTS OF THE COMMONWEALTH OF PENNSYLVANIA, ALLEGHENY COUNTY, & ALL OTHER AUTHORITIES HAVING JURISDICTION.
- 3. THE COMPLETED INSTALLATION SHALL BE IN ACCORDANCE WITH ALL APPLICABLE INDUSTRY STANDARDS OF GOOD PRACTICE AND SAFETY, AND THE MANUFACTURER'S STRICTEST RECOMMENDATIONS FOR EQUIPMENT AND PRODUCT APPLICATION AND INSTALLATION.
- 4. THE CONTRACTOR SHALL MAINTAIN ALL MANUFACTURER'S RECOMMENDED AND CODE REQUIRED SERVICE CLEARANCES FOR ALL FIXTURES AND EQUIPMENT. REFER TO ARCHITECTURAL PLANS FOR EXACT LOCATIONS AND MOUNTING HEIGHTS OF PLUMBING FIXTURES.
- 5. ALL WORK SHOWN IS A DIAGRAMMATIC REPRESENTATION OF DESIGN INTENT AND CONDITIONS REASONABLY INTERPRETED FROM THE EXISTING VISIBLE CONDITIONS AND/OR DRAWINGS AND INFORMATION PROVIDED BY THE OWNER, BUT CANNOT BE GUARANTEED BY THE ENGINEER.
- 6. BEFORE SUBMITTING A BID, THE CONTRACTOR SHALL CONDUCT AN ON SITE INSPECTION TO VERIFY EXISTING CONDITIONS. THIS INCLUDES DEPTH OF ALL BELOW GRADE PIPING, THE LOCATION AND SIZE OF ALL UTILITIES. COORDINATION WITH EXISTING SERVICES, INCLUDING THOSE OF OTHER TRADES, IS REQUIRED AND SHALL BE PROVIDED AT NO ADDITIONAL COST. ANY MAJOR DISCREPANCIES SHALL BE REPORTED TO THE ENGINEER.
- 7. THE CONTRACTOR SHALL COORDINATE ALL CONNECTION REQUIREMENTS AND LOCATIONS FOR OWNER SUPPLIED EQUIPMENT WITH EQUIPMENT SUPPLIER/INSTALLER.
- 8. THE CONTRACTOR SHALL COORDINATE ALL WORK PROCEDURES WITH THE REQUIREMENTS OF THE ARCHITECT, ENGINEER, OWNER, TENANT, AND/OR AUTHORITIES HAVING JURISDICTION.
- 9. THE CONTRACTOR SHALL BE RESPONSIBLE FOR ALL UNION AND EQUAL OPPORTUNITY STANDARDS OR REQUIREMENTS WHERE APPLICABLE.
- 10. FILING OF PERMIT FOR PLUMBING WORK FOR THIS SPACE AS WELL AS PAYMENT OF ALL APPLICABLE FEES AND PREPARATION OF ALL DRAWINGS REQUIRED FOR FILING PLANS AND PERMITS SHALL BE INCLUDED. COPIES OF ALL EXECUTED PERMITS AND DRAWINGS SHALL BE FORWARDED TO THE ENGINEER FOR RECORD.
- 11. MINOR DETAILS NOT SHOWN OR SPECIFIED, BUT NECESSARY FOR THE PROPER AND ACCEPTABLE CONSTRUCTION, INSTALLATION OR OPERATION OF ANY PART OF THE WORK AS DETERMINED BY THE ENGINEER SHALL BE INCLUDED IN THE WORK AS IF IT WERE SPECIFIED OR INDICATED ON THE
- 12. ALL SANITARY PIPING SHALL START AT A MINIMUM OF 18" BELOW SLAB. ALL SANITARY AND STORM PIPING SHALL BE PITCHED AT 1/8" PER FOOT, UNLESS OTHERWISE NOTED.
- 13. CLEANOUTS SHALL BE PROVIDED AS INDICATED ON DRAWINGS AND AT ALL LOCATIONS REQUIRED BY CODE; AT 100' INTERVALS, AT ALL BASE OF STACKS, AT CHANGE OF DIRECTION, ETC.
- 14. THE CONTRACTOR SHALL BE RESPONSIBLE FOR THE PROTECTION OF ALL EXISTING AND NEW CONDITIONS AND MATERIALS WITHIN THE PROPOSED CONSTRUCTION AREA. ANY DAMAGE CAUSED BY, OR DURING THE EXECUTION OF THE WORK IS THE RESPONSIBILITY OF THE CONTRACTOR AND SHALL BE REPAIRED TO THE ENGINEER'S SATISFACTION.
- 15. THE CONTRACTOR SHALL INCLUDE IN THEIR BID ALL HANGERS, INSERTS, TESTING, TOOLS, SUPERVISION, LABOR, COORDINATION, MATERIALS, EQUIPMENT, REMOVALS, CAPPING, PATCHING, DISPOSAL, AND OTHER NECESSARY ITEMS TO PROVIDE THE PLUMBING INSTALLATION.
- 16. ANY DAMAGED INSULATION ON ANY EXISTING PIPING TO BE REUSED WITHIN THE AREA UNDER CONSTRUCTION SHALL BE REPAIRED WITH THE SAME TYPE OF INSULATION AS EXISTING, EXCLUDING
- 17. EQUIPMENT, MATERIALS AND WORKMANSHIP PROVIDED UNDER THIS CONTRACT SHALL BE GUARANTEED BY THE CONTRACTOR FOR A PERIOD OF ONE YEAR FROM THE DATE OF COMPLETION OF THE PROJECT. THE CONTRACTOR SHALL KEEP THE WORK IN GOOD REPAIR FOR ONE YEAR AFTER THE DATE OF FINAL APPROVAL. THE CONTRACTOR SHALL AT HIS OWN EXPENSE, CORRECT AND REPAIR PROMPTLY ANY AND ALL BREAKS, FAILURES OR WEAR DUE TO FAULTY MATERIALS, WORKMANSHIP OR EQUIPMENT, AND ALL SETTLEMENTS OF SURFACE THAT MAY OCCUR DURING THAT PERIOD.
- 18. SLEEVE AND SEAL ALL PIPE PENETRATIONS OF WALLS AND FLOORS. SLEEVES THROUGH FLOORS SHALL EXTEND 2" ABOVE FLOOR, BE GROUTED INTO PLACE AND WATERPROOFED. PIPING THROUGH EXTERIOR WALLS SHALL BE SLEEVED AND SEALED WEATHER TIGHT WITH SILICONE CAULK.
- 19. ANY PENETRATION THROUGH FIRE RATED PARTITIONS, FLOORS, OR CEILINGS SHALL BE STEEL SLEEVED AND SEALED WITH 3M BRAND U.L. RATED FIRE BARRIER CAULK OR AN APPROVED EQUAL.
- 20. CUTTING OF ROOF AND FLASHING OF PIPE CURBS, SANITARY VENT THROUGH ROOF, ETC., SHALL BE COORDINATED WITH AND PAID FOR BY THIS CONTRACTOR, ALL VENT OUTLETS SHALL BE A MINIMUM OF 10'-0" AWAY FROM ANY AIR INTAKES ON HVAC EQUIPMENT.
- 21. CONTRACTOR SHALL PROVIDE ASSE 1070 ANTI-SCALD VALVES ON ALL PUBLIC LAVATORIES.
- 22. PROVIDE SHUT-OFF VALVES AT ALL BRANCH LINES, EQUIPMENT, TEMPERING VALVES, PUMPS, ETC.
- 23. ALL SHUT-OFF VALVES SHALL BE ACCESSIBLE. PROVIDE ACCESS DOORS FOR SHUT-OFF VALVES
- 24. THE CONTRACTOR SHALL, AS NECESSARY, PROVIDE EXPANSION LOOPS TO ACCOMMODATE FOR EXPANSION AND CONTRACTION OF PIPING.
- 25. ALL DOMESTIC COLD, HOT, AND TEMPERED WATER PIPING AND RAIN CONDUCTORS ARE TO BE
- INSULATED WITH RIGID FIBERGLASS INSULATION WITH TYPE 'ASJ' JACKET. 26. ALL FIXTURES REQUIRING VACUUM BREAKERS SHALL BE EQUIPPED WITH INTEGRAL VACUUM
- 27. THE PLUMBER IS RESPONSIBLE FOR ALL LOW VOLTAGE WIRING FOR EQUIPMENT INSTALLED UNDER THEIR CONTRACT. ELECTRICIAN IS RESPONSIBLE FOR POWER WIRING ONLY.
- 28. NO PIPING SHALL BE RUN OVER ELECTRICAL PANELS.
- 29. THE CONTRACTOR SHALL TEST AND REMEDIATE AS FOLLOWS:
- 29.1. TEST WATER FROM DWELLING UNIT FAUCETS FOR THE PRESENCE OF LEAD.
- 29.1.1. IF RESULTS ARE ABOVE 0, INSTALL NSF/ANSI 58 OR NSF/ANSI 52 FILTERS IN ALL UNITS AND REPLACE OVER TIME PER MANUFACTURER'S INSTRUCTIONS.
- 29.1.2. IF RESULTS ARE ABOVE 10 PPB, REPLACE ALL FIXTURES WITH NSF 61 CERTIFIED FIXTURES.

PLUMBING FIXTURES

SANITARY FIXTURE UNITS: 610 DOMESTIC WATER FIXTURE UNITS: 342

### Fukui Architects Pc

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- 3. All work shall be installed in accordance with applicable codes and regulations.

Contractor shall be responsible for the patching, repairing,

- and preparations of all existing floor, wall, and ceiling surfaces as required to receive scheduled finishes. 5. All items shown on drawings are finished construction
- assemblies. Contractor shall provide and install all material required for finished assemblies.
- All reports, plans, specifications, computer files, field data, notices, and other documents and instruments prepared by the Architect as instruments of service shall remain the property of the Architect. The Architect shall retain all common law statutory, and other reserved rights, including the copyright thereto.

revisions

**project title** 

#### Owner: HACP

200 Ross Street Pittsburgh,PA,15219

#### **Client:**

Allies & Ross Management and Development Corporation (ARMDC) 200 Ross Street Pittsburgh, PA 15219

### **Project Location:**

Northview Heights Midrise 246 Penfort Street Pittsburgh, PA 15214


LEGEND AND GENERAL NOTES

As Noted

December 3rd, 2023

**P000** 

**Sheet No.** 

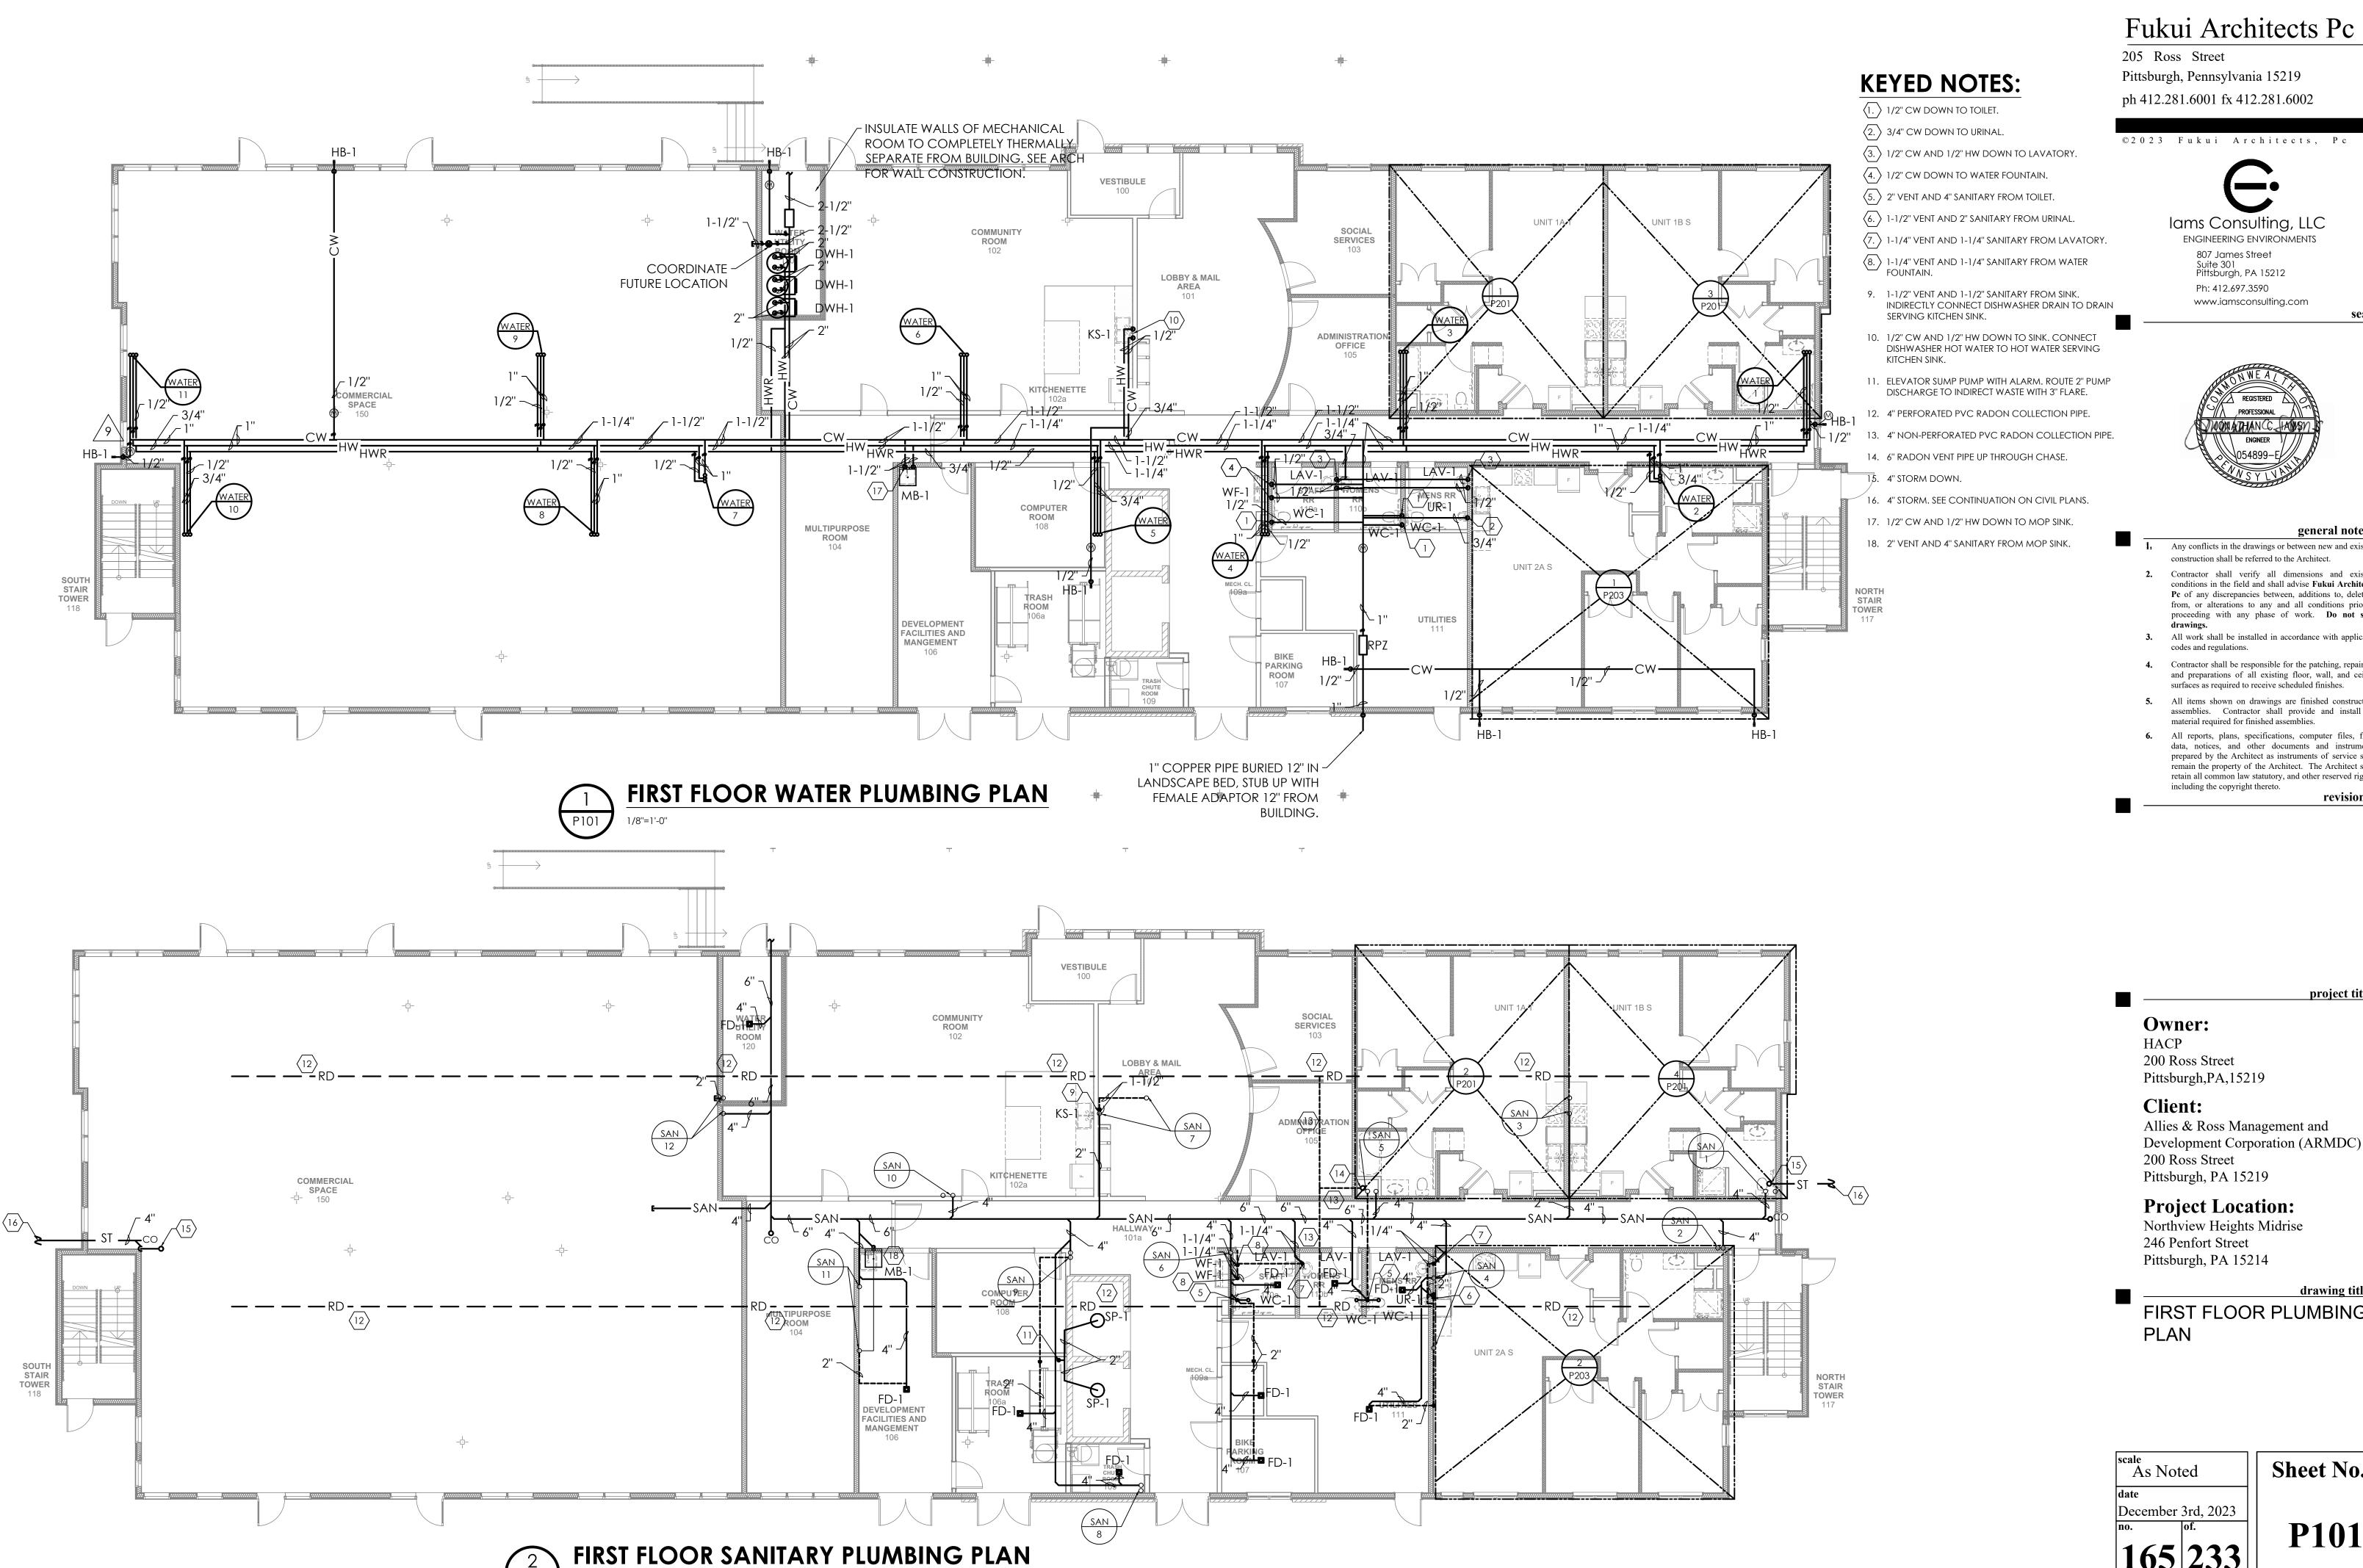

Pittsburgh, Pennsylvania 15219

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- 2. Contractor shall verify all dimensions and existing conditions in the field and shall advise Fukui Architects, Pc of any discrepancies between, additions to, deletions from, or alterations to any and all conditions prior to proceeding with any phase of work. Do not scale
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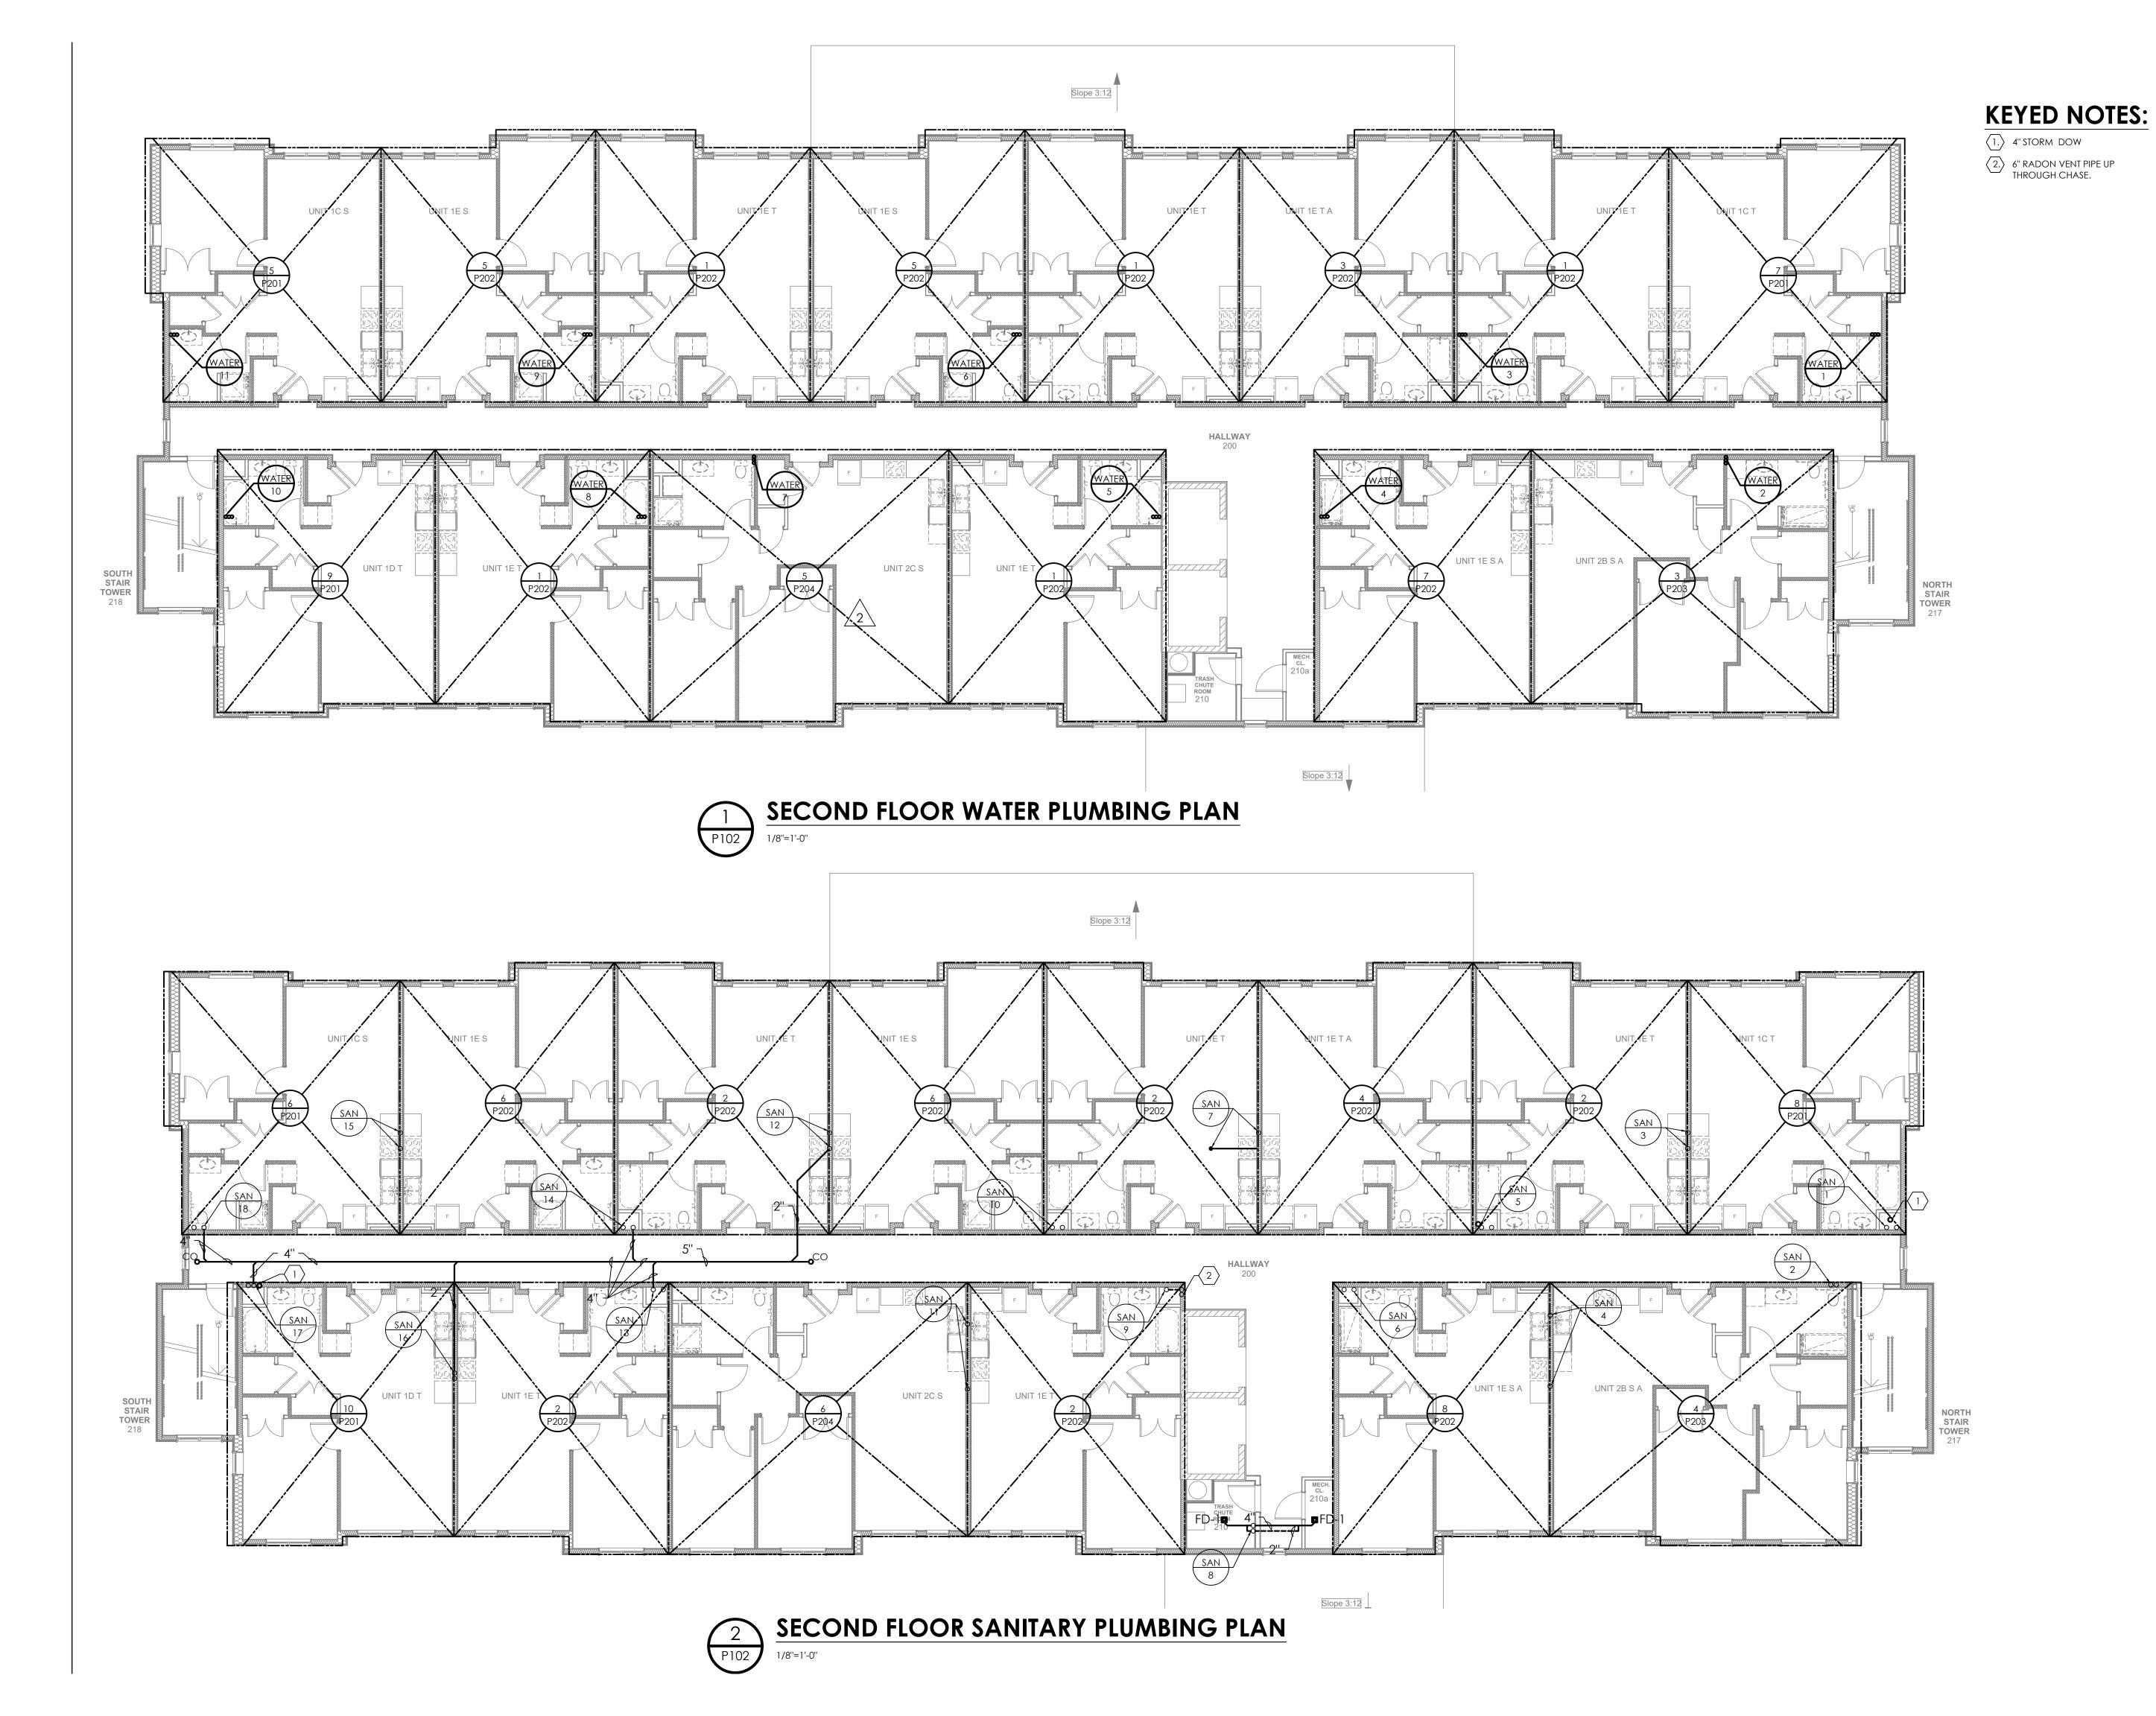
\_project title

Development Corporation (ARMDC)

FIRST FLOOR PLUMBING

**Sheet No.** 

P101



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project title

## Owner: HACP

200 Ross Street Pittsburgh,PA,15219

#### **Client:**

Allies & Ross Management and Development Corporation (ARMDC) 200 Ross Street Pittsburgh, PA 15219

# Project Location: Northview Heights Midrise

Northview Heights Midr. 246 Penfort Street Pittsburgh, PA 15214

drawing tit

SECOND FLOOR PLUMBING PLAN

date
December 3rd, 2023
no. of.

Sheet No.

P102

### **KEYED NOTES:**

 4" STORM DOWN
 6" RADON VENT PIPE UP THROUGH CHASE.

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#### general not

- Any conflicts in the drawings or between new and existing construction shall be referred to the Architect.
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   Pc of any discrepancies between, additions to, deletions from, or alterations to any and all conditions prior to proceeding with any phase of work. Do not scale drawings
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project title

## Owner: HACP

200 Ross Street Pittsburgh,PA,15219

### **Client:**

Allies & Ross Management and Development Corporation (ARMDC) 200 Ross Street Pittsburgh, PA 15219

### **Project Location:**

Northview Heights Midrise 246 Penfort Street Pittsburgh, PA 15214

THIRD FLOOR PLUMBING
PLAN

As Noted


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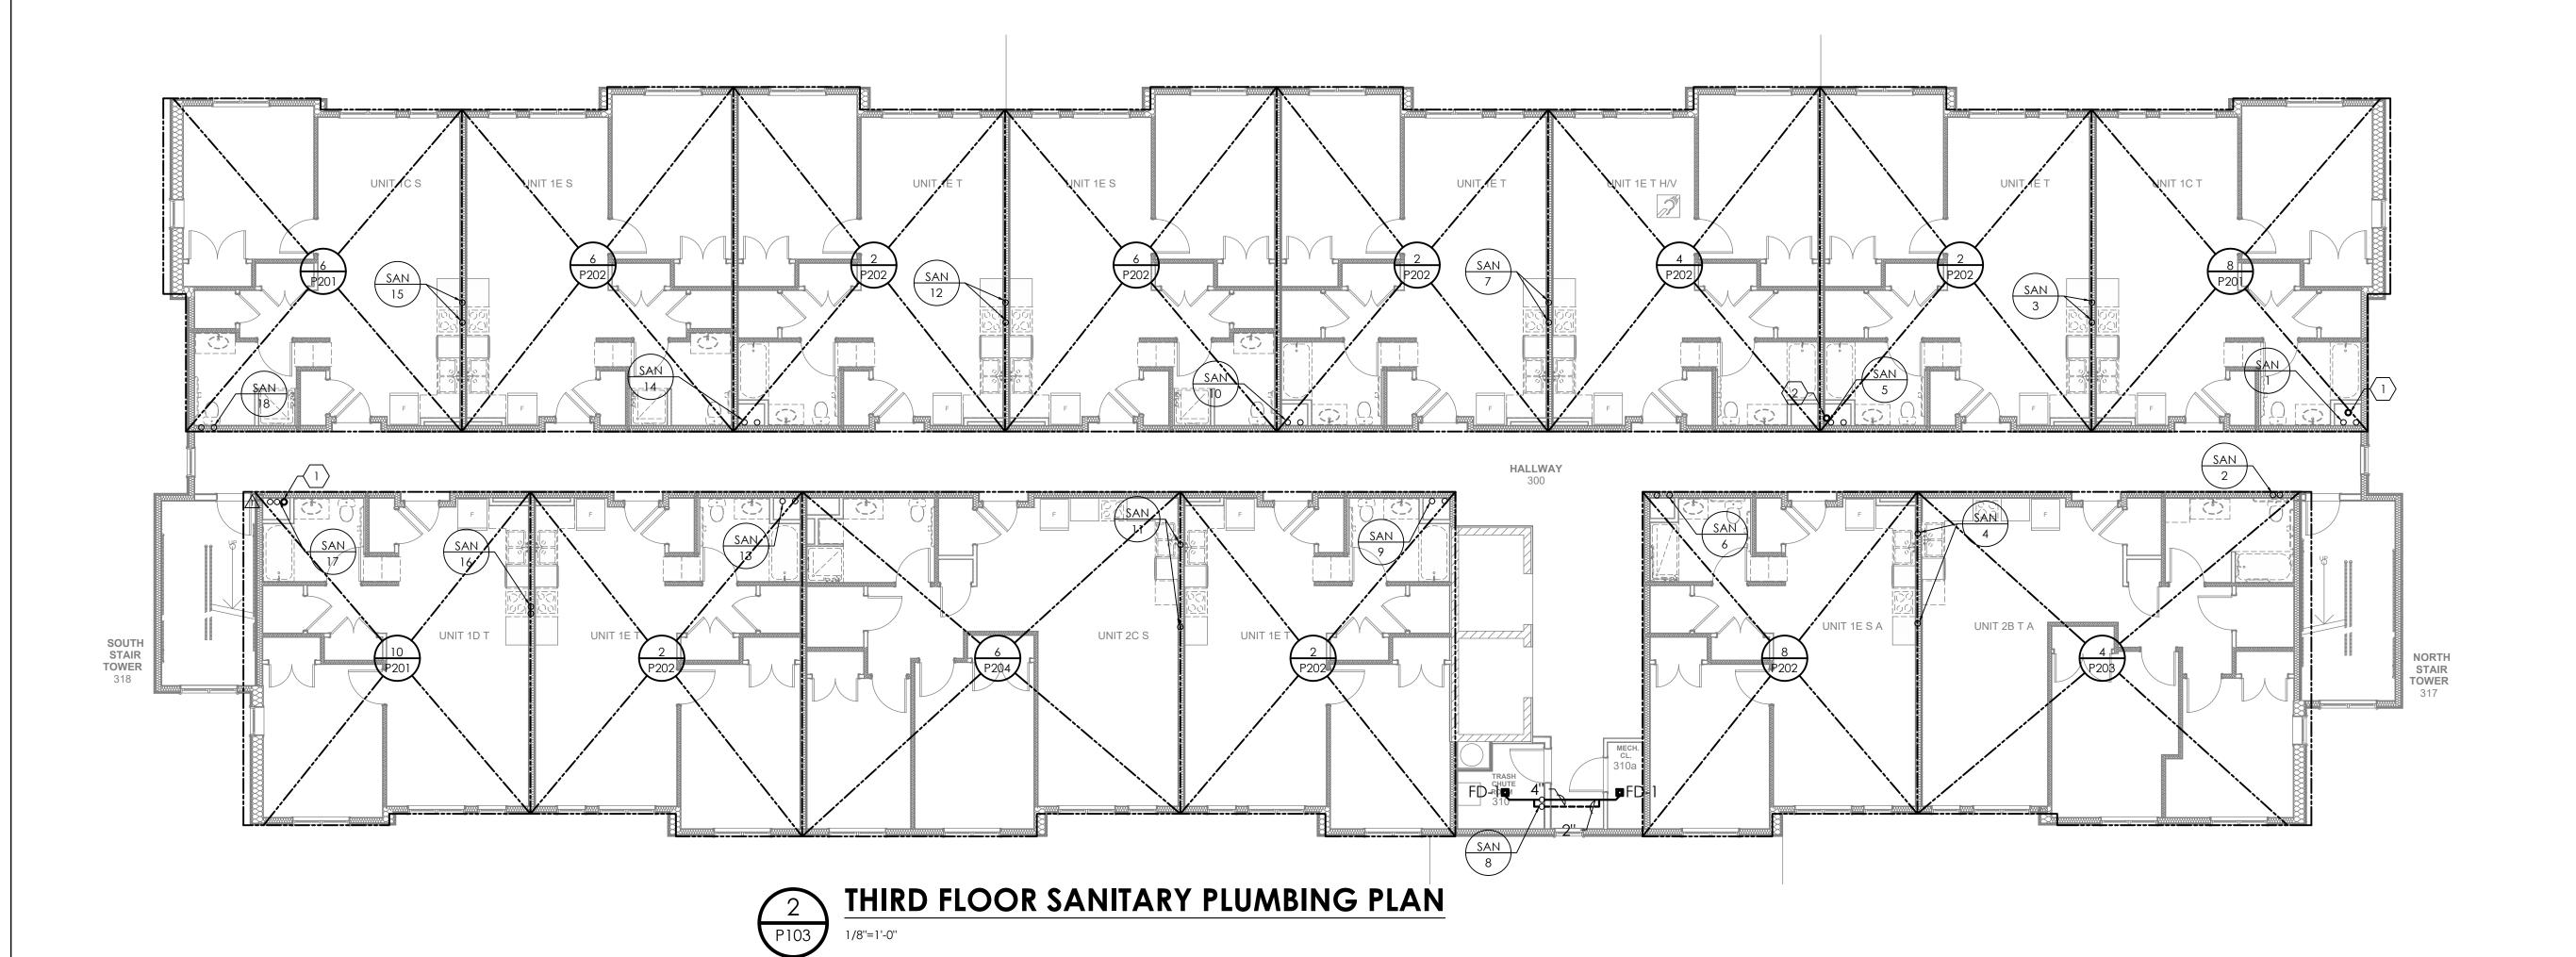
December 3rd, 2023

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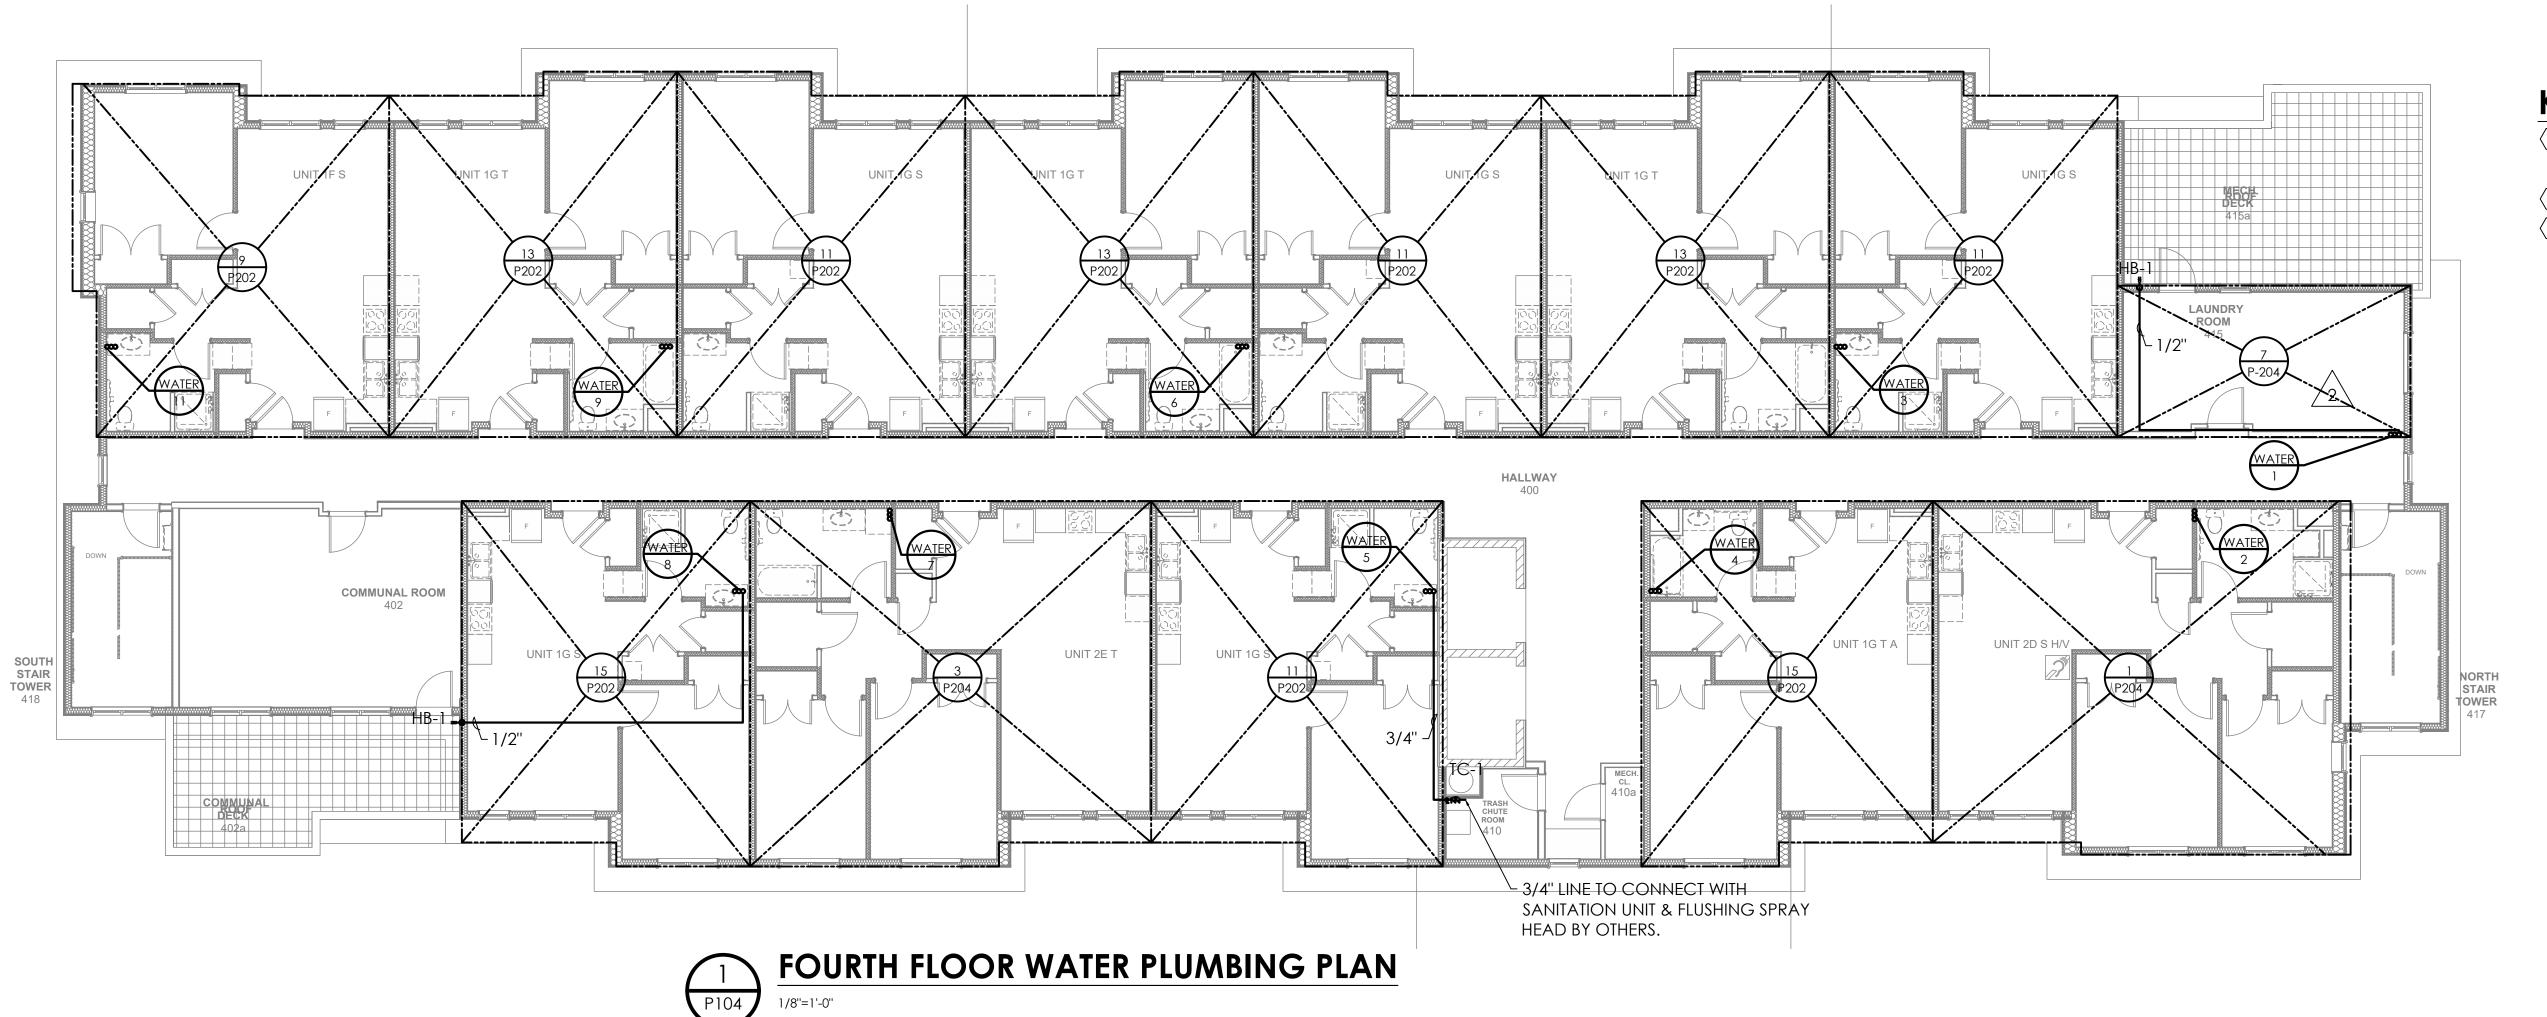
**P103**Project #2040


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THIRD FLOOR WATER PLUMBING PLAN



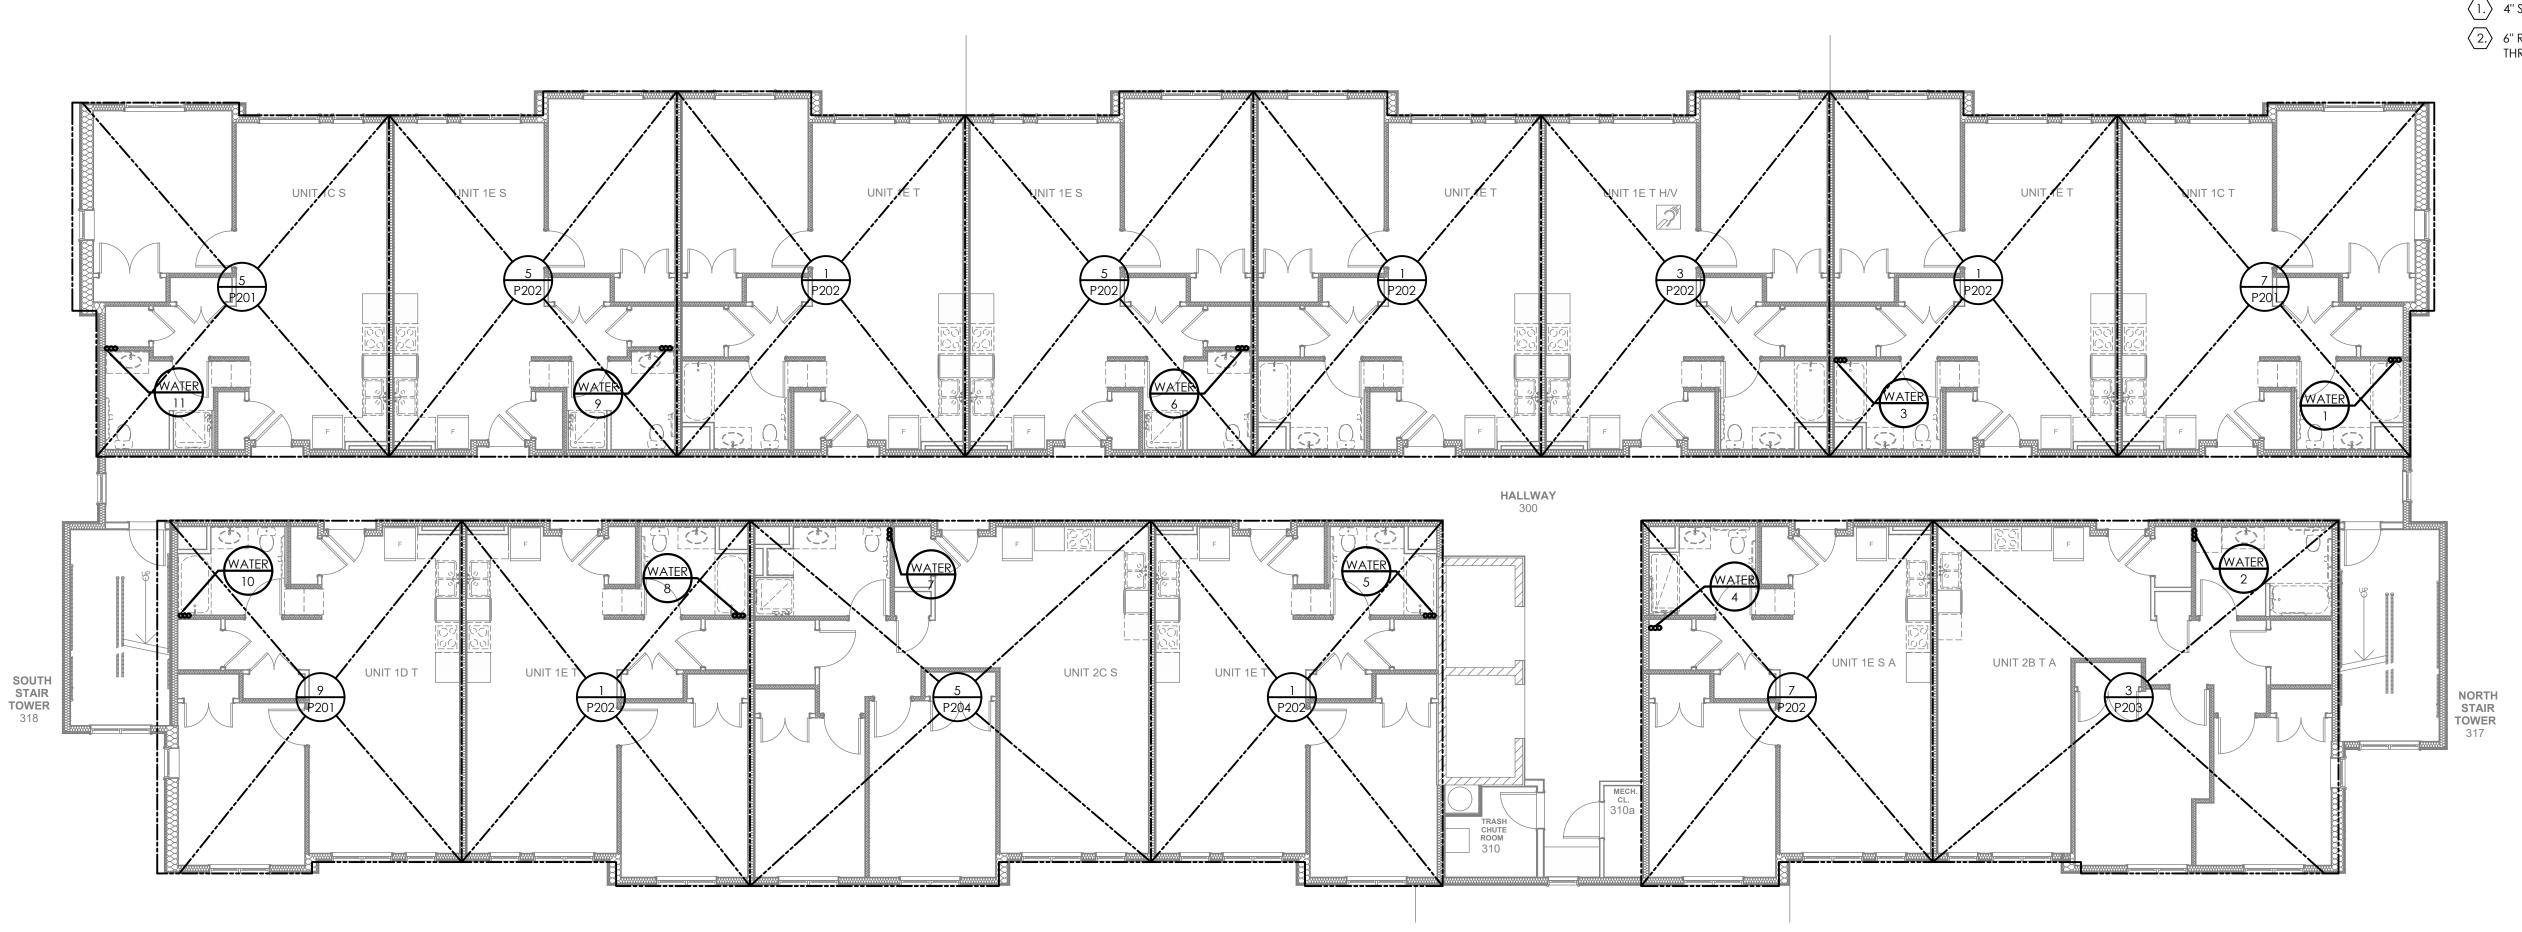

### **KEYED NOTES:**

- 4" SCUPPER BY ARCHITECT.
  COORDINATE WITH
  ARCHITECTURAL ELEVATIONS.
- (2.) 4" STORM DOWN
- 3.) 6" RADON VENT PIPE UP THROUGH CHASE.
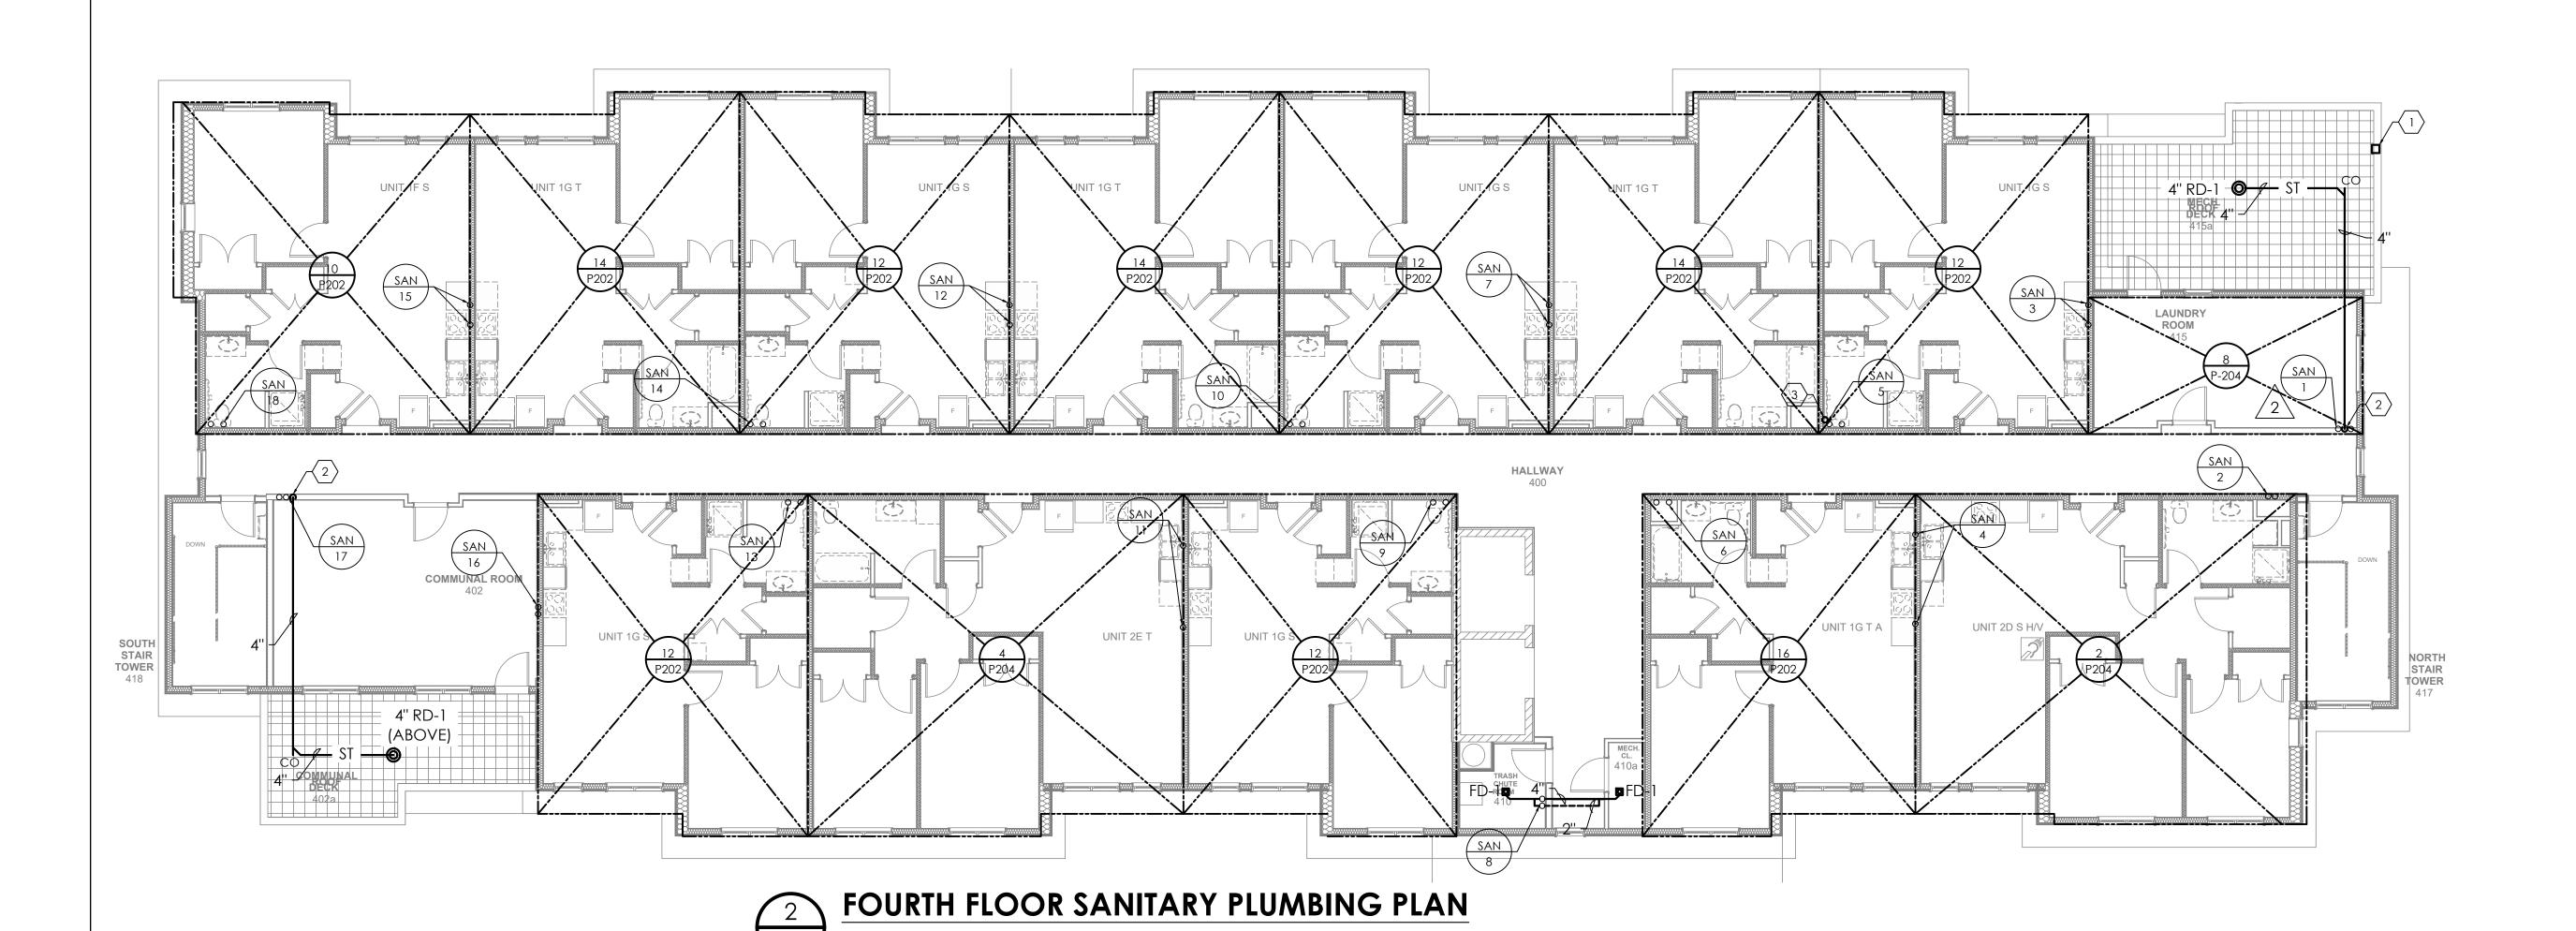
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project title

### Owner:

HACP 200 Ross Street Pittsburgh,PA,15219

#### **Client:**

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### **Project Location:**

Northview Heights Midrise 246 Penfort Street Pittsburgh, PA 15214

drawing title

FOURTH FLOOR PLUMBING PLAN

As Noted

date

December 3rd, 2023


23

P104

Project #2040

Sheet No.

168 233

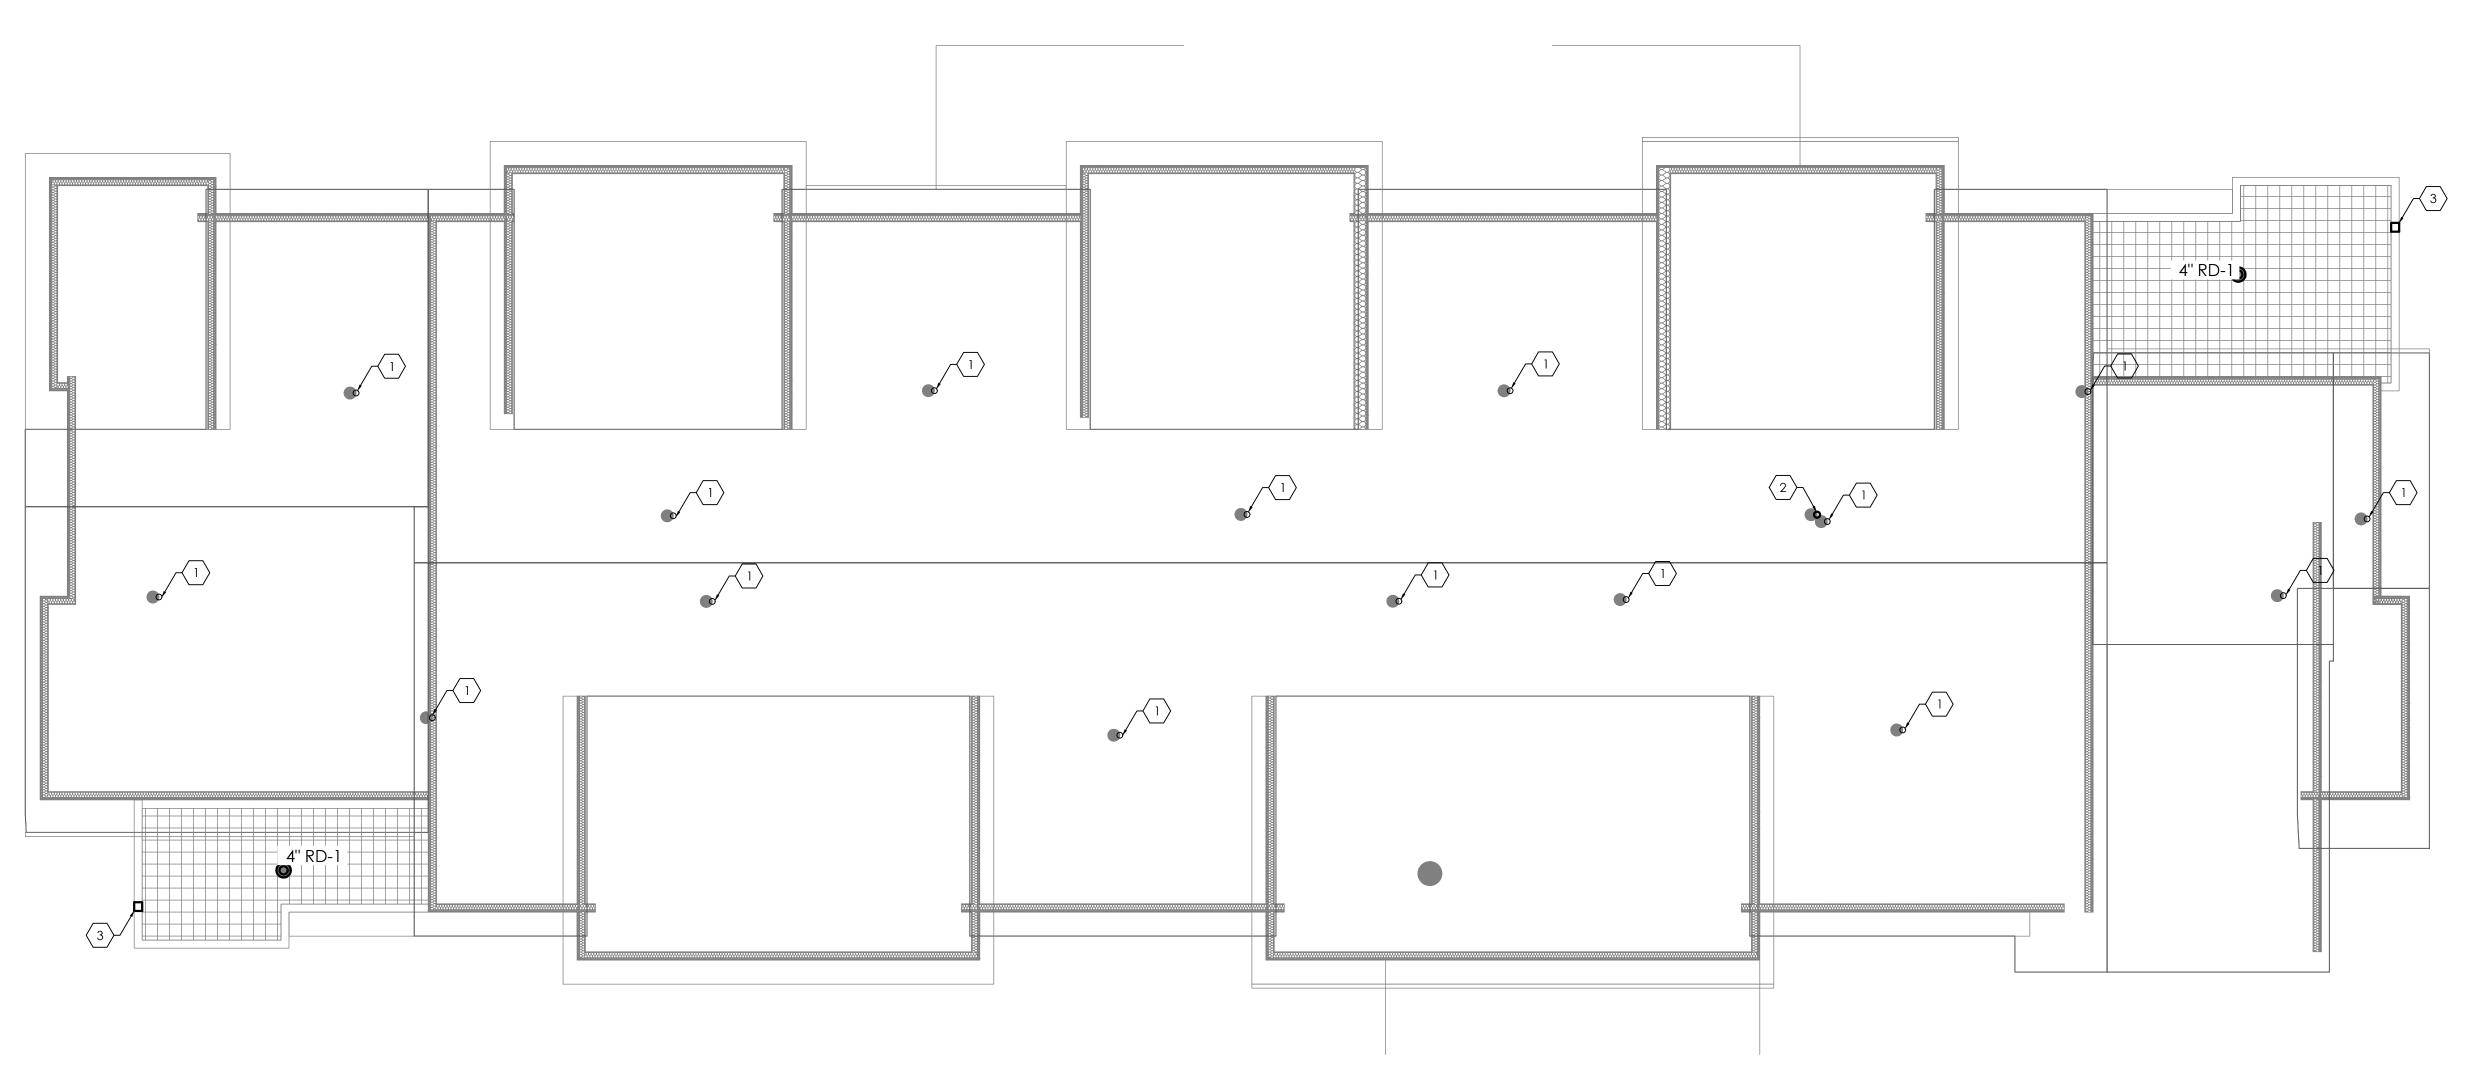



### **KEYED NOTES:**

- 1. VENT PENETRATION. SEE SANITARY RISERS FOR PIPE SIZES.
- 2.) 6" RADON VENT STACK TO EXTEND AT LEAST 12" ABOVE ROOF SURFACE.
- (3.) 4" SCUPPER BY ARCHITECT.
  COORDINATE WITH
  ARCHITECTURAL ELEVATIONS.

### Fukui Architects Pc

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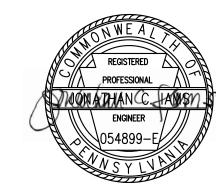
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project title

#### Owner: HACP

200 Ross Street Pittsburgh,PA,15219

#### **Client:**

Allies & Ross Management and Development Corporation (ARMDC) 200 Ross Street Pittsburgh, PA 15219

### **Project Location:**

Northview Heights Midrise 246 Penfort Street Pittsburgh, PA 15214

drawing title


ROOF VENT PENETRATION PLAN


scale As Noted

December 3rd, 2023

P105


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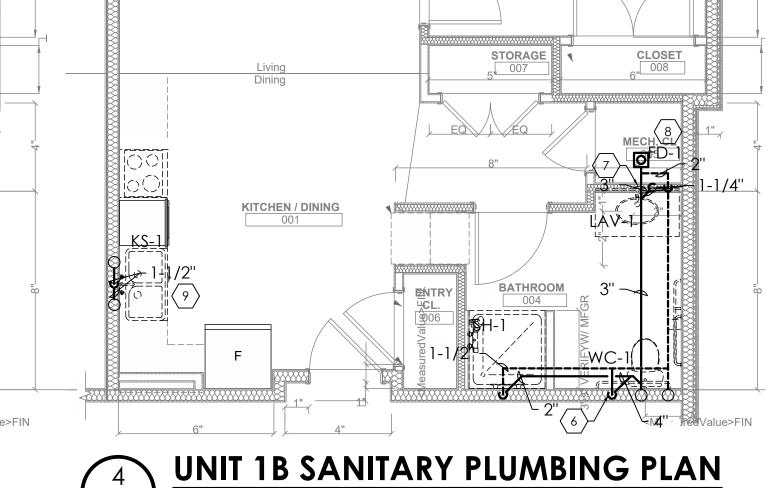


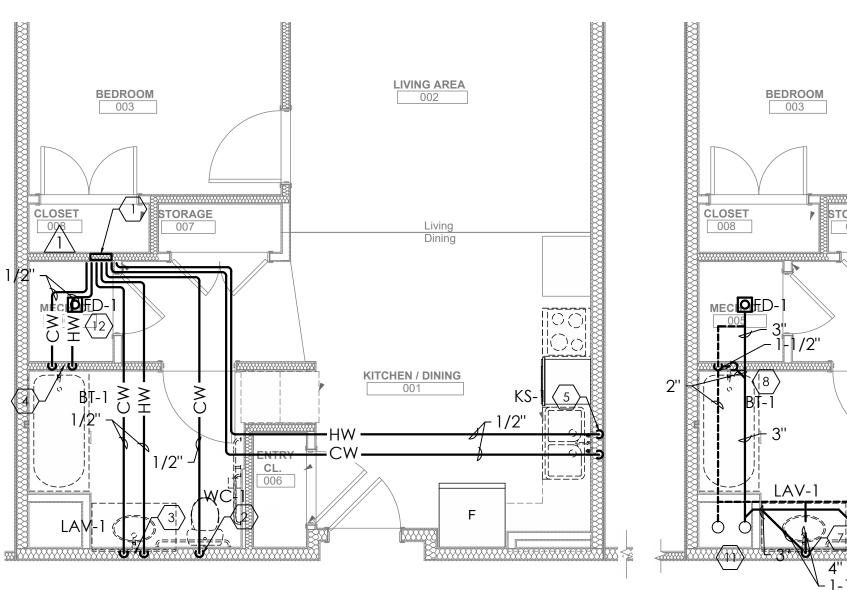

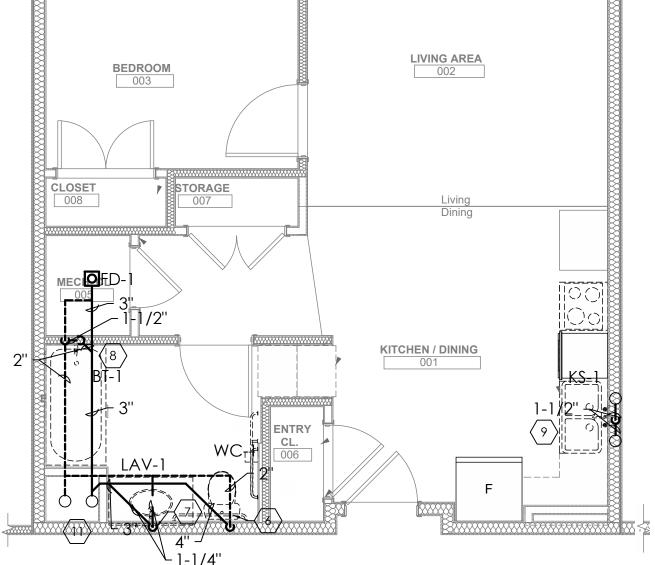






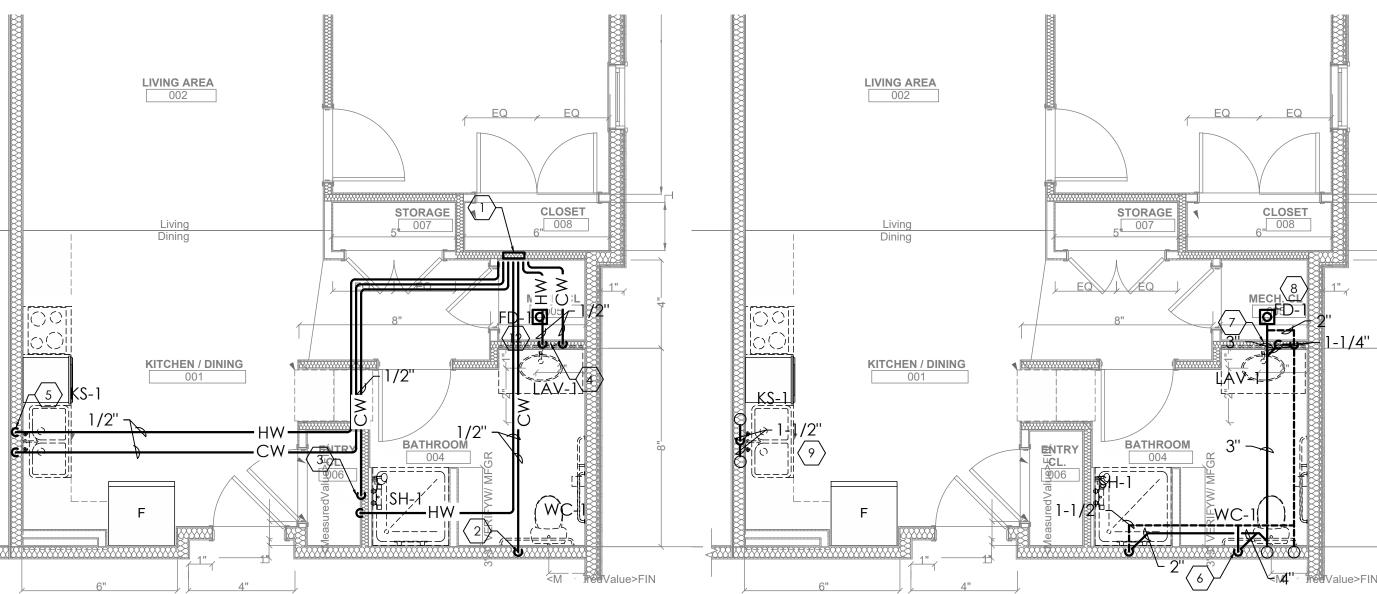






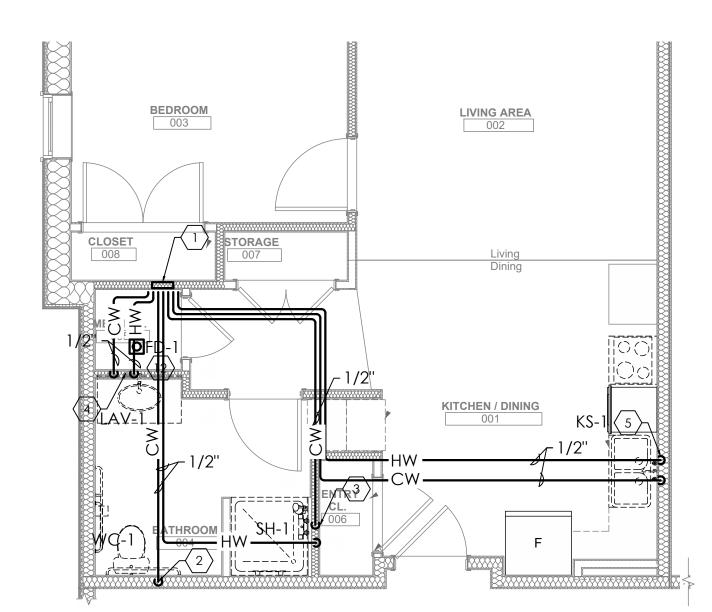

UNIT 1C S WATER PLUMBING PLAN

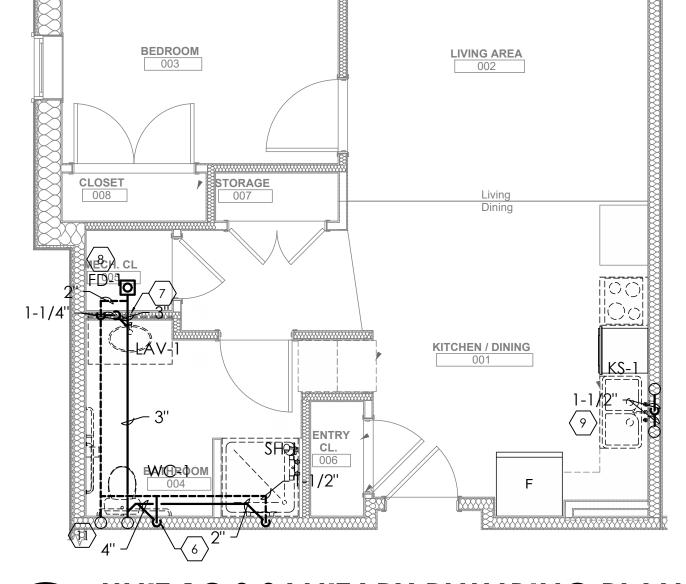





### **KEYED NOTES:**


- $\langle 1. \rangle$  PEX MANIFOLD CONNECTION FOR CW AND HW.
- $\langle 2. \rangle$  1/2" CW DOWN TO TOILET.
- $\langle 3. \rangle$  1/2" CW AND 1/2" HW DOWN TO LAVATORY.
- $\overline{\langle 4. \rangle}$  1/2" CW AND 1/2" HW DOWN TO BATH TUB.
- $\langle 5. \rangle$  1/2" CW AND 1/2" HW DOWN TO KITCHEN SINK. CONNECT
- DISHWASHER HOT WATER TO HOT WATER SERVING KITCHEN SINK.
- $\langle 6. \rangle$  2" VENT AND 3" SANITARY FROM TOILET.
- $\langle 7. \rangle$  1-1/4" VENT AND 1-1/4" SANITARY FROM LAVATORY.
- (8.) 4" VENT AND 4" SANITARY STACK. BATH TUB VENT AND SANITARY CONNECTED TO STACK.
- 9. 1-1/2" VENT AND 1-1/2" SANITARY FROM KITCHEN SINK. INDIRECTLY CONNECT DISHWASHER DRAIN TO DRAIN SERVING KITCHEN SINK.
- $\langle 10 \rangle$  1/2" CW and 1/2" HW down to Washer.
- $\langle 11 \rangle$  1-1/2" VENT AND 1-1/2" SANITARY FROM WASHER.



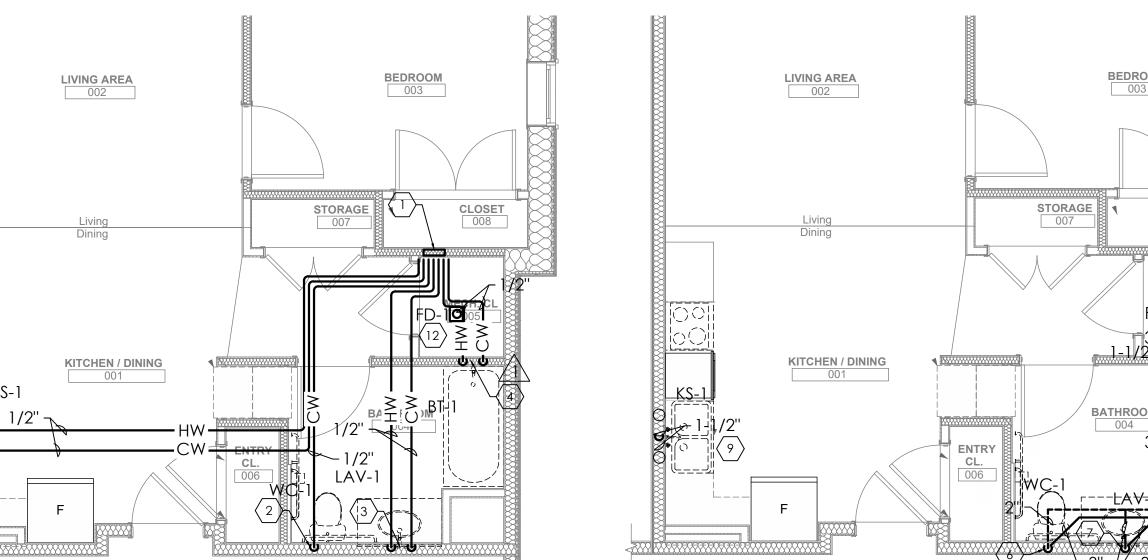

P201

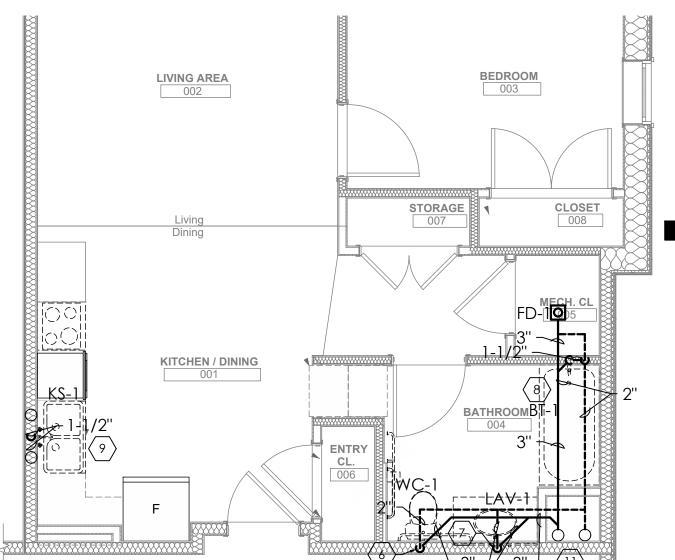

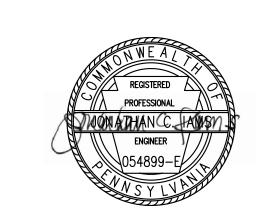

Fukui Architects Pc

Pittsburgh, Pennsylvania 15219

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205 Ross Street

#### general notes Any conflicts in the drawings or between new and existing


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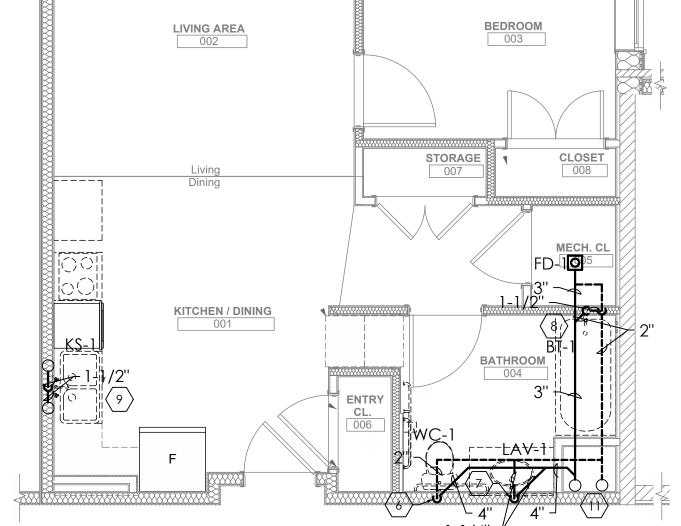
### UNIT 1C B WATER PLUMBING PLAN P201

P201

UNIT 1C B SANITARY PLUMBING PLAN



UNIT 1D WATER PLUMBING PLAN

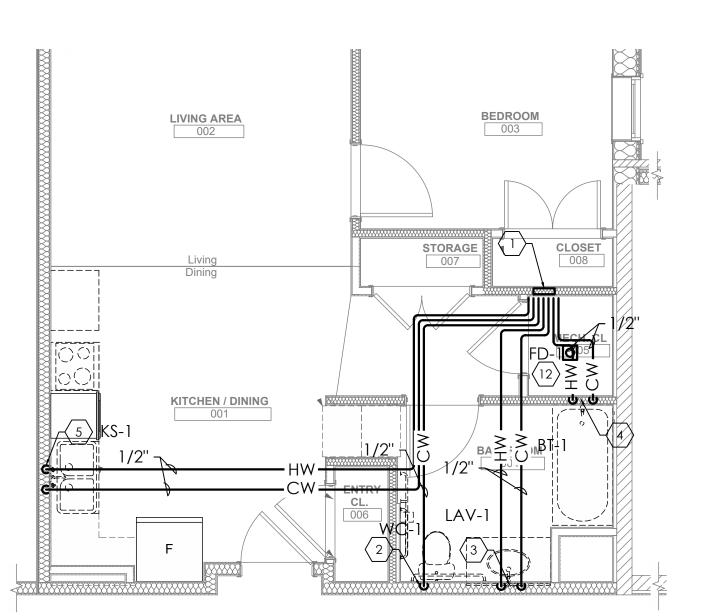

\_project title Owner: HACP 200 Ross Street

### **Client:**

Allies & Ross Management and Development Corporation (ARMDC) 200 Ross Street

### Pittsburgh, PA 15219

Pittsburgh,PA,15219


**Project Location:** Northview Heights Midrise 246 Penfort Street Pittsburgh, PA 15214


drawing title ENLARGED PLUMBING PLAN


As Noted December 3rd, 2023 170 233

**UNIT 1D SANITARY PLUMBING PLAN** 


**Sheet No. P201** Project #2040

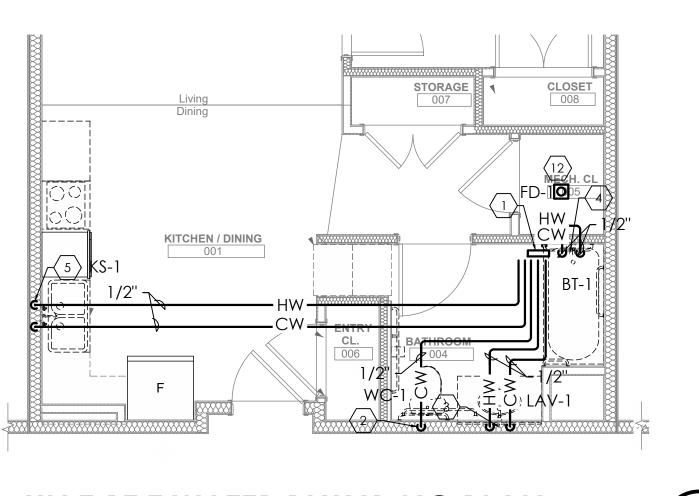


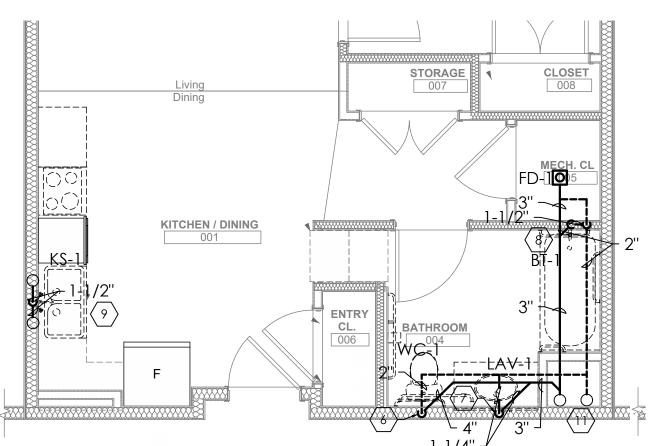


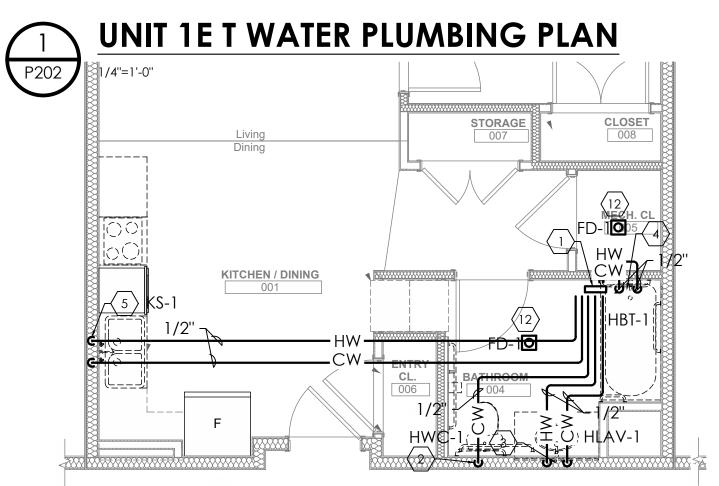


P202

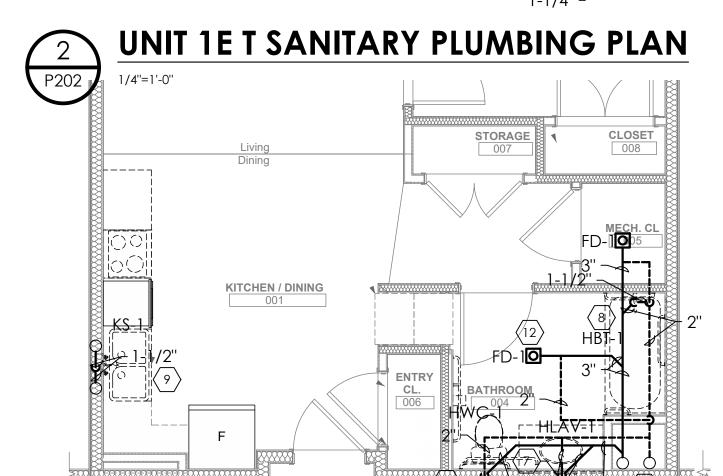

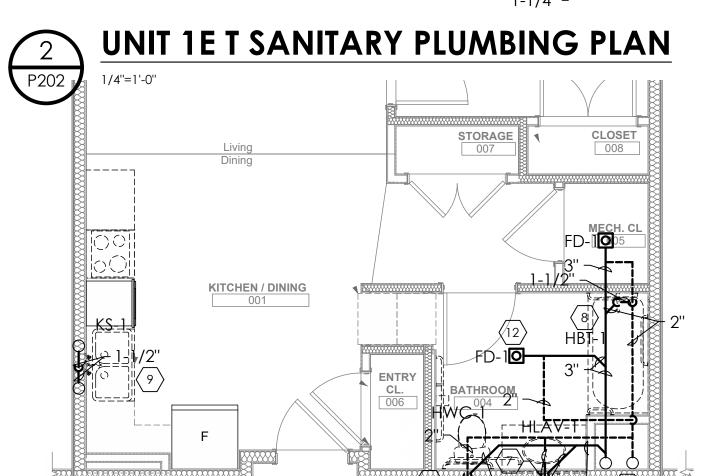

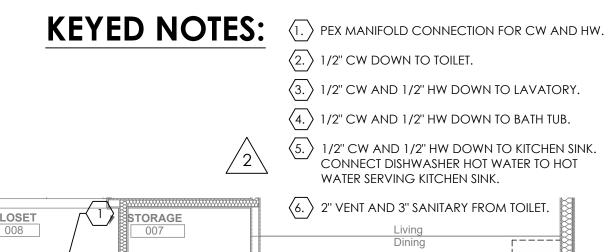

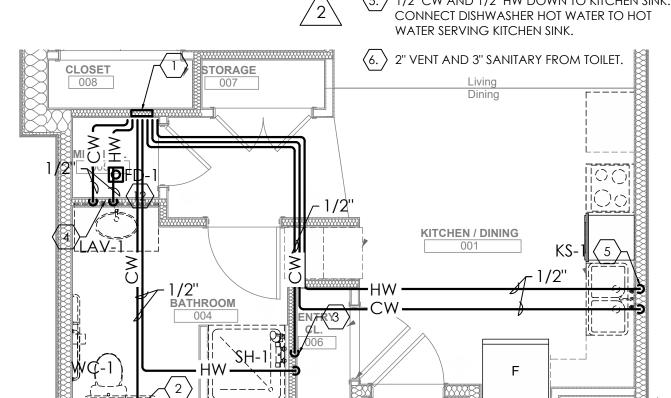

 $\overline{\langle 7. \rangle}$  1-1/4" VENT AND 1-1/4" SANITARY FROM LAVATORY.

 $\langle 8. \rangle$  1-1/2" VENT AND 1-1/2" SANITARY FROM BATH TUB/SHOWER.

9.) 1-1/2" VENT AND 1-1/2" SANITARY FROM KITCHEN SINK. INDIRECTLY CONNECT DISHWASHER DRAIN TO DRAIN SERVING KITCHEN SINK.

(10) 1/2" CW AND 1/2" HW DOWN TO WASHER.

(11) 4" VENT 4" SANITARY STACK. (12) PROVIDE PRECISION PLUMBING PRODUCTS SINGLE TRAP PRIMER AT FLOOR DRAIN FROM LAV.

UNIT 1F S SANITARY PLUMBING PLAN

001

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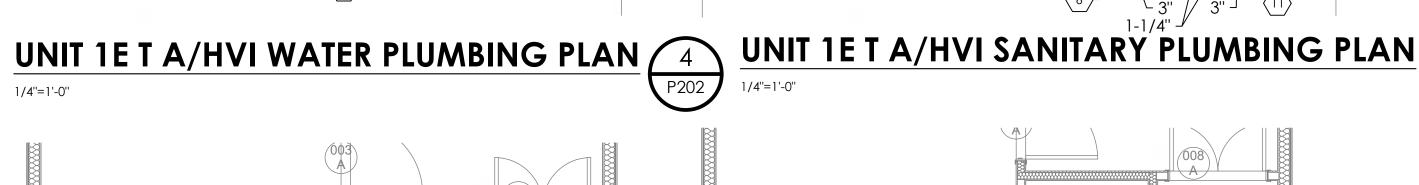



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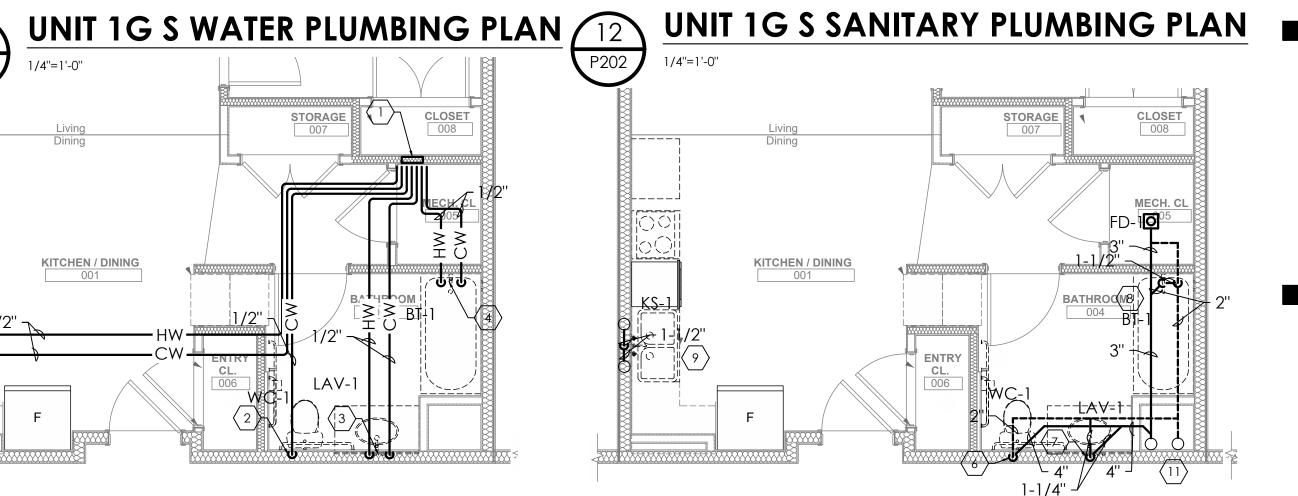
revisions

\_project title


**UNIT 1F S WATER PLUMBING PLAN** P202







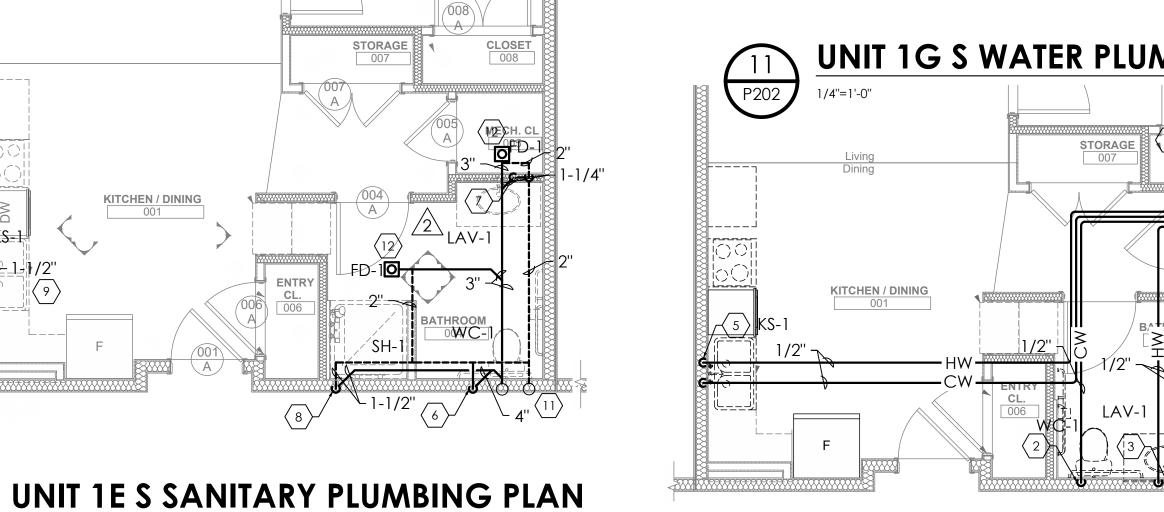



P202

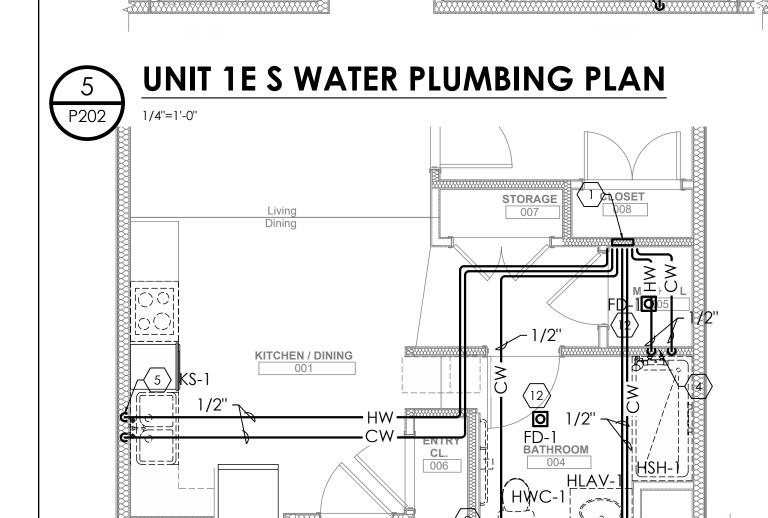

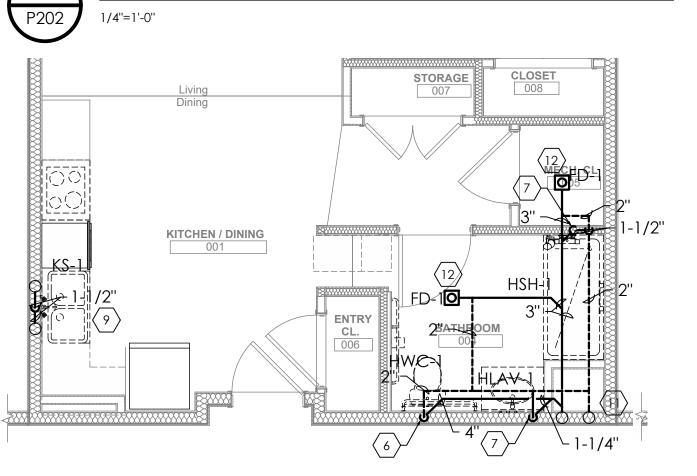

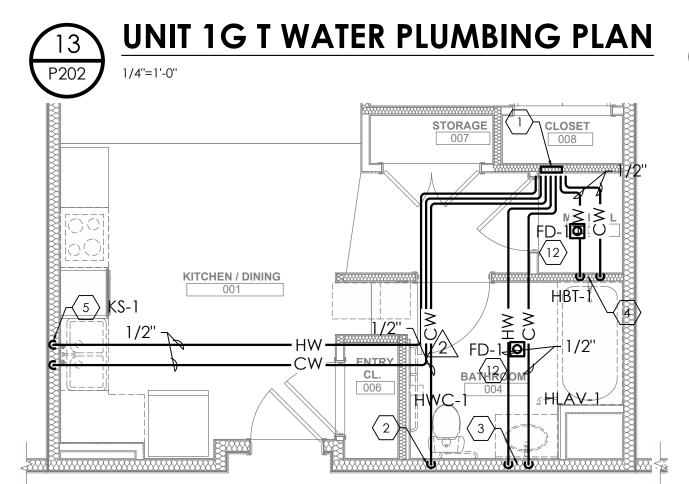

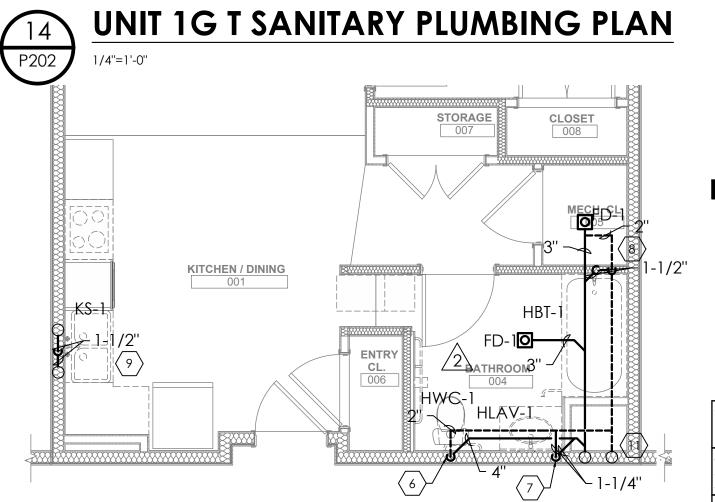

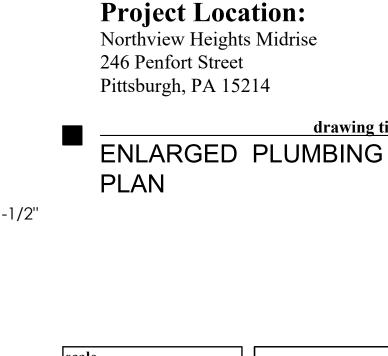

Owner:

**Client:** 

200 Ross Street

200 Ross Street

Pittsburgh, PA 15219

Pittsburgh,PA,15219

Allies & Ross Management and

Development Corporation (ARMDC)

HACP

Sheet No. As Noted December 3rd, 2023 **P202** 

Project #2040


UNIT 1E S A WATER PLUMBING PLAN P202











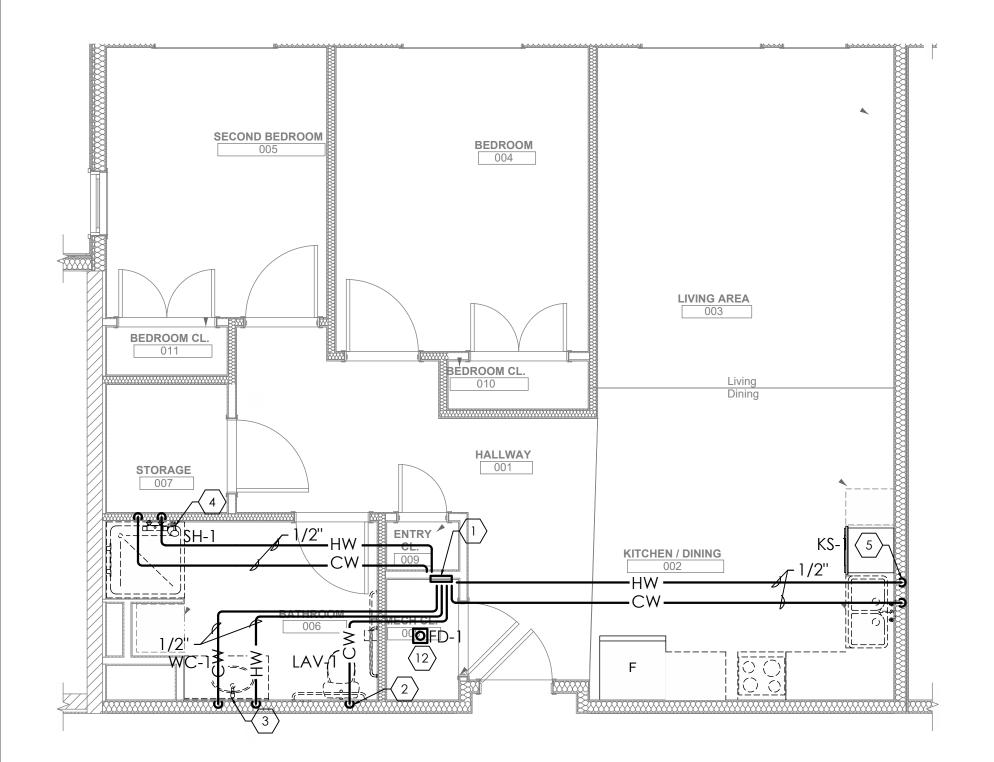




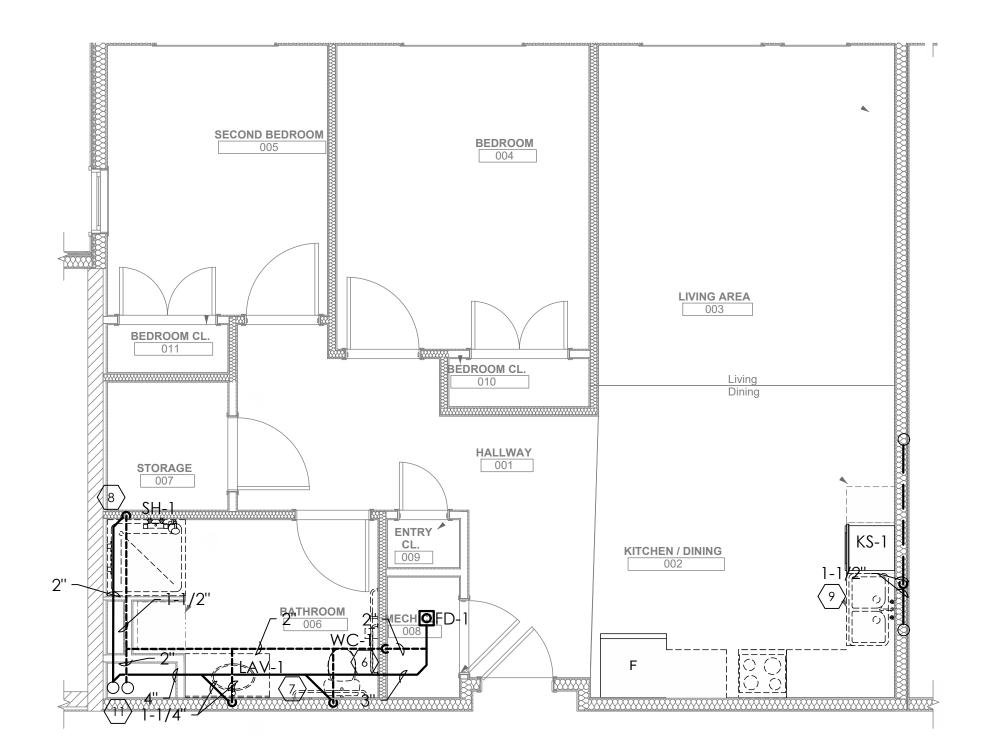


# **UNIT 2A S SANITARY PLUMBING PLAN**

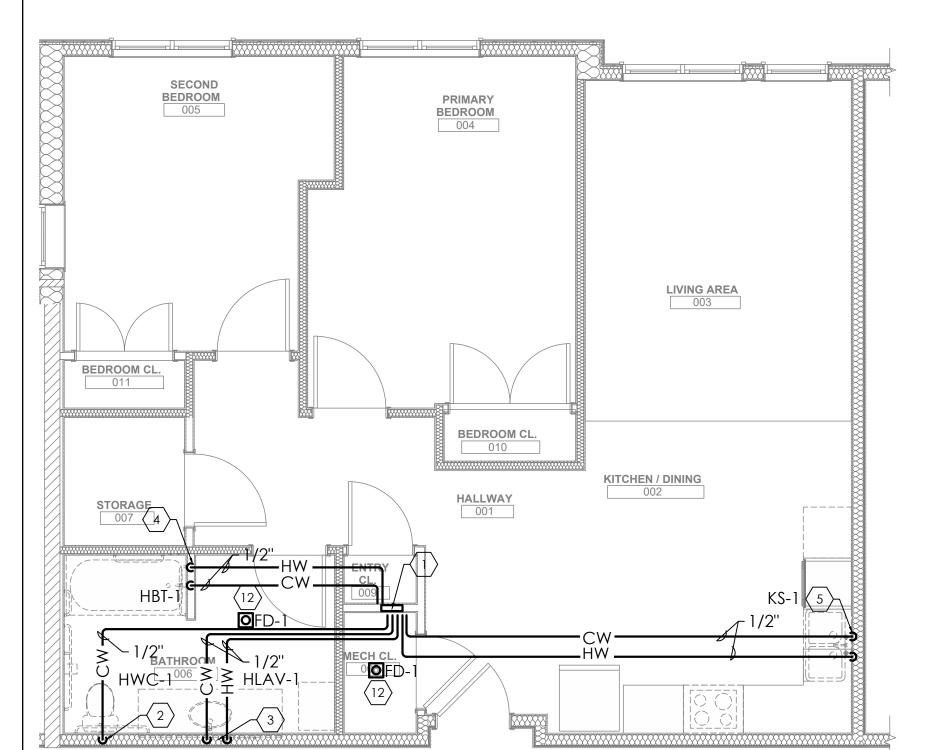


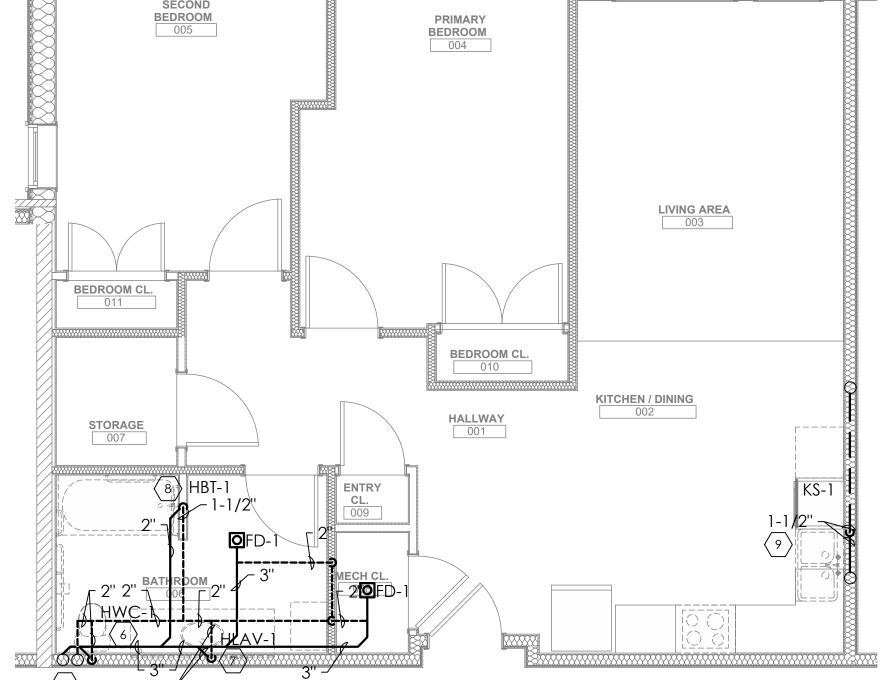





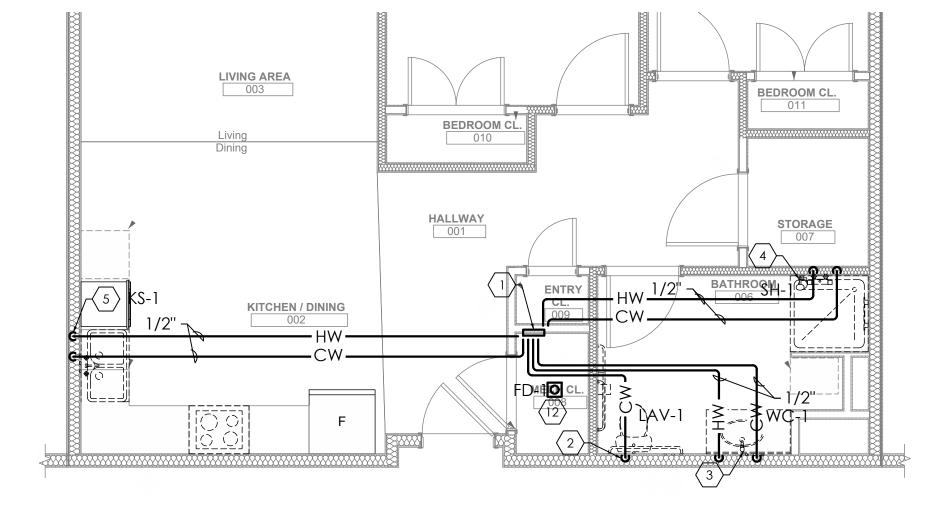

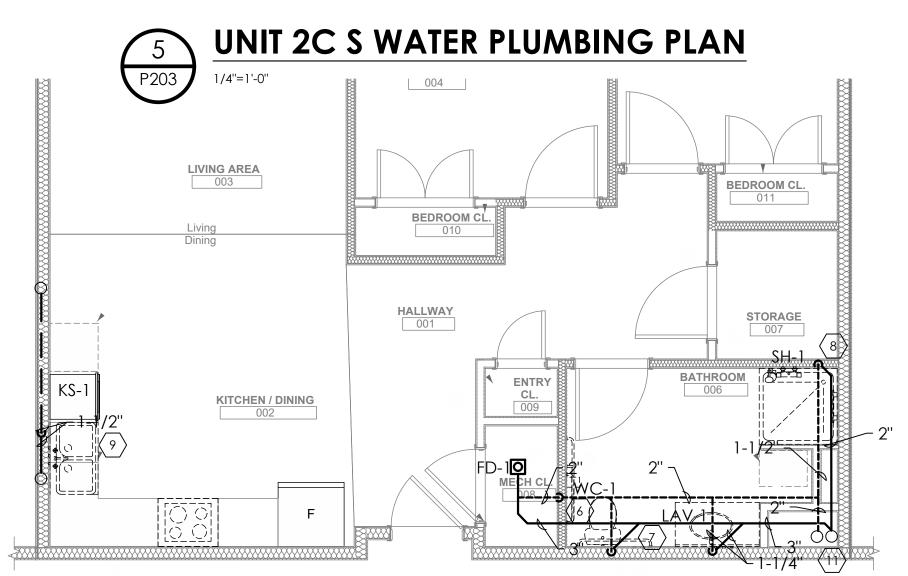



#### Fukui Architects Pc $\langle 1. \rangle$ PEX MANIFOLD CONNECTION FOR CW AND HW.

205 Ross Street

**KEYED NOTES:** 

 $\langle 2. \rangle$  1/2" CW DOWN TO TOILET.

 $\langle 3. \rangle$  1/2" CW AND 1/2" HW DOWN TO LAVATORY.

 $\overline{\langle 4. \rangle}$  1/2" CW AND 1/2" HW DOWN TO BATH TUB.

 $\langle 6. \rangle$  2" VENT AND 3" SANITARY FROM TOILET.

 $\langle 10 \rangle$  1/2" CW AND 1/2" HW DOWN TO WASHER.

 $\langle 11 \rangle$  4" VENT AND 4" SANITARY STACK.

AT FLOOR DRAIN FROM LAV.

 $\langle 5. \rangle$  1/2" CW AND 1/2" HW DOWN TO KITCHEN SINK. CONNECT

9. 1-1/2" VENT AND 1-1/2" SANITARY FROM KITCHEN SINK. INDIRECTLY CONNECT DISHWASHER DRAIN TO DRAIN SERVING KITCHEN SINK.

PROVIDE PRECISION PLUMBING PRODUCTS SINGLE TRAP PRIMER

 $\overline{\langle 7. \rangle}$  1-1/4" VENT AND 1-1/4" SANITARY FROM LAVATORY.

 $\langle 8. \rangle$  1-1/2" VENT AND SANITARY TO BATH TUB/SHOWER.

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DISHWASHER HOT WATER TO HOT WATER SERVING KITCHEN SINK. © 2023 Fukui Architects, Pc



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revisions

\_project title

#### Owner: HACP

200 Ross Street Pittsburgh,PA,15219

### **Client:**

Allies & Ross Management and Development Corporation (ARMDC) 200 Ross Street Pittsburgh, PA 15219


Project Location:
Northview Heights Midrise 246 Penfort Street Pittsburgh, PA 15214

ENLARGED PLUMBING PLAN


scale As Noted December 3rd, 2023

Sheet No.


**P203** 

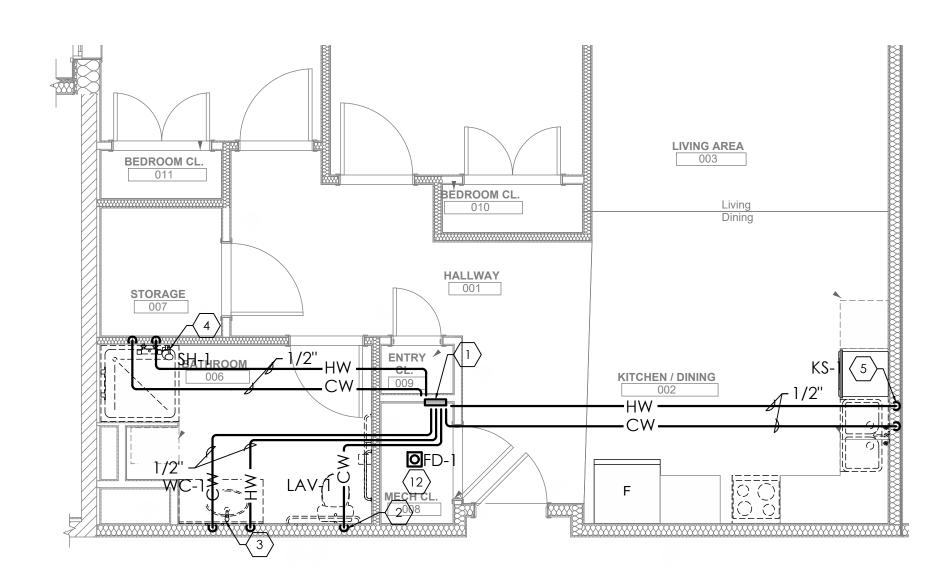


# 1 UNIT 2D S HV WATER PLUMBING PLAN 1/4"=1'-0"

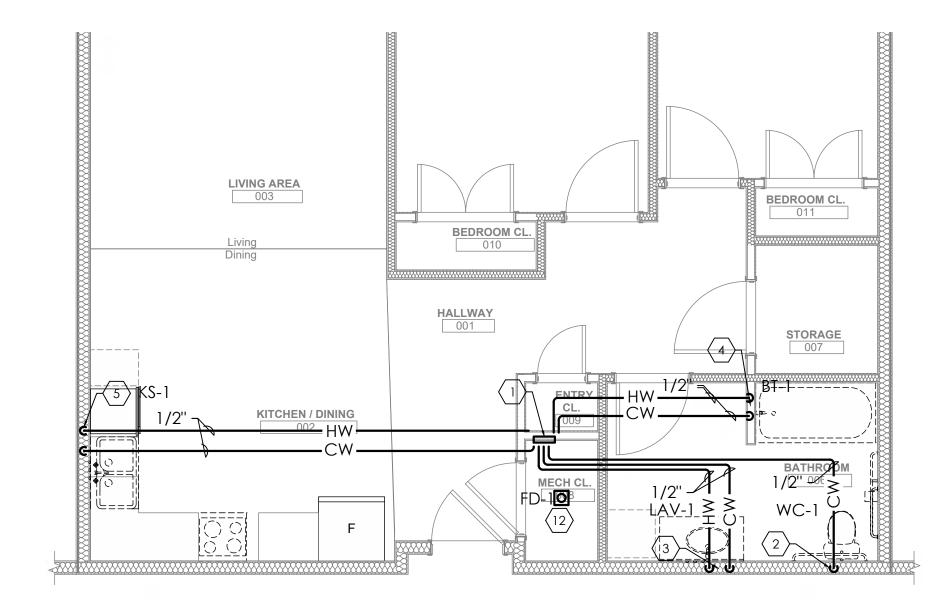


# 3 UNIT 2E WATER PLUMBING PLAN 1/4"=1'-0"

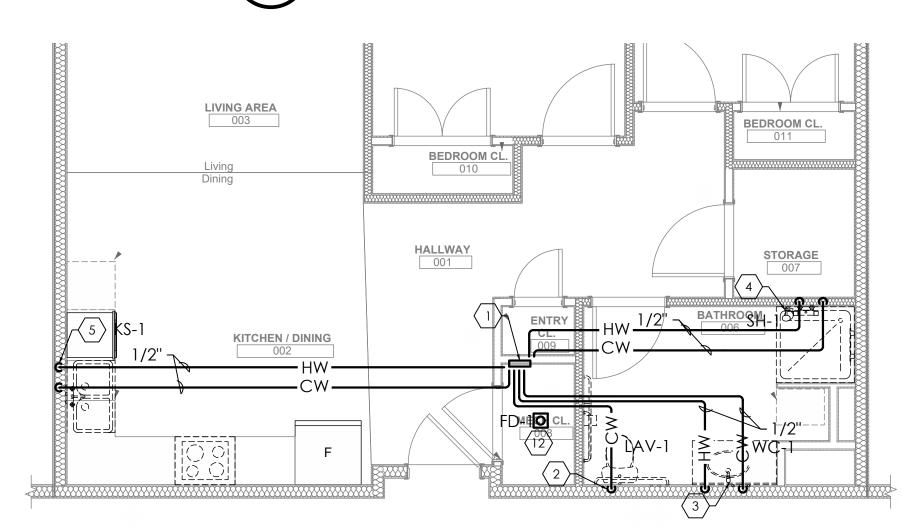




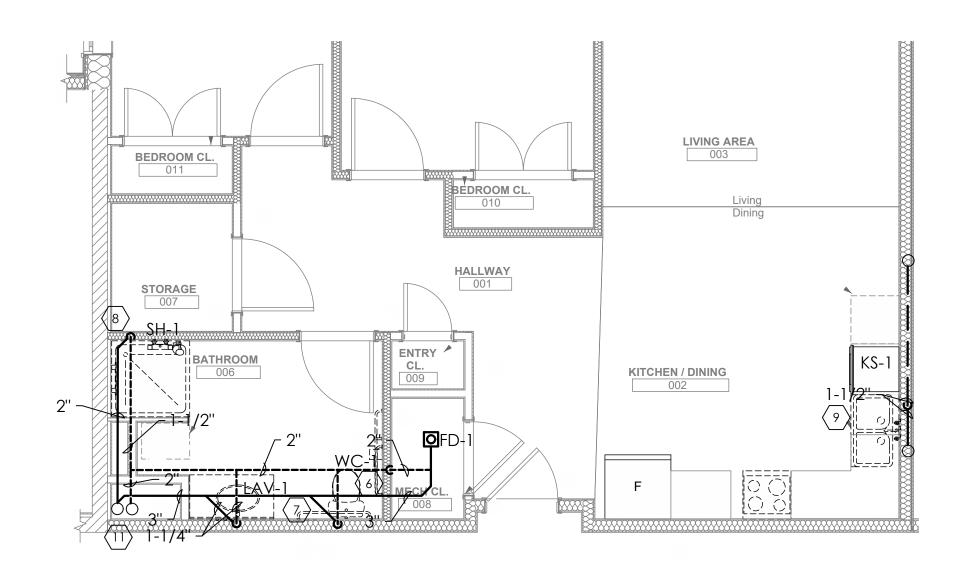

# UNIT 2D S HV SANITARY PLUMBING PLAN 1/4"=1'-0"

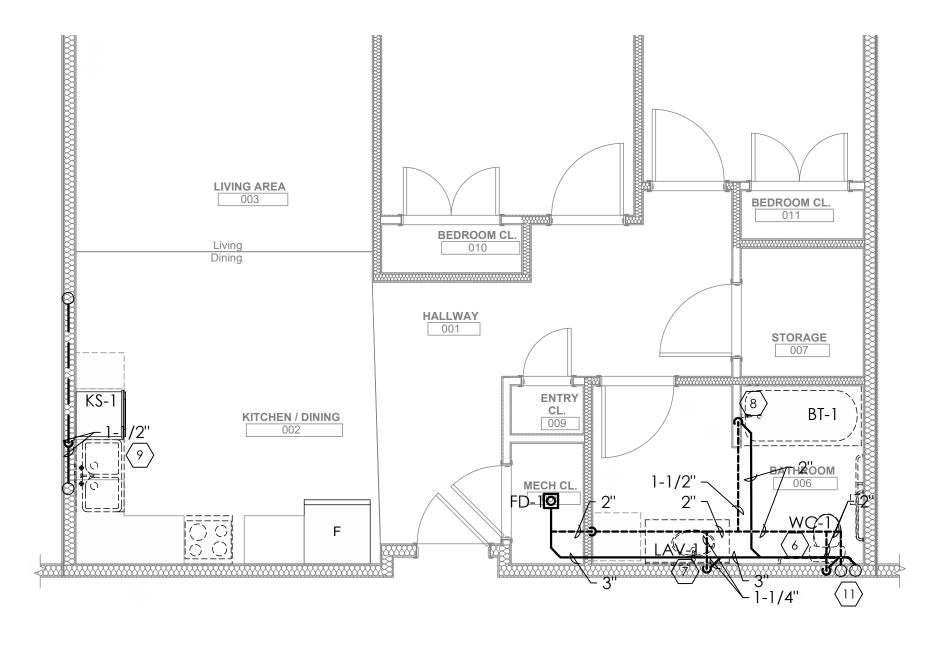



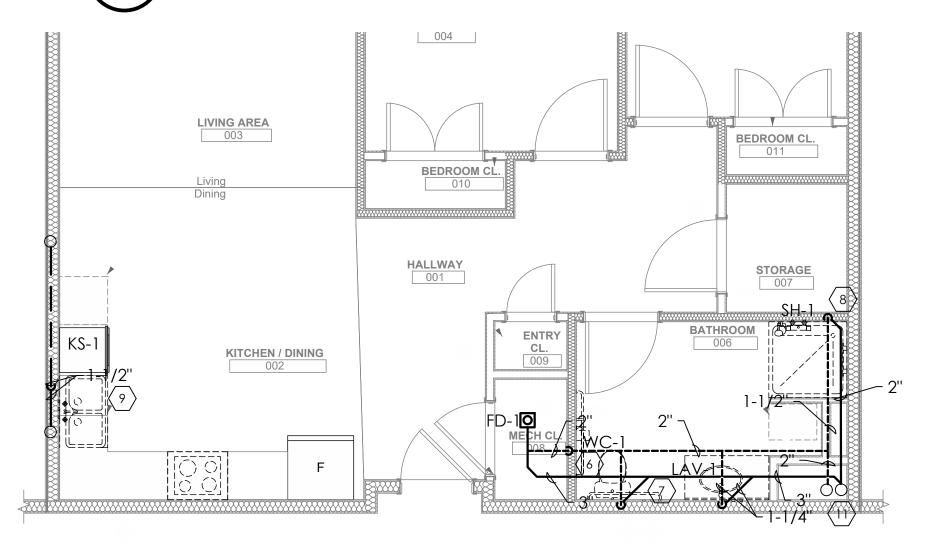



### **KEYED NOTES:**

- $\langle 1. \rangle$  PEX MANIFOLD CONNECTION FOR CW AND HW.
- $\langle 2. \rangle$  1/2" CW DOWN TO TOILET.

(12)**©**FD-1

WFA-1 WFA-1 WFA-1 WFA-1

WFA-1 WFA-1 WFA-1 WFA-1

LAUNDRY ROOM SANITARY PLUMBING PLAN

LAUNDRY ROOM WATER PLUMBING PLAN

LAUNDRY

**ROOM** 

415

LAUNDRY

ROOM

415

P204

8 P204

- $\langle 3. \rangle$  1/2" CW AND 1/2" HW DOWN TO LAVATORY.
- $\overline{\langle 4. \rangle}$  1/2" CW AND 1/2" HW DOWN TO BATH TUB.
- (5.) 1/2" CW AND 1/2" HW DOWN TO KITCHEN SINK. CONNECT DISHWASHER HOT WATER TO HOT WATER SERVING KITCHEN SINK.
- (6.) 2" VENT AND 3" SANITARY FROM TOILET.
- $\overline{\langle 7. \rangle}$  1-1/4" VENT AND 1-1/4" SANITARY FROM LAVATORY.
- (8.) 4" VENT AND 4" SANITARY STACK. BATH TUB VENT AND SANITARY CONNECTED TO STACK.
- 9. 1-1/2" VENT AND 1-1/2" SANITARY FROM KITCHEN SINK. INDIRECTLY CONNECT DISHWASHER DRAIN TO DRAIN SERVING KITCHEN SINK.
- 10) 1/2" CW AND 1/2" HW ROUGH-INS FOR LAUNDRY UNITS SUPPLIED BY OWNER.
- 11) 1-1/2" VENT AND 2" SANITARY FROM OWNER-SUPPLIED WASHER.
- PROVIDE PRECISION PLUMBING PRODUCTS SINGLE TRAP PRIMER AT FLOOR DRAIN FROM LAV.

### Fukui Architects Pc

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revisions

project title

## Owner:

200 Ross Street Pittsburgh,PA,15219

#### **Client:**

Allies & Ross Management and Development Corporation (ARMDC) 200 Ross Street Pittsburgh, PA 15219

## **Project Location:**

Northview Heights Midrise 246 Penfort Street Pittsburgh, PA 15214

drawing title

ENLARGED PLUMBING PLAN

As Noted


date

December 3rd, 2023


173 | 233

Sheet No.

P204

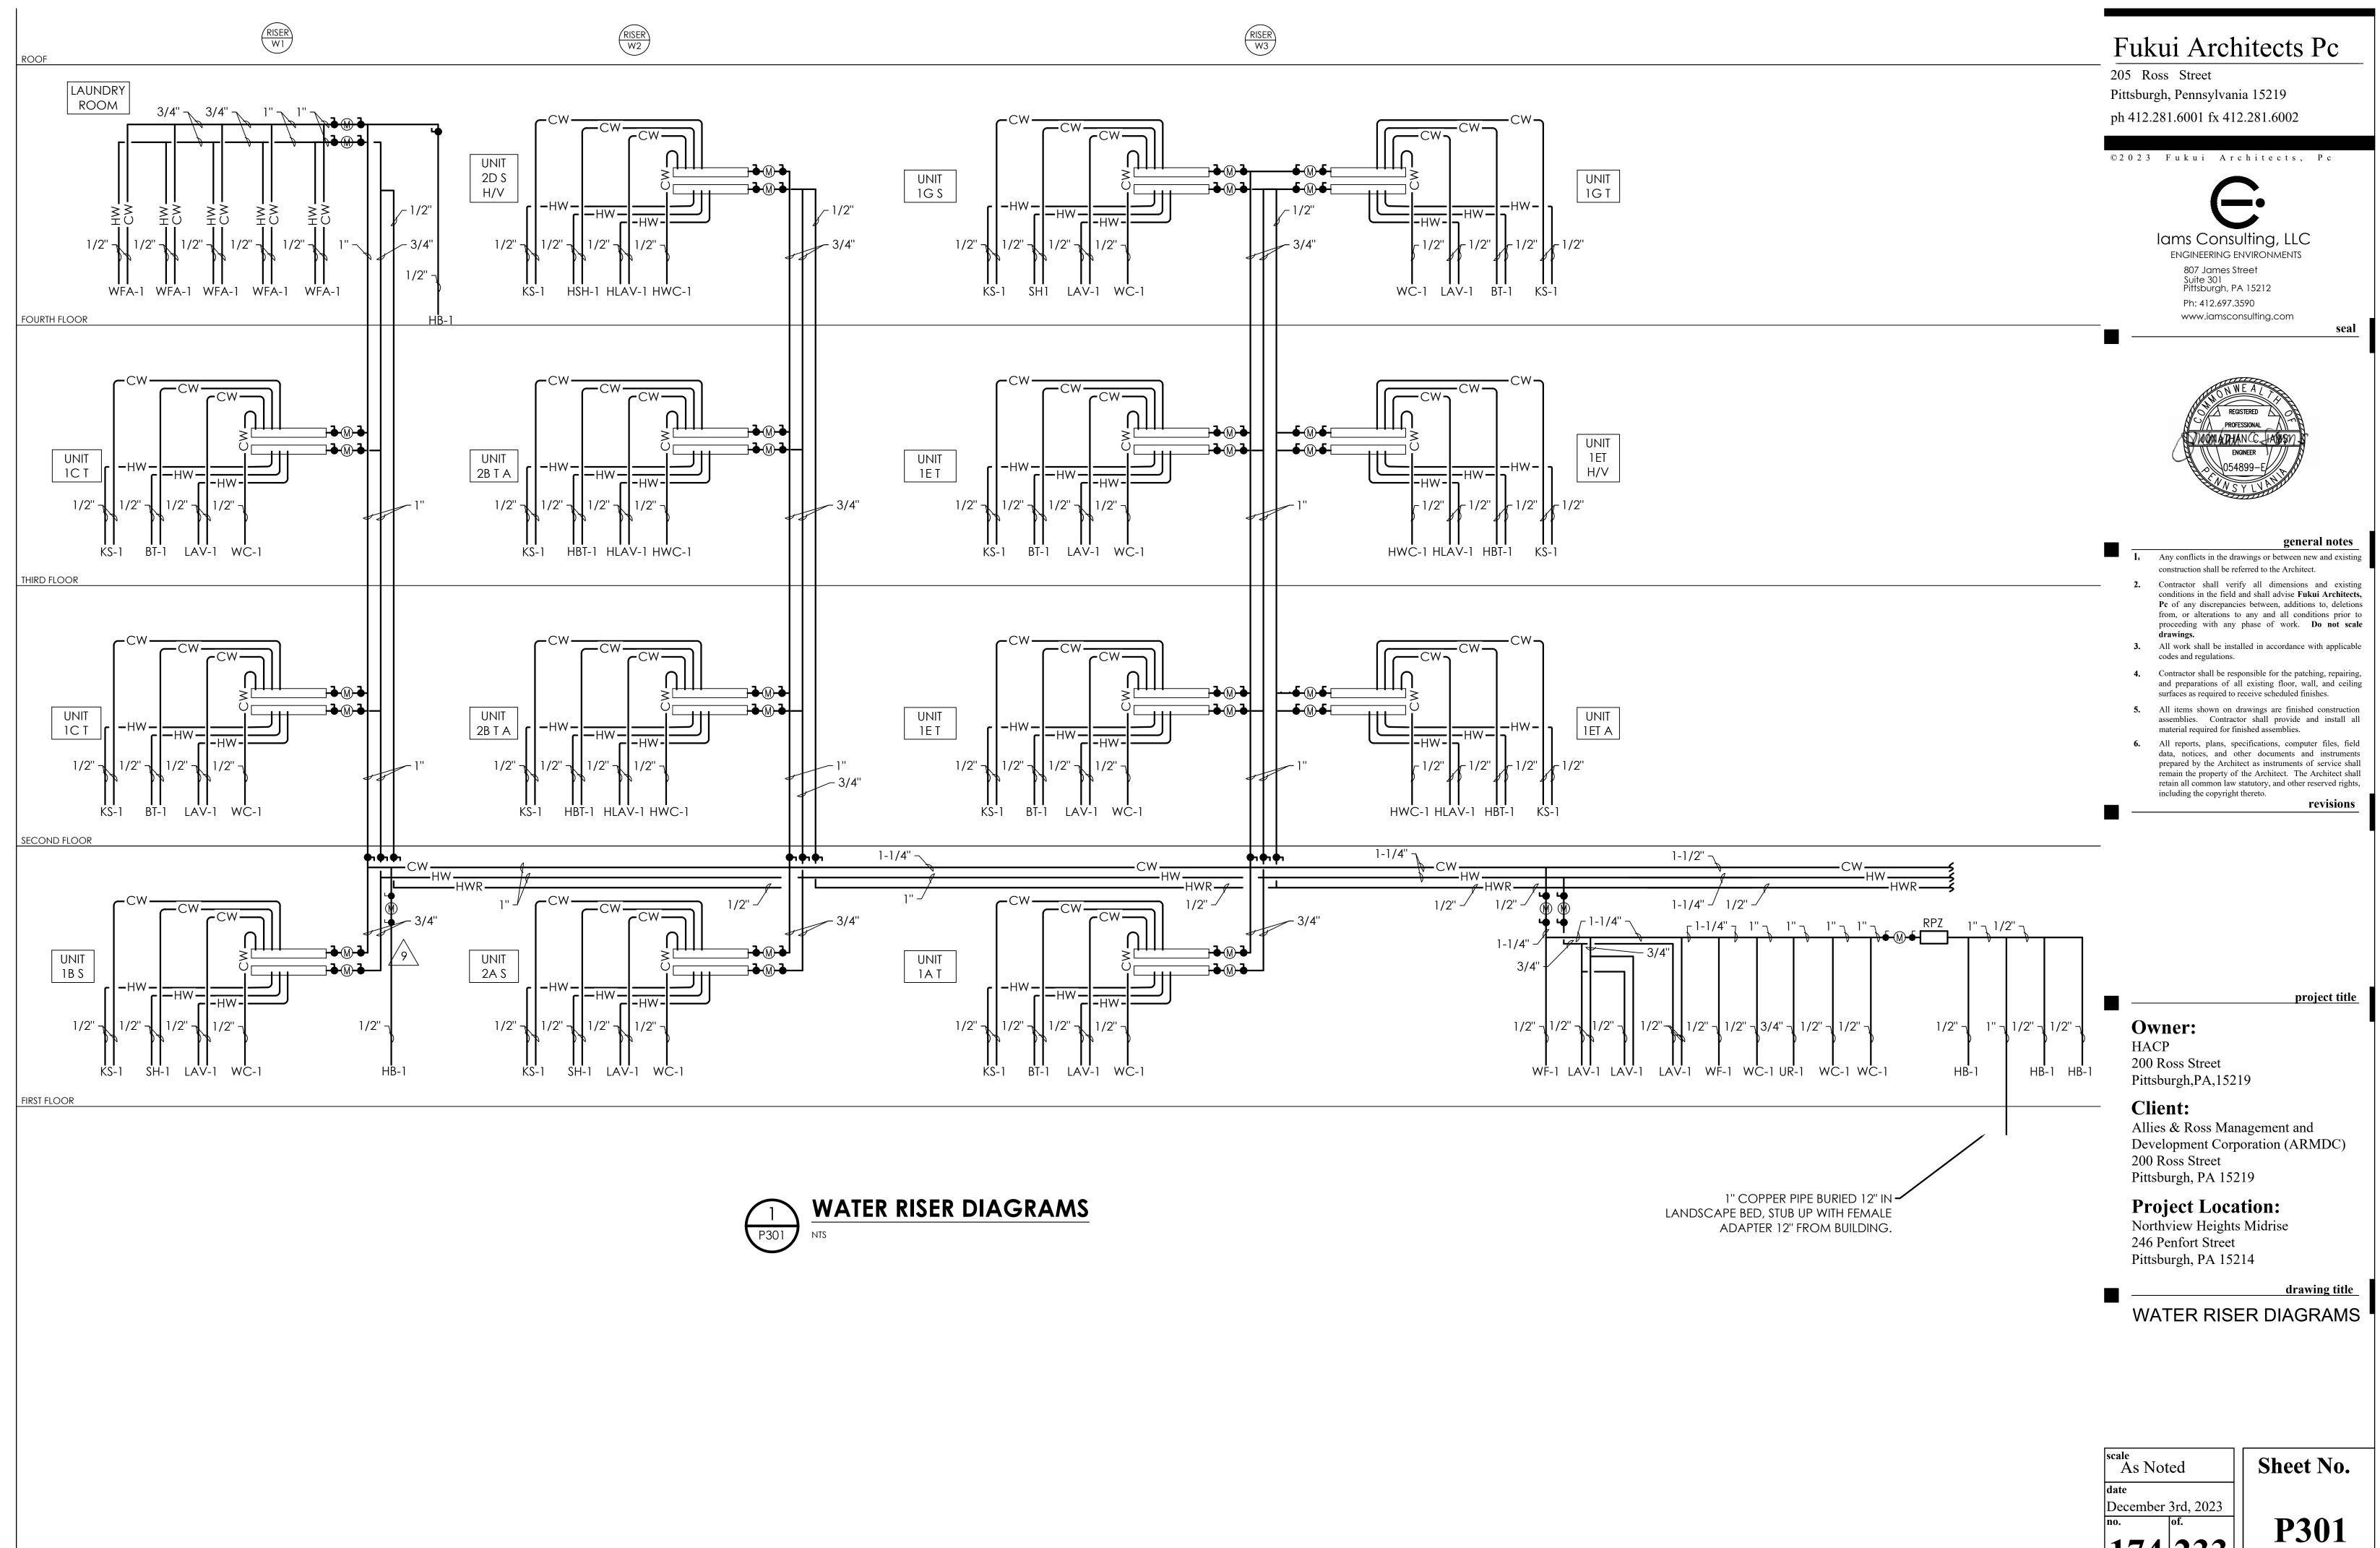

174 233 P301
Project #2040

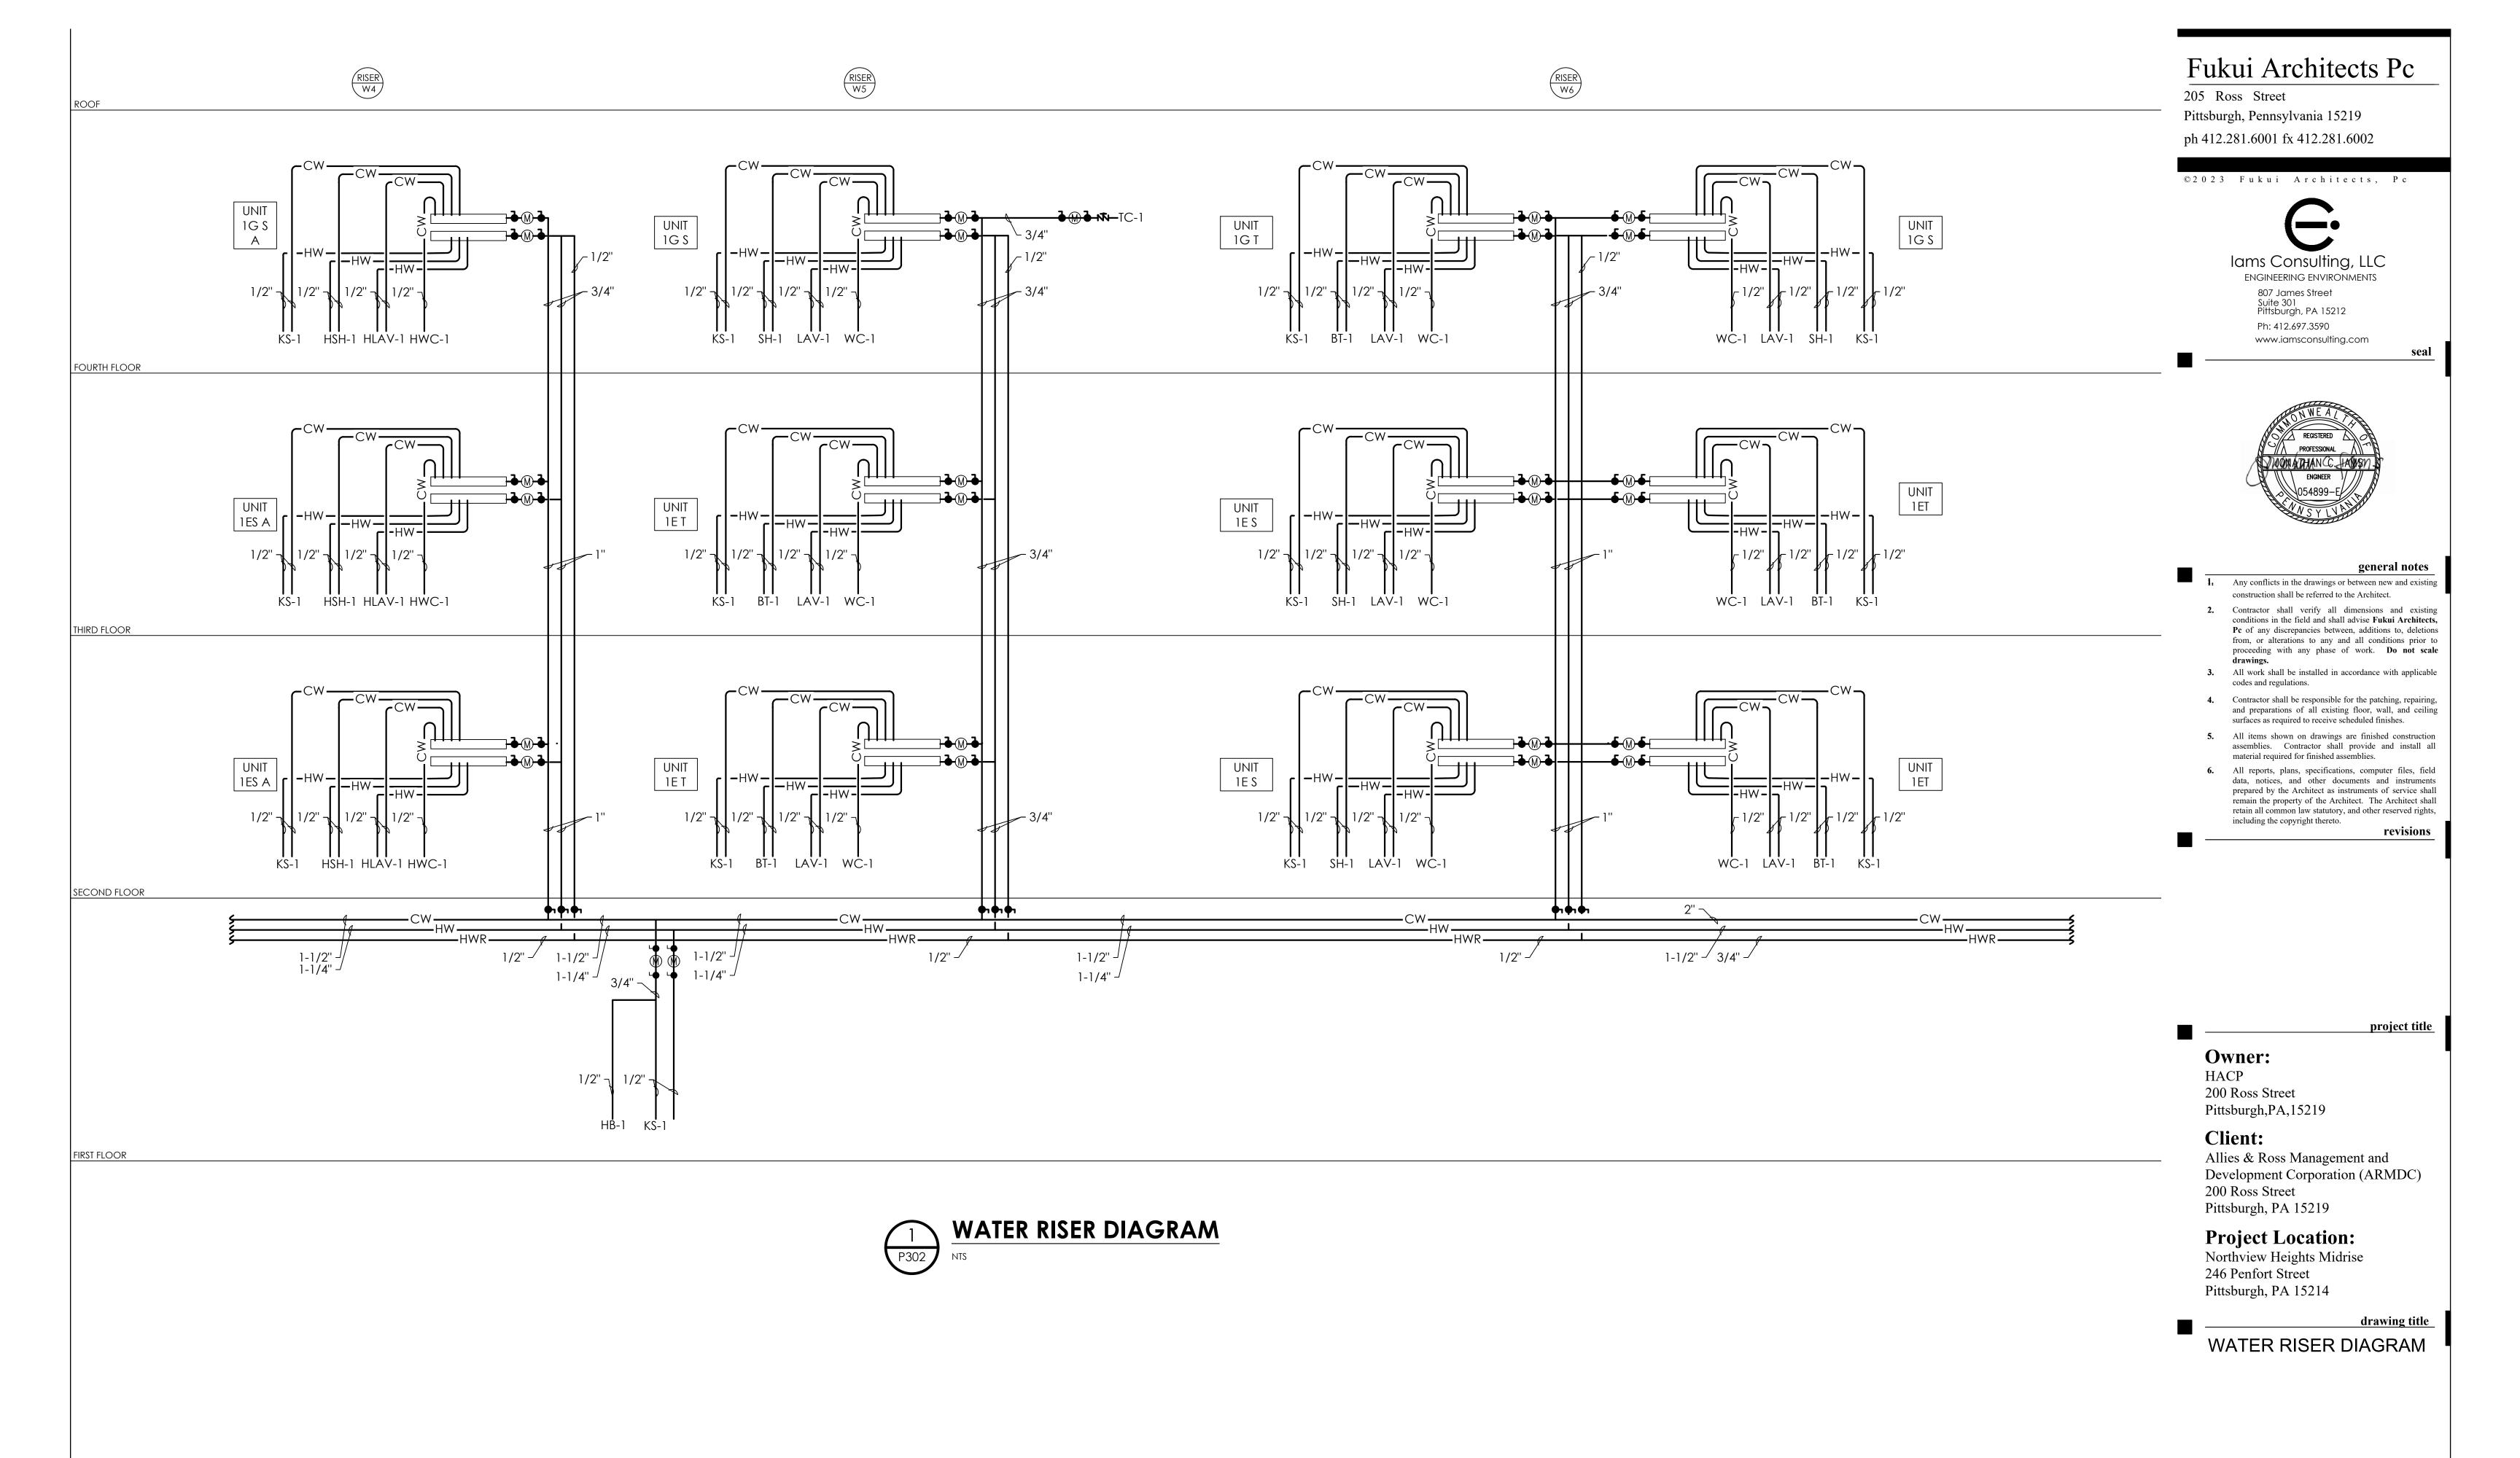


Scale As Noted


date
December 3rd, 2023

Sheet No.

175 233

P302

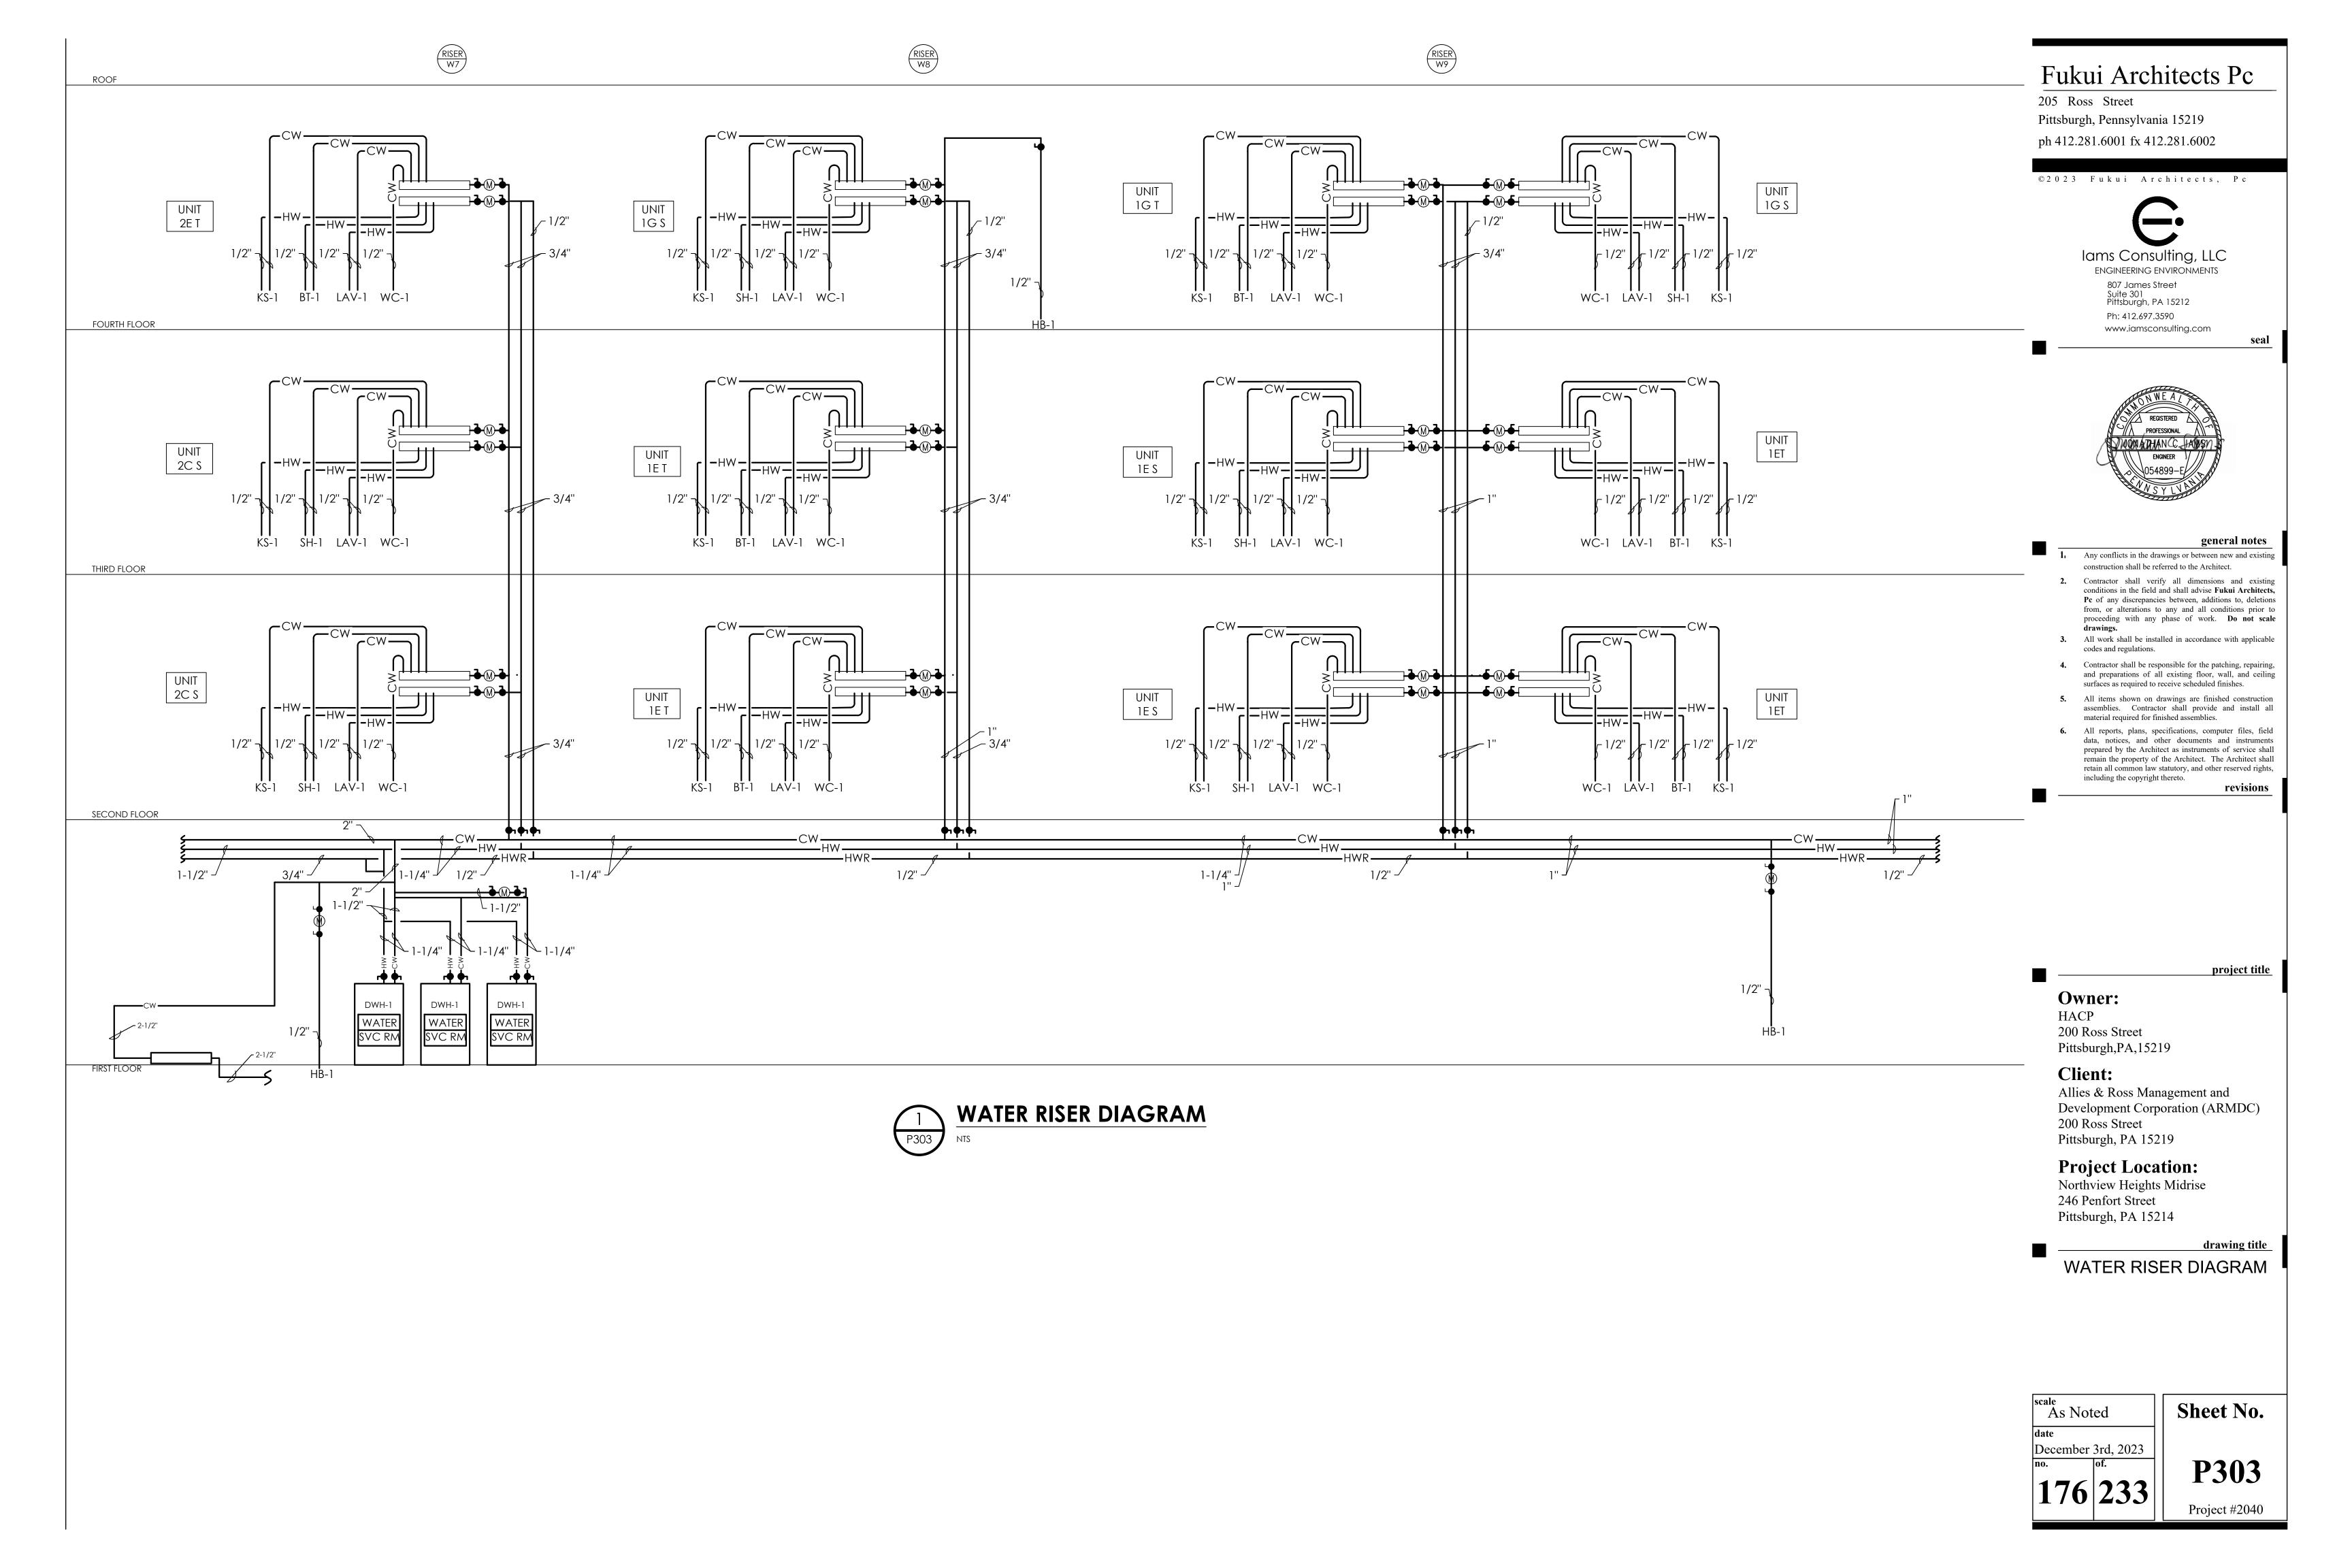

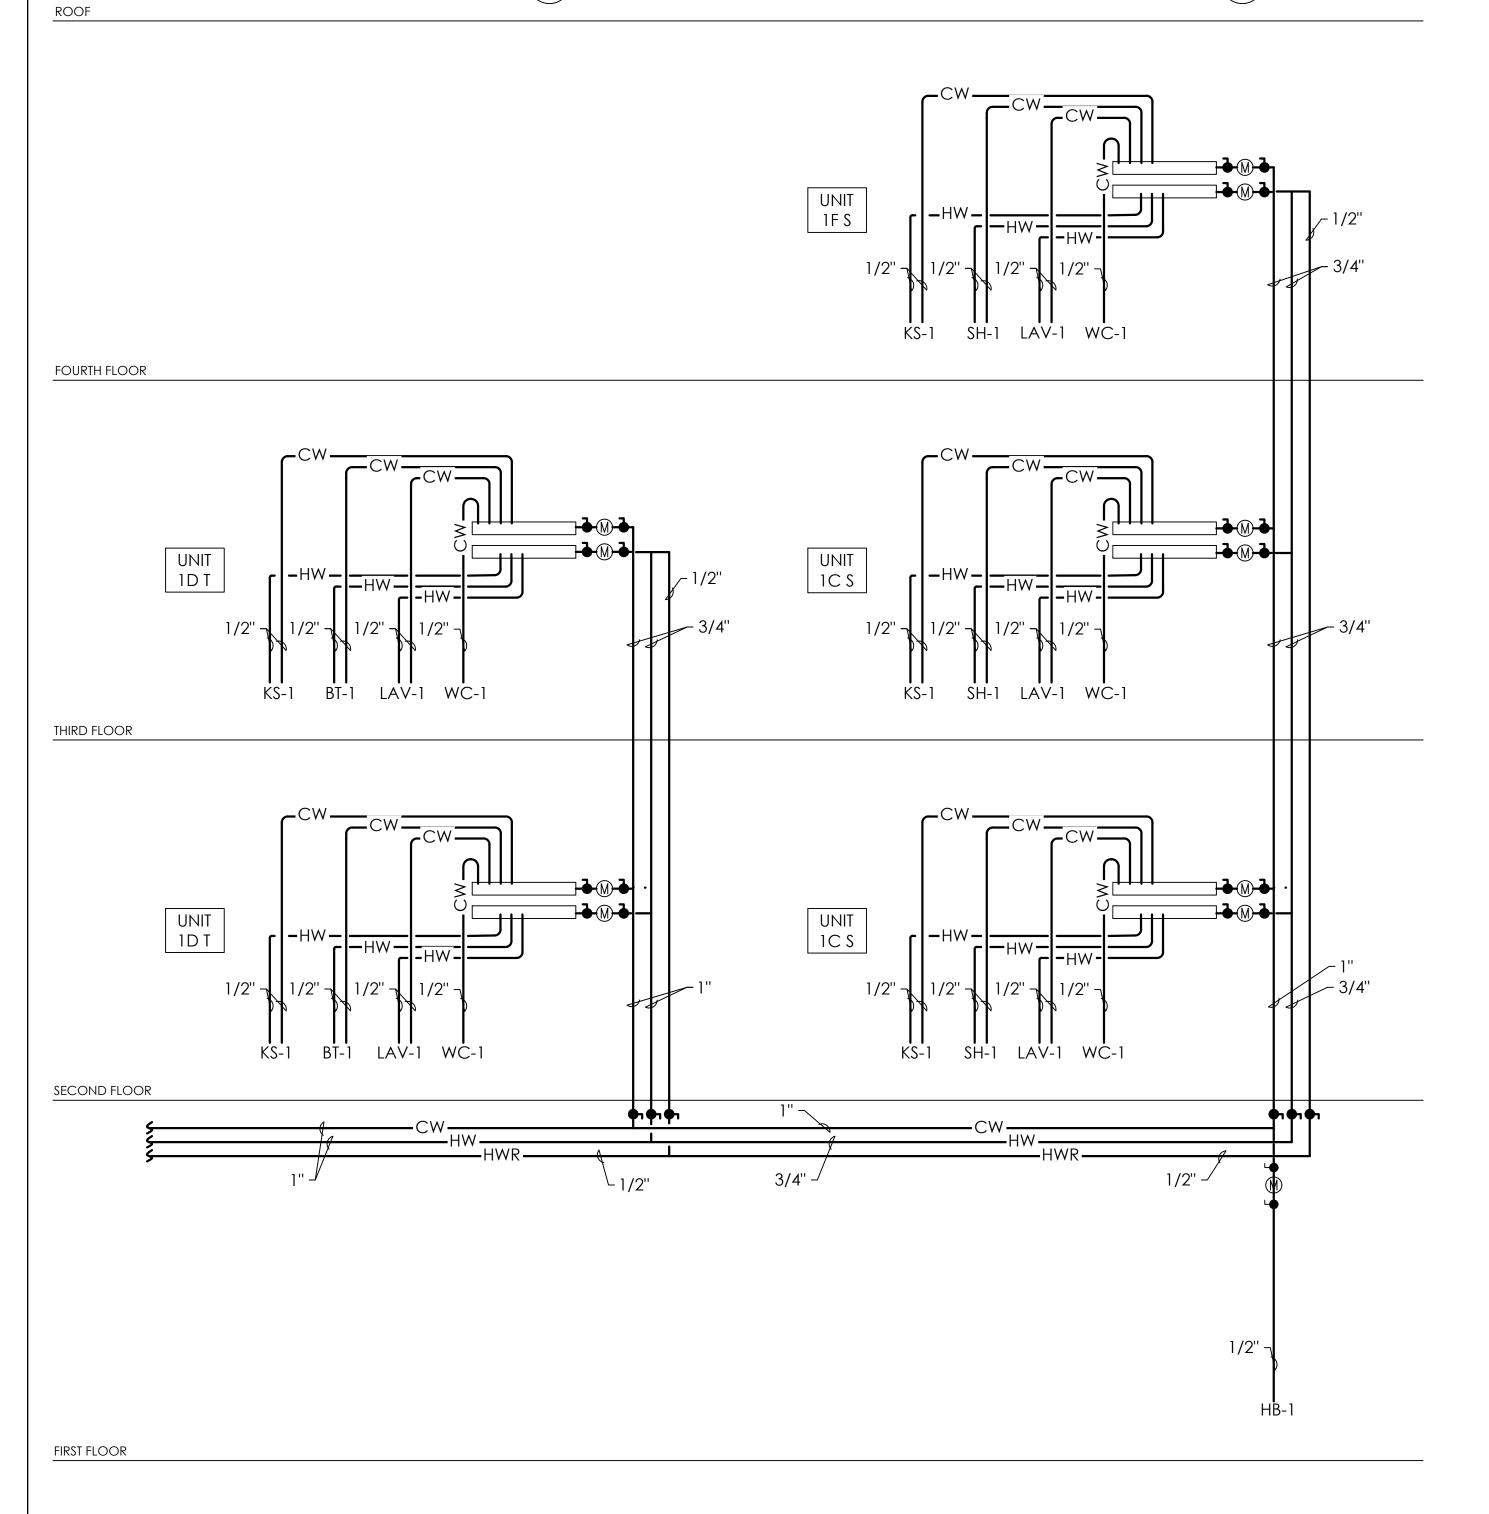



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drawing title


WATER RISER DIAGRAM

scale As Noted

December 3rd, 2023

P304

Sheet No.

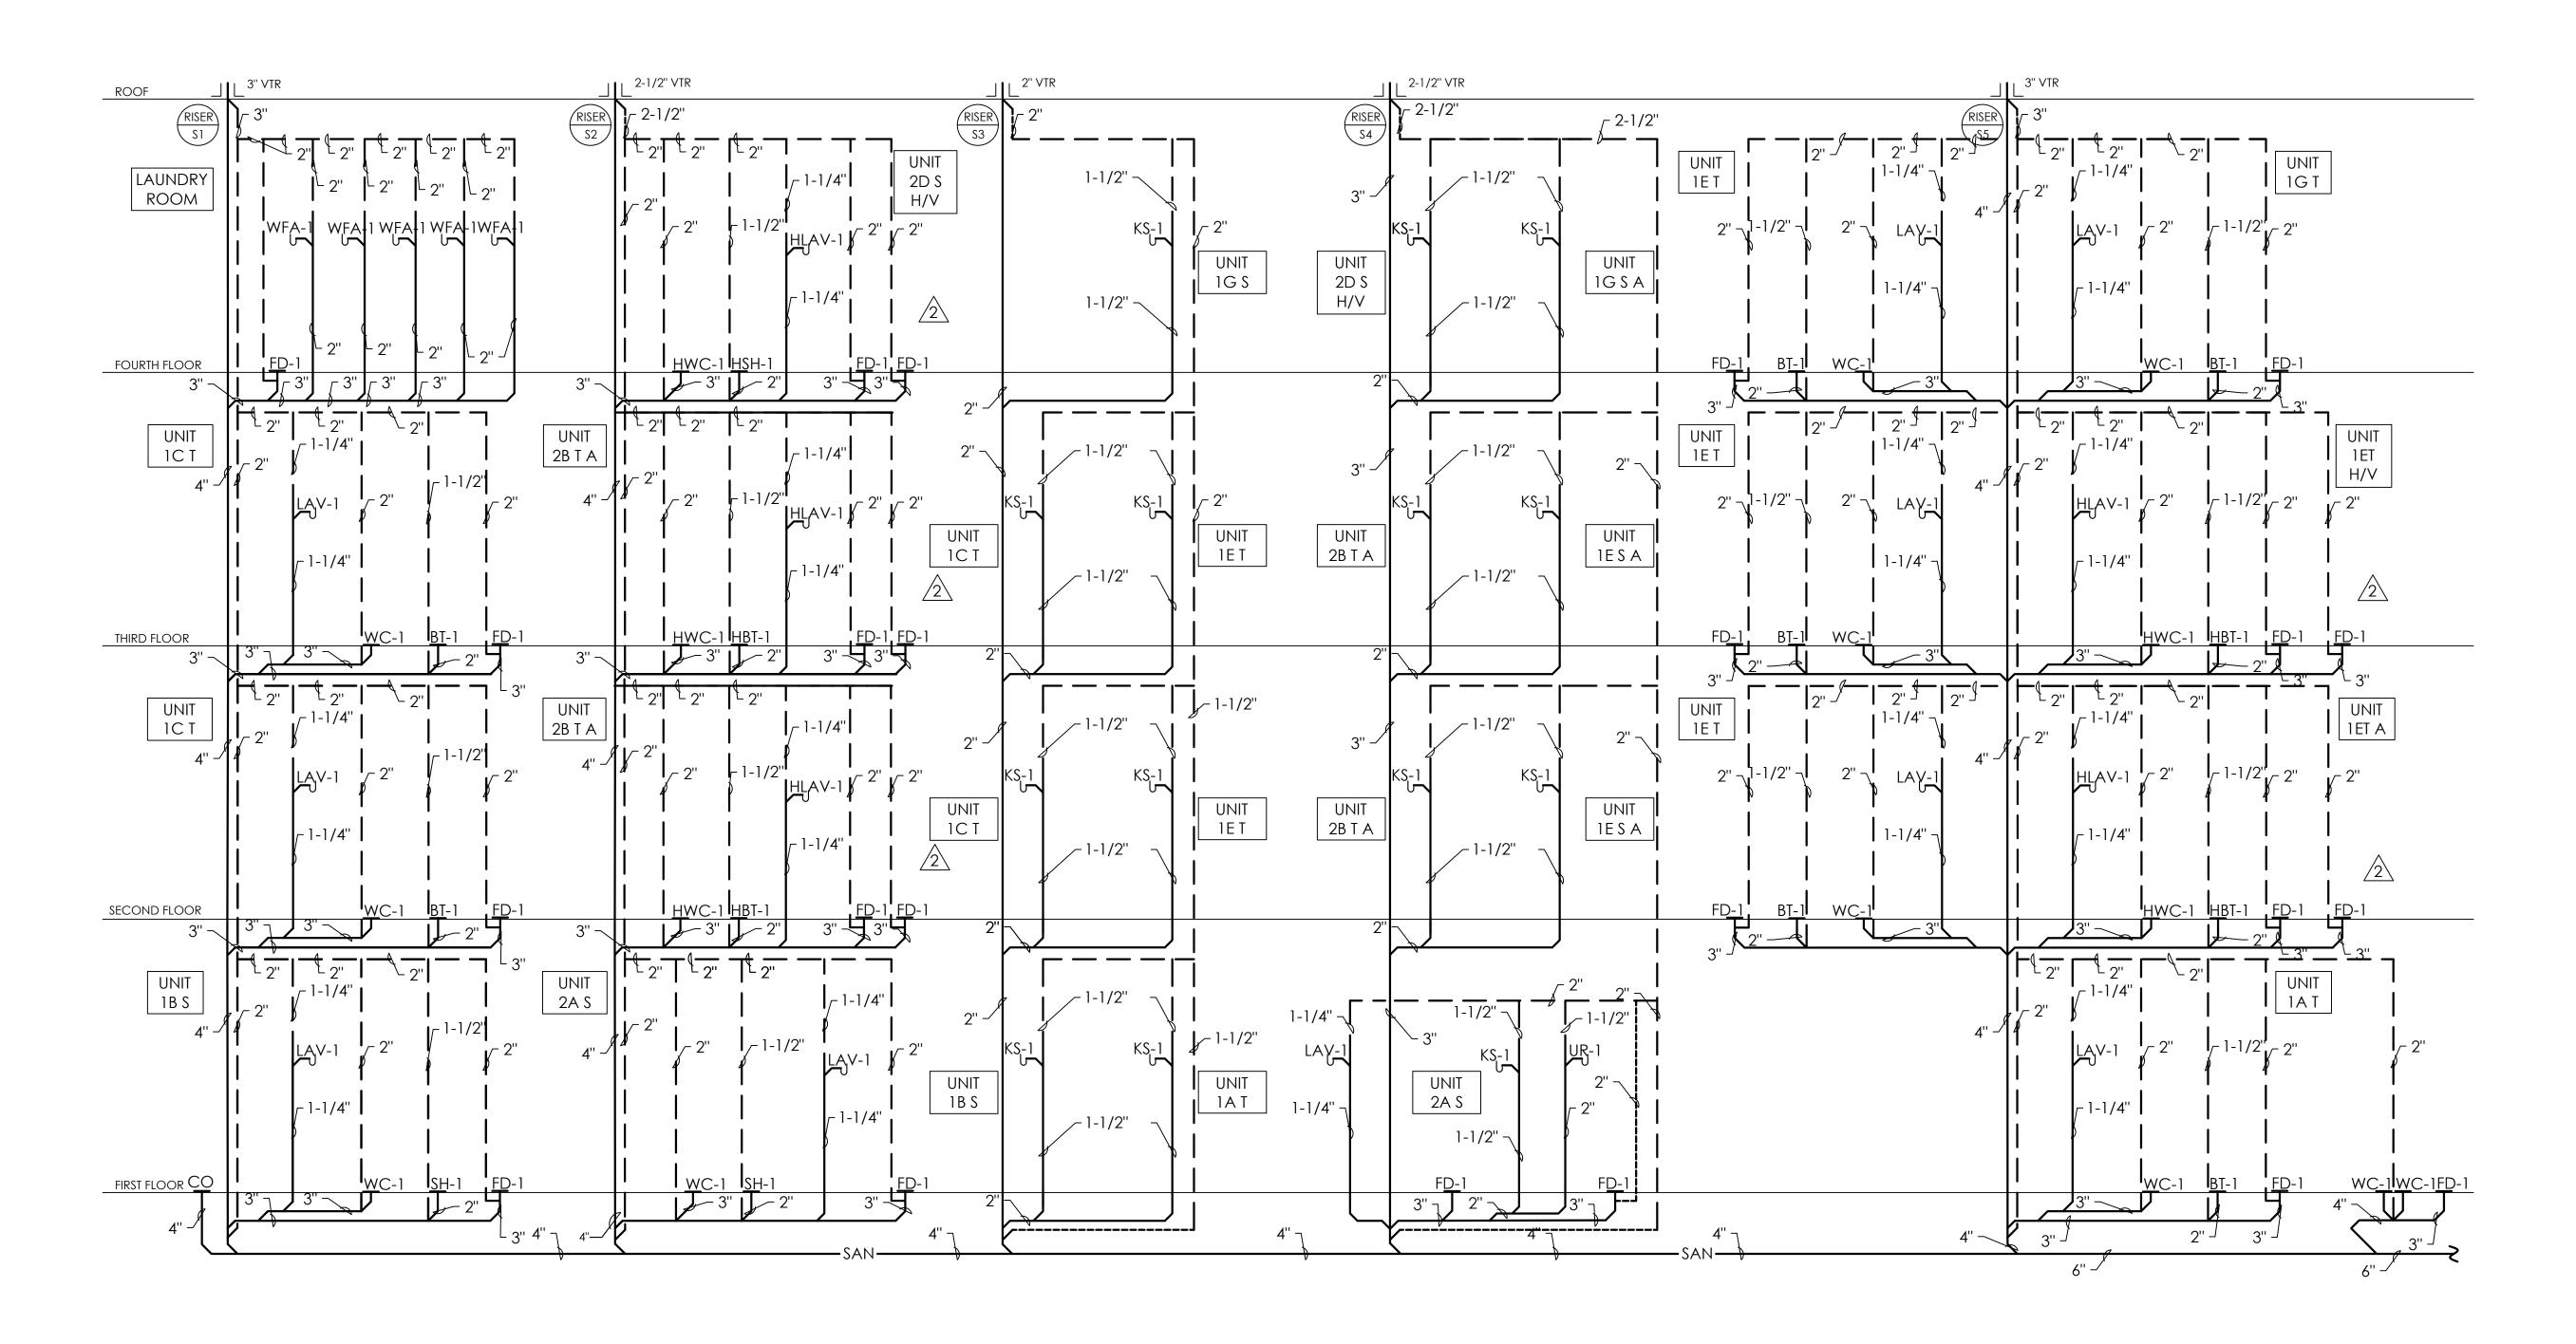



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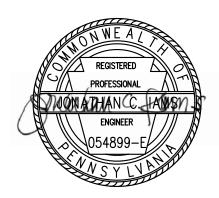
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### **Project Location:**

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drawing title

SANITARY RISER DIAGRAM


As Noted

December 3rd, 2023

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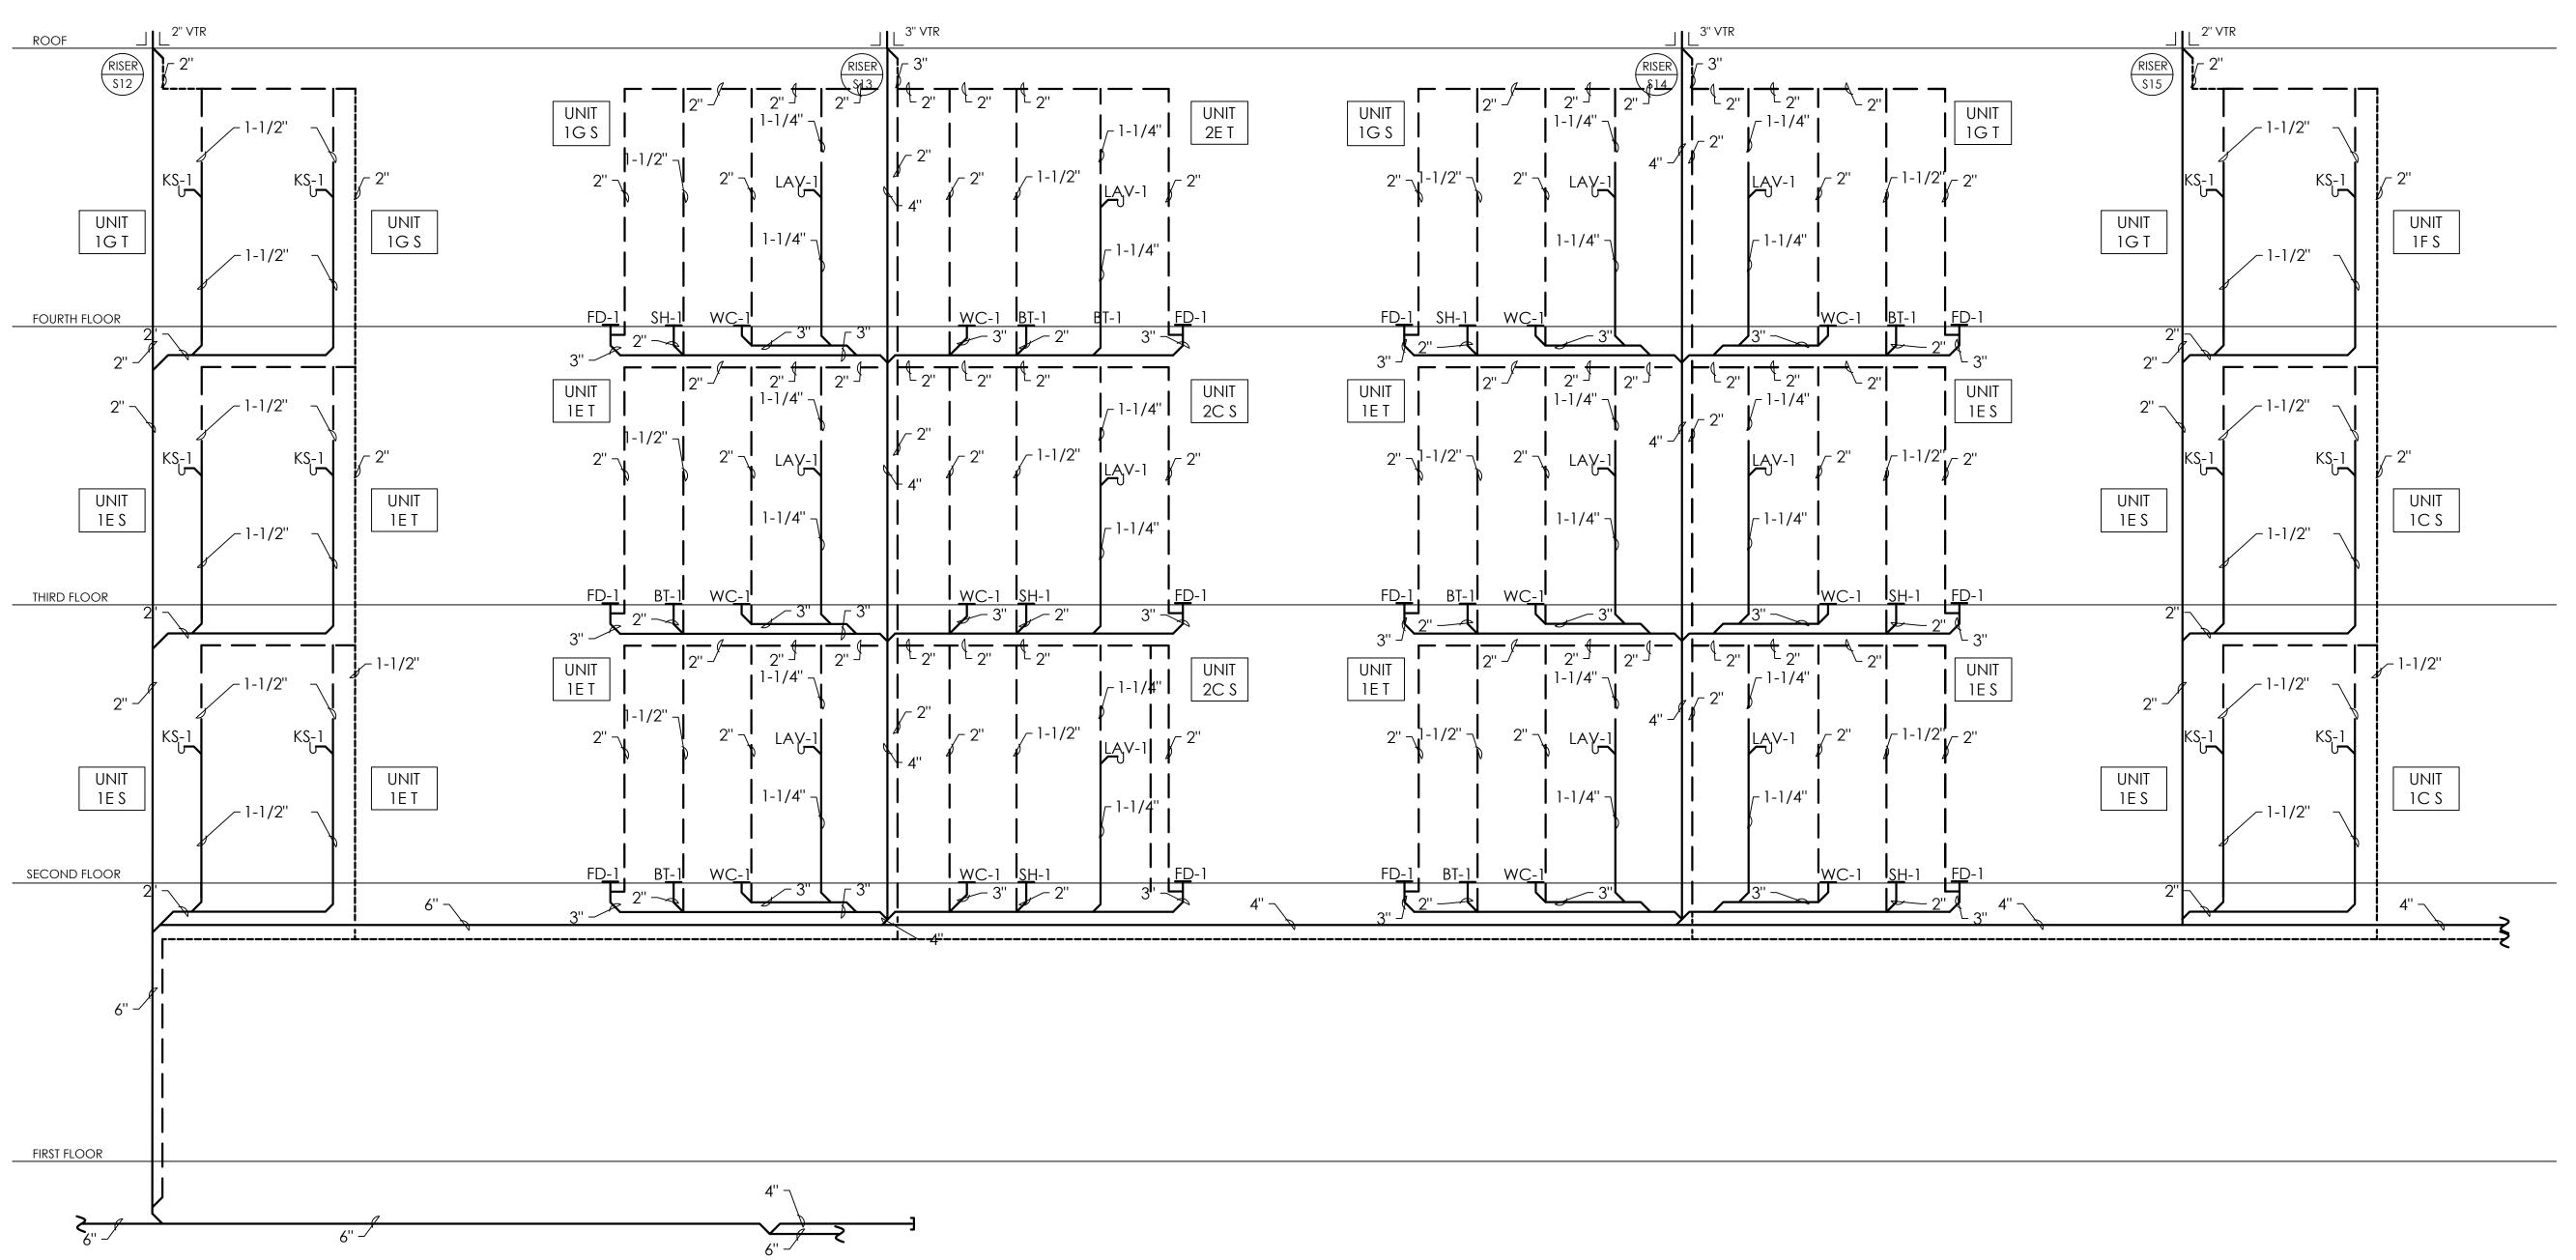
P305

Sheet No.

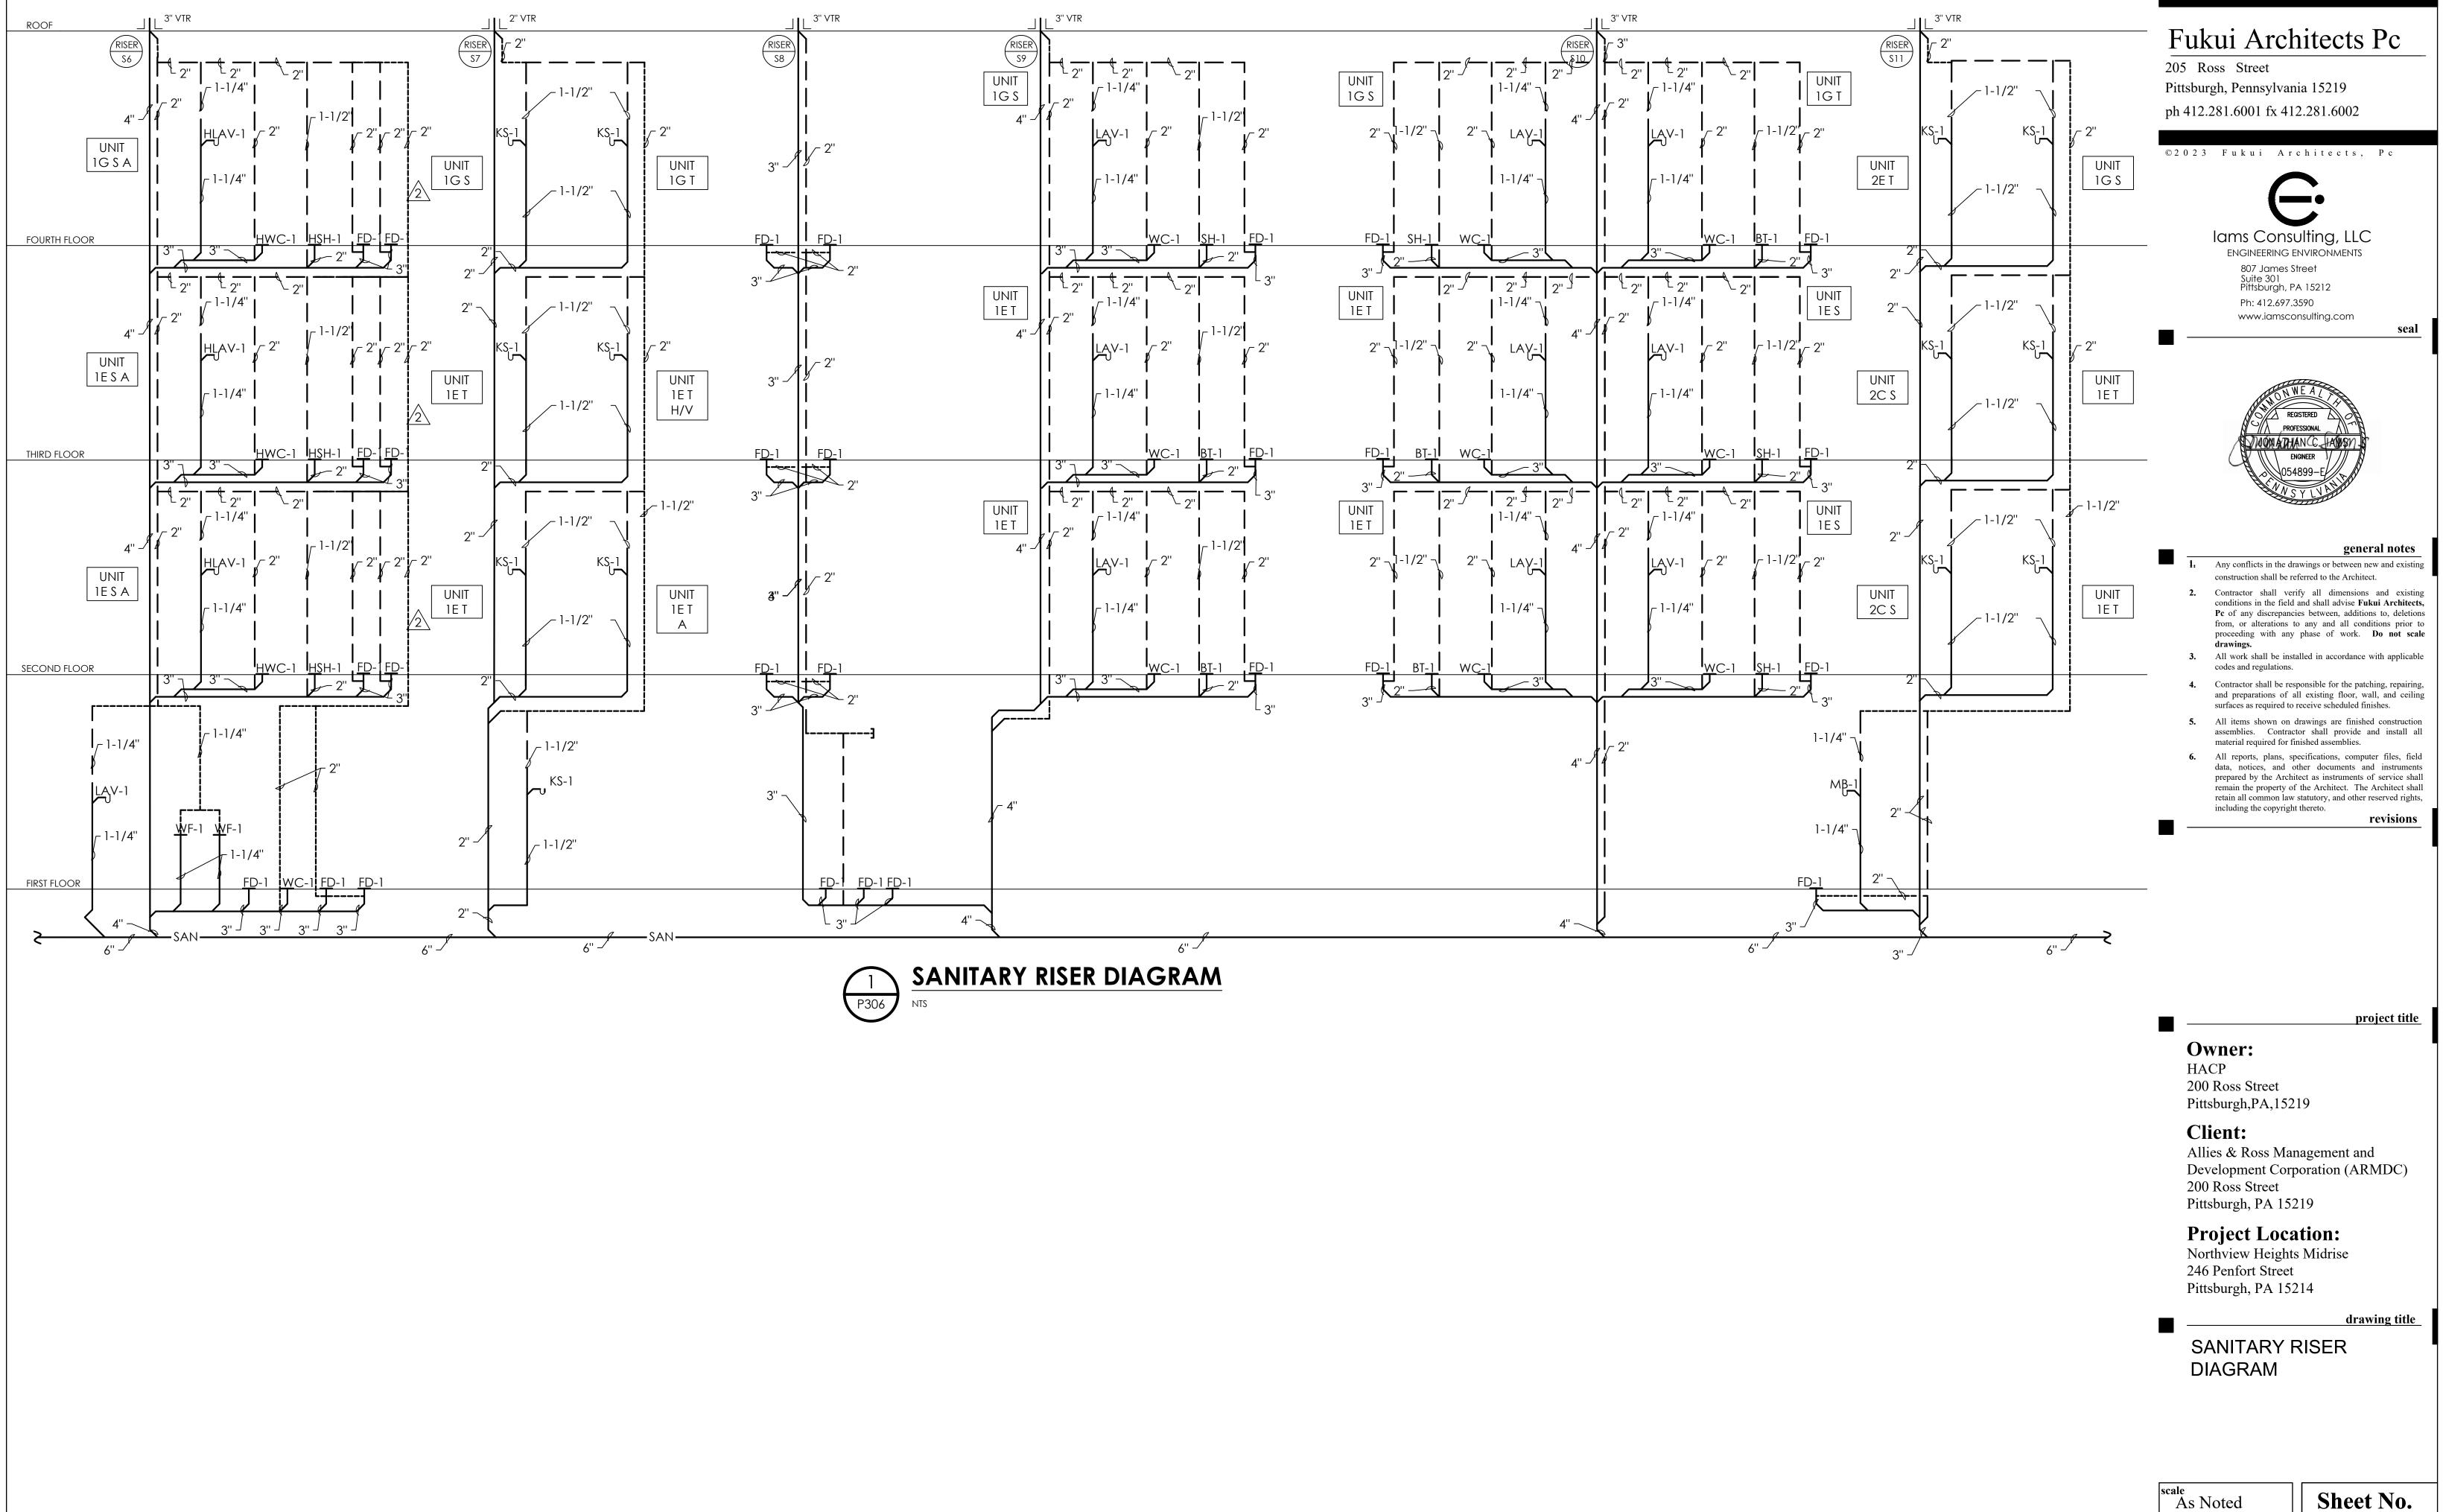

As Noted

| date | December 3rd, 2023 | | no. | | 179 | 233 | | Project #2040 | | |





## SANITARY RISER DIAGRAM

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drawing title


SANITARY RISER DIAGRAM

As Noted

December 3rd, 2023

**P307** 

Project #2040

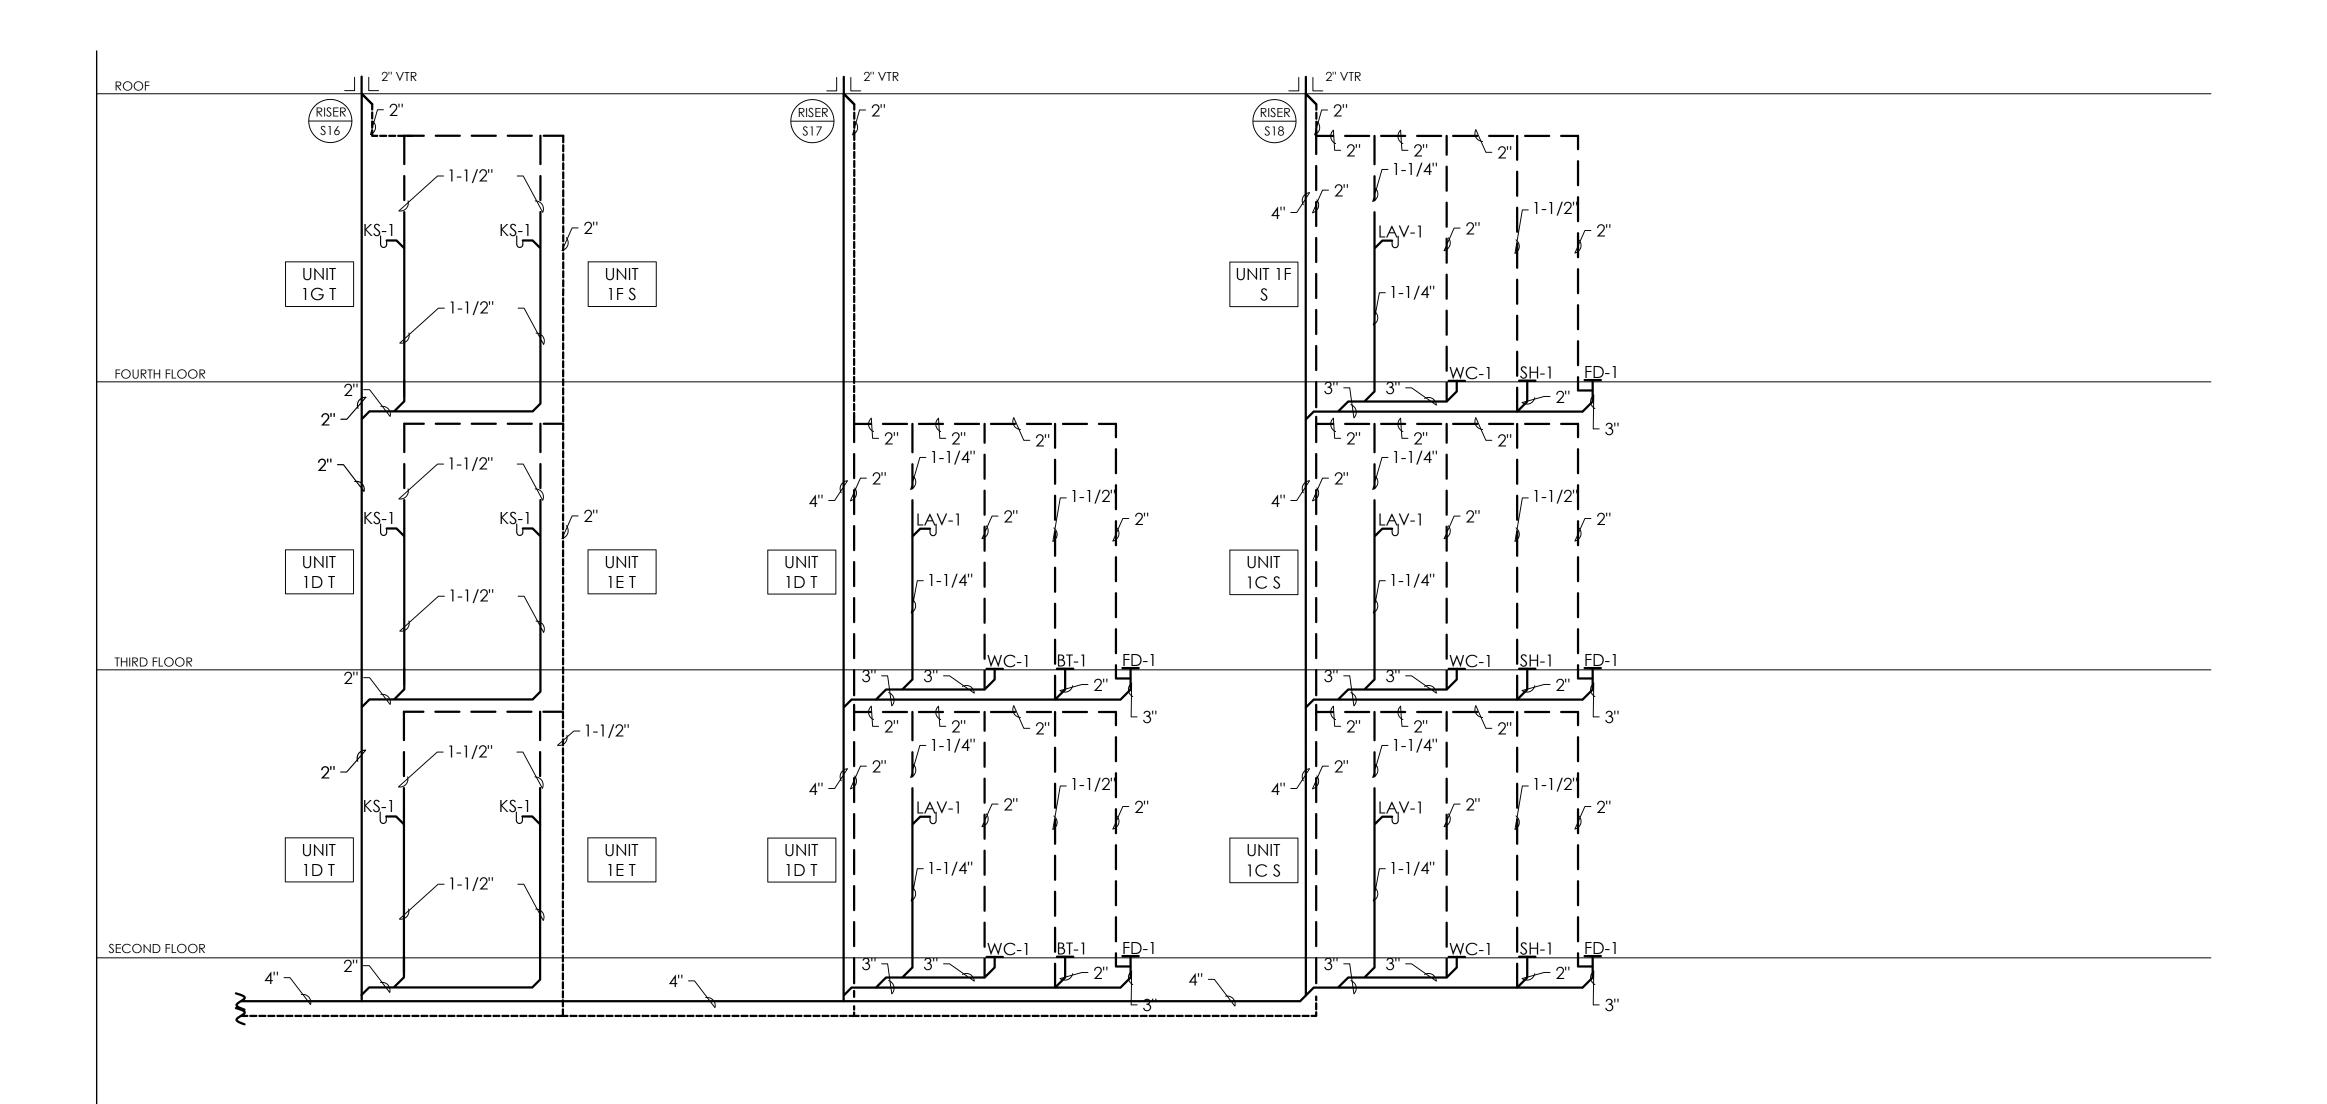

FIRST FLOOR



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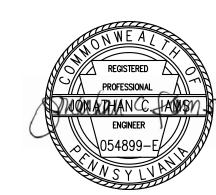


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### **Project Location:**

Northview Heights Midrise 246 Penfort Street Pittsburgh, PA 15214


drawing title


SANITARY RISER DIAGRAM

date
December 3rd, 2023


Sheet No.

P308

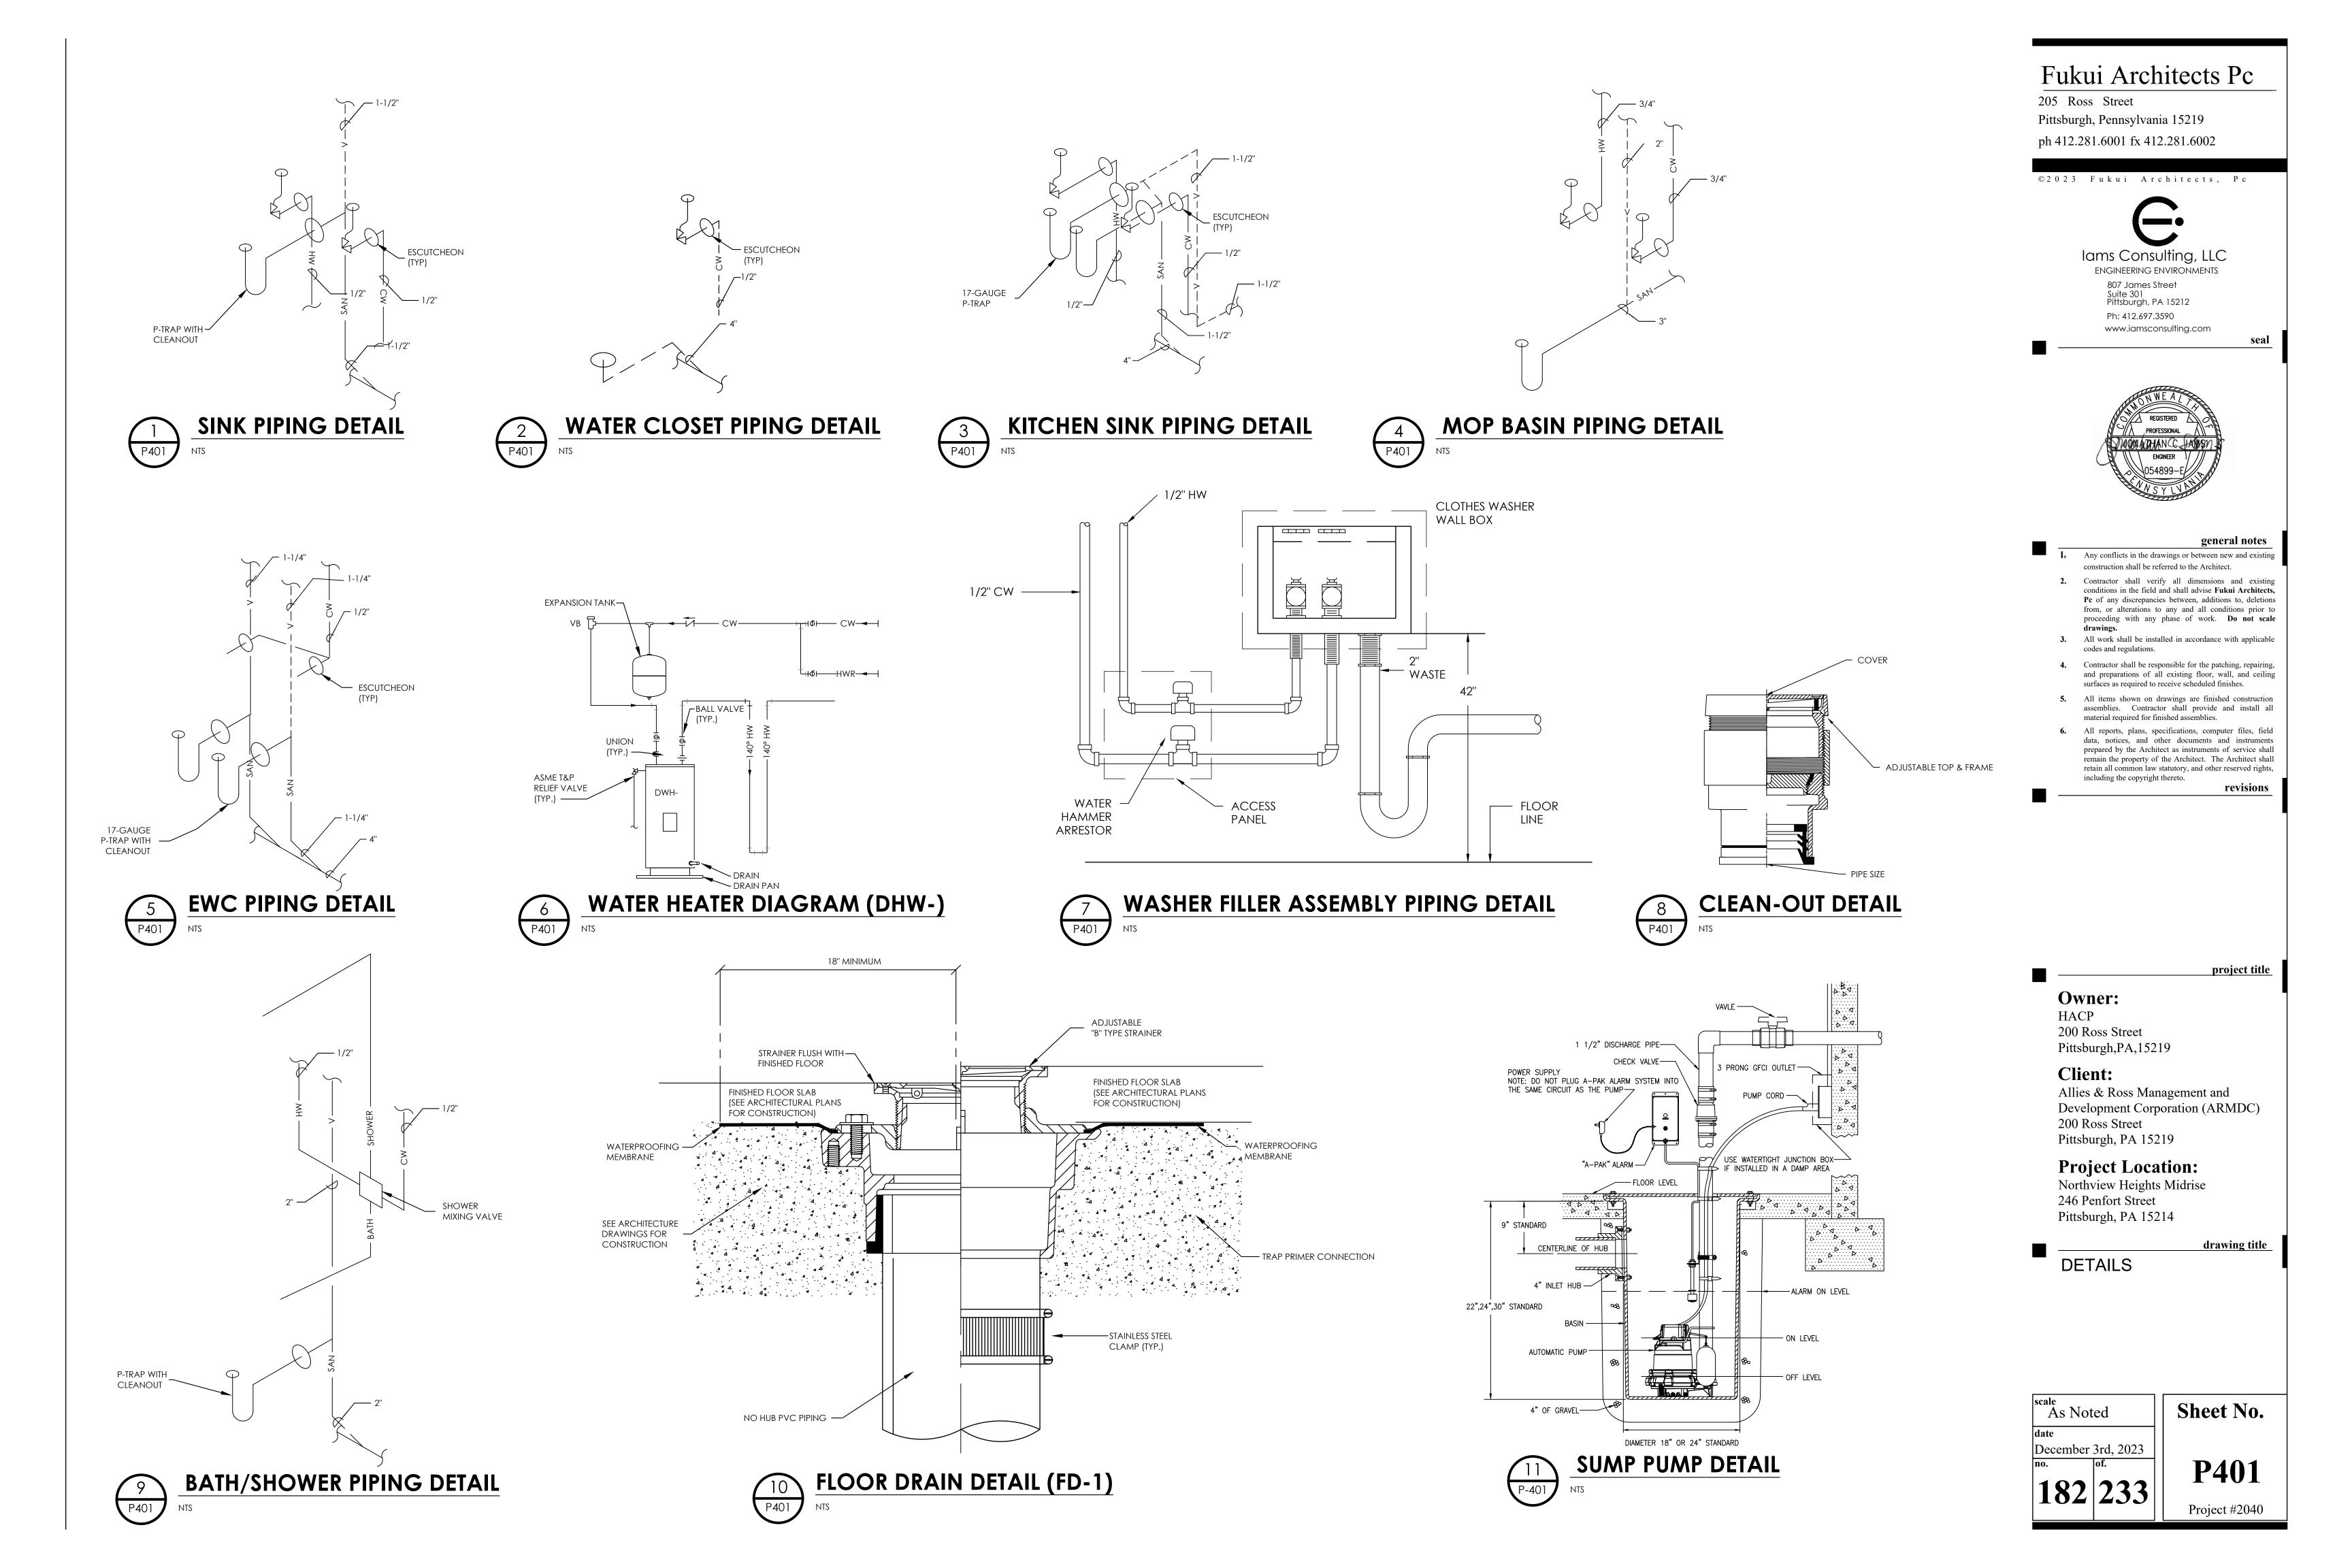


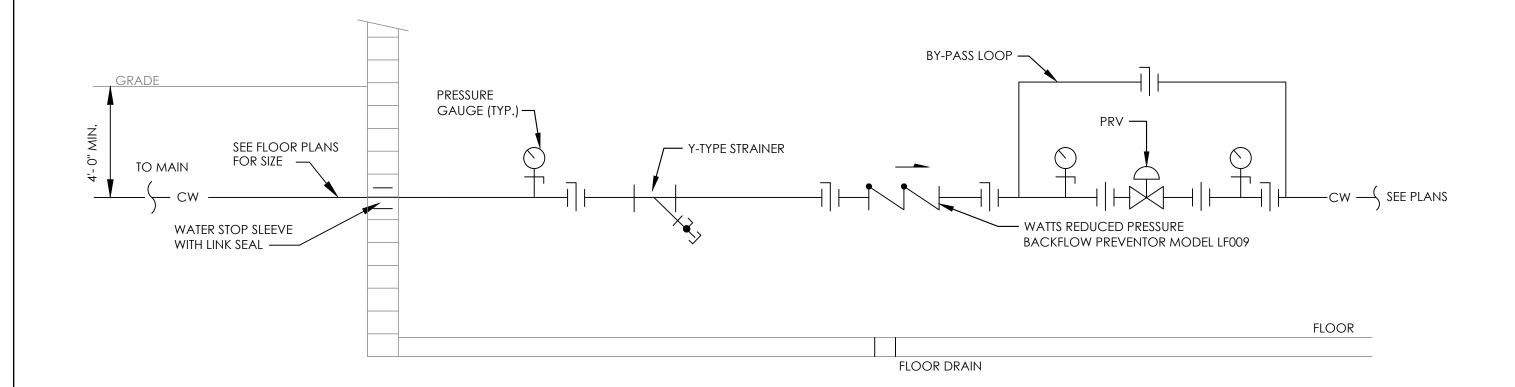

# WATER SERVICE ENTRANCE DIAGRAM NTS

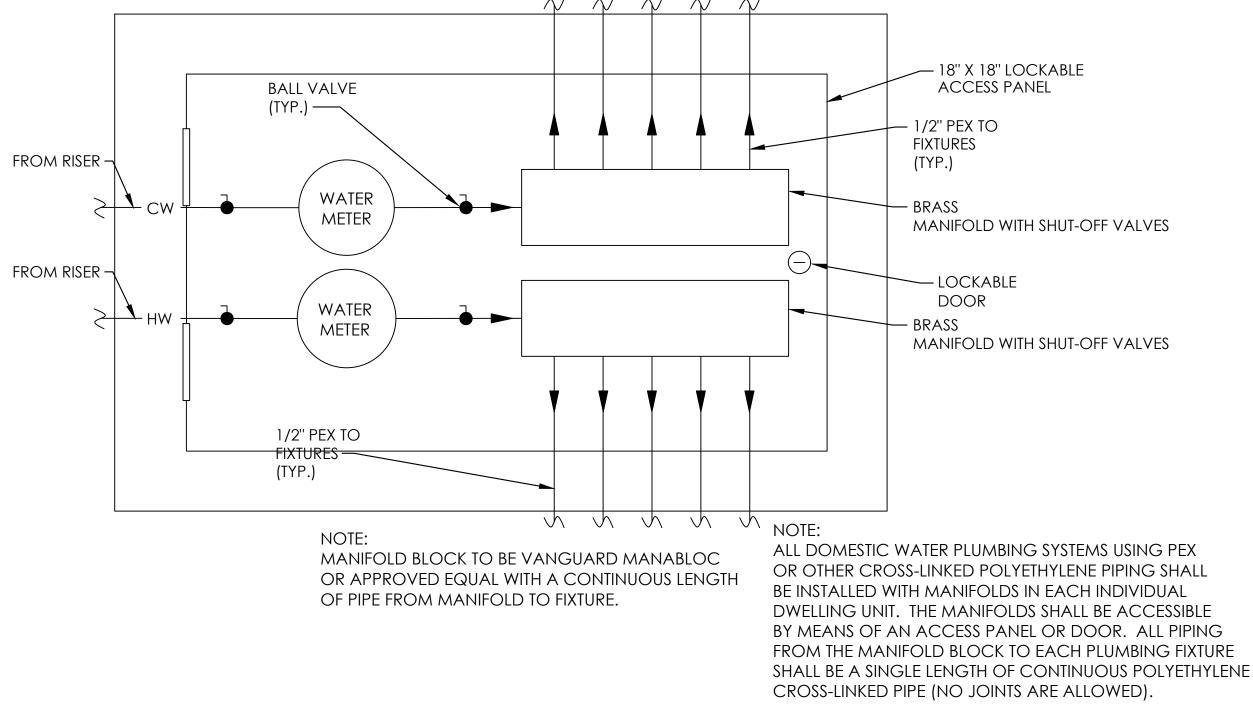




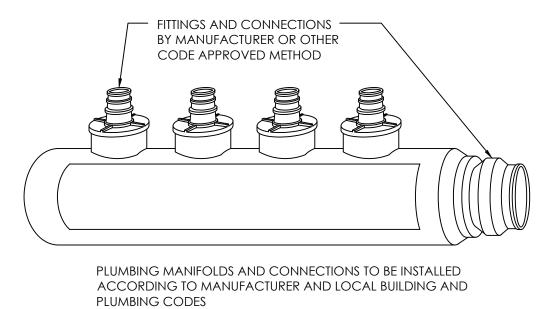

PEX MANIFOLD DETAIL

NTS

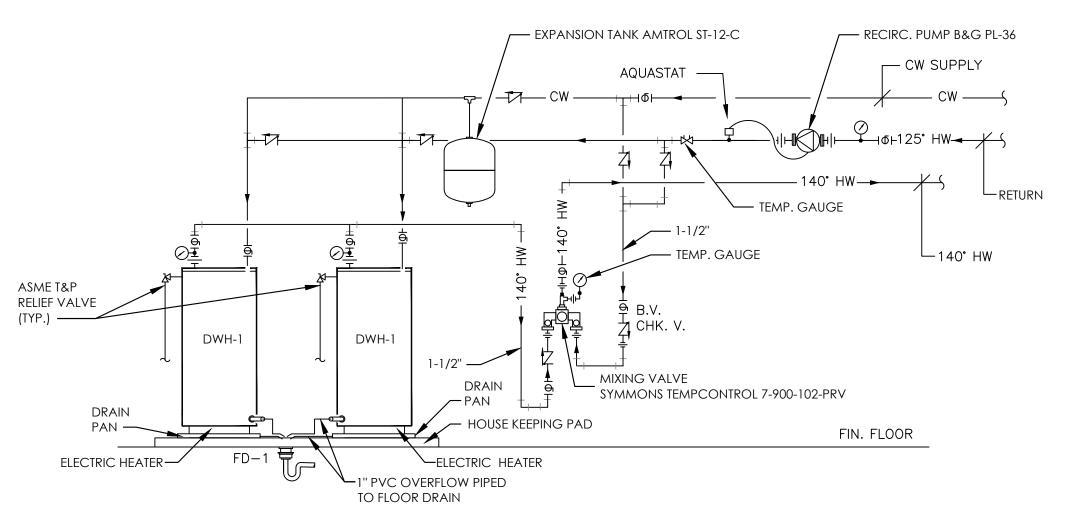



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## **Project Location:**

Northview Heights Midrise 246 Penfort Street Pittsburgh, PA 15214

drawing title

DETAILS

date
December 3rd, 2023
no. | of.

183 | 233

Sheet No.

P402

### SEAL AROUND CEILING — PENETRATIONS SEAL AROUND FLOOR— PENETRATIONS SUPPORT STRAP— SEAL AROUND CEILING — PENETRATIONS SEAL AROUND FLOOR PENETRATIONS — SUPPORT STRAP\_ SEAL AROUND — CEILING PENETRATIONS PVC OR ABS SUCTION PIPE FUTURE DIFFERENTIAL PRESSURE GAUGE. MAX 6' ABOVE FINISHED FLOOR SEAL AROUND FLOOR - FLUSH TO DRYWALL PENETRATIONS — ACCESS PANEL FOR PRESSURE GAUGE VAPOR-RETARDER MEMBRANE ADJOINING SHEETS OF **FLEXICRAFT** ADJOINING SHEETS OF SEALED AGAINST WALL AND MEMBRANE OVERLAPPED — FLEXIBLE MEMBRANE OVERLAPPED — AROUND PENETRATIONS AND SEALED COUPLING — AND SEALED SOIL-GAS-RETARDER MEMBRANE — SEALED AGAINST WALL AND 1 TO 1-1/2" WASH CRUSHED . 4" PERFORATED RIGID OR PVC CAP AT END OF PIPE AROUND PENETRATIONS STONE WITH A MINIMUM IF FLEXIBLE DRAIN PIPE TO AVOID CLOGGING 2" DEPTH AROUND PIPE 4" PERFORATED RIGID OR FLEXIBLE DRAIN PIPE WITH HOLES ON ALL SIDES

EXHAUST (10' FROM OPENINGS INTO CONDITIONED SPACE OF BUILDING)

REQUIRED IF POST-CONSTRUCTION

— ELECTRICAL

JUNCTION

FUTURE SUCTION FAN (ONLY-

TEST DEMANDS ACTIVE SYSTEM.)


SEAL AROUND ROOF

PENETRATION

12" MIN. ABOVE ROOF

### **RADON GENERAL NOTES:**


- 1. ALL RADON PIPING TO BE SCHEDULE 40 PERFORATED PVC.
- 2. PROVIDE 6" SLIP JOINT ON VERTICAL TEE TO ACCOMMODATE FOR SETTLING AND MOVEMENT IN THE PIPE.
- 3. ALL SOLID HORIZONTAL PIPING IS TO BE SLOPED TO PERFORATED PIPE TO AVOID CONDENSATION BUILD-UP.
- 4. ARCHITECT TO FINALIZE TESTING PORT LOCATIONS AND CAPS.
- 5. SUCTION FAN TO BE SELECTED AND INSTALLED BY OTHERS IF APPLICABLE AFTER TESTING AND CALCULATIONS ARE AVAILABLE.
- 6. LOW-SHRINK CONCRETE SLABS TO BE POURED TIGHT TO WALLS AND PENETRATING OBJECTS. WHEN EXPANSION JOINT MATERIAL IS USED, SEAL JOINTS USING POLYURETHANE CAULK OR EQUIVALENT.
- 7. RADON CONTRACTOR IS RESPONSIBLE FOR SEALING ALL RADON PIPING ABOVE CONCRETE SLAB INCLUDING CAPPING AND SEALING ALL TESTING AND SAMPLE PORTS.
- 8. LOCATION OF ACCESS PANEL FOR DEFERENTIAL PRESSURE GAUGE TO BE FINALIZED BY ARCHITECTURE.

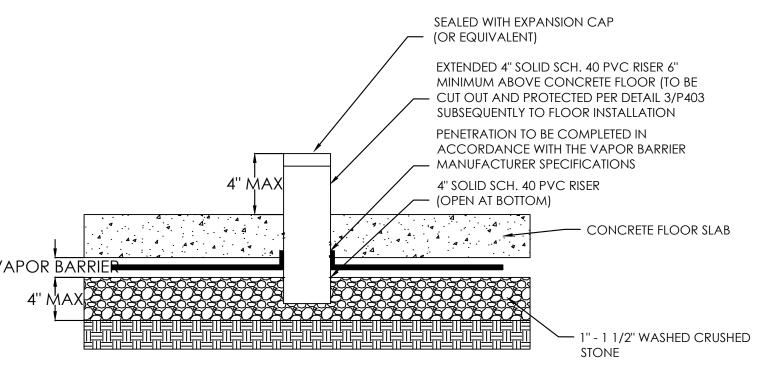

NOTES:

1. DESIGN OF FOUNDATION, SLAB AND RELATED FEATURES REFER TO ARCHITECTURAL AND STRUCTURAL DRAWINGS.



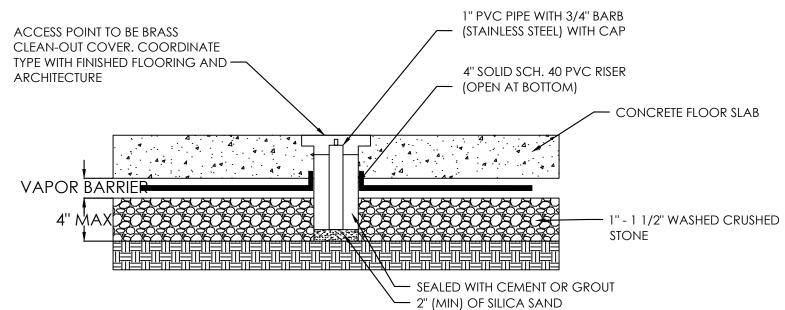

NOTES:

1. DESIGN OF FOUNDATION, SLAB AND RELATED FEATURES REFER TO ARCHITECTURAL

AND STRUCTURAL DRAWINGS.

2. SAMPLE POINT TO BE COMPLETED AFTER CONSTRUCTION OF CONCRETE FLOOR AT THE SUB-SLAB SAMPLE POINT

THE SUB-SLAD SAMIFLE FOINT



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project title

## Owner: HACP

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#### **Client:**

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Pittsburgh, PA 15219

#### **Project Location:**

Northview Heights Midrise 246 Penfort Street Pittsburgh, PA 15214

drawing title

RADON SYSTEM DETAILS

As Noted

date

December 3rd, 2023

Sheet No.

P403



PLUMBING PIPING MATERIAL AND INSULATION SCHEDULE							
TYPE	SYSTEM	MATERIAL	FITTINGS	JOINTS	PIPE SIZE	INSULATION	
CW	POTABLE COLD WATER	COPPER TUBING: ASTM B88, TYPE 'L', HARD	COPPER FITTINGS: ASME B16.22, WROUGHT	ASTM B32, SOLDER, GRADE 95TA, LEAD FREE	ALL SIZES	1" FIBERGLASS INSULATION FOR 1" AND LOWER	
CW	POTABLE COLD WATER (APARTMENT UNITS)	PEX-a TUBING	PEX-a FITTINGS: ASTM F1960		ALL SIZES	1.5" FIBERGLASS INSULATION FOR 1.5" PIPES AND HIGHER	
HW	POTABLE HOT WATER	COPPER TUBING: ASTM B88, TYPE 'L', HARD	COPPER FITTINGS: ASME B16.22, WROUGHT	ASTM B32, SOLDER, GRADE 95TA, LEAD FREE	ALL SIZES	1" FIBERGLASS INSULATION FOR 1" AND LOWER	
HW	POTABLE HOT WATER (APARTMENT UNITS)	PEX-a TUBING	PEX-a FITTINGS: ASTM F1960		ALL SIZES	1.5" FIBERGLASS INSULATION FOR 1.5" PIPES AND HIGHER	
G	NATURAL GAS	SCHEDULE 40 THREADED STEAL	SCHEDULE 40 THREADED STEAL	THREADED	ALL SIZES	NO INSULATION	
SAN	BELOW GRADE SANITARY	SCHEDULE 40 PVC	SCHEDULE 40 PVC	GLUED	ALL SIZES	NO INSULATION	
SAN	Sanitary	SCHEDULE 40 PVC	PVC	GLUED	ALL SIZES	NO INSULATION	
٧	VENT	SCHEDULE 40 PVC	PVC	GLUED	ALL SIZES	NO INSULATION	
ST	BELOW GRADE STORM	SCHEDULE 40 PVC	PVC	GLUED	ALL SIZES	NO INSULATION	
RWC	ABOVE GRADE STORM	SCHEDULE 40 PVC	PVC	GLUED	ALL SIZES	1" FIBERGLASS INSULATION FOR HORIZONTAL PIPING	
RD	RADON (UNDERGROUND)	PERFORATED PVC	PVC	GLUED	ALL SIZES	NO INSULATION	
RD	RADON	SCHEDULE 40 PVC	PVC	GLUED	ALL SIZES	NO INSULATION	

TAG	MANUFACTURER	MODEL	DESCRIPTION	FLOW RATE	CW	HW	SAN	V	REMARKS
WC-1	GERBER	WS-21-512	VIPER 1.28 GPF ELONGATED TOILET	1.28 GPF	1/2"	-	3" / 4"	2"	MAINLINE ML170 SOLID PLASTIC SEAT, WATERSEBSE-LABELED
HWC-1	GERBER	WS-21-518	VIPER 1.28 GPF ERGOHEIGHT ADA ELONGATED TOILET	1.28 GPF	1/2"	-	4''	2"	MAINLINE ML170 SOLID PLASTIC SEAT, WATERSEBSE-LABELED
LAV-1	GERBER	13-894-SP	WICKER PARK SELF-RIMMING LAVATORY	-	-	-	1-1/4"	1-1/4"	
(LAV-1 FAUCET)	SYMMONS	S-9612-1.5	ORIGINS SINGLE HANDLE CENTERSET LAVATORY FAUCET	1.5 GPM	1/2"	1/2"	-	-	WATERSEBSE-LABELED
BT-1	OASIS	TS-6032/FH	VURSA SERIES TUB/SHOWER 60" X 32" X 72-1/2"	-	-	-	1-1/4"	1-1/4"	FAIR HOUSING WALL REINFORCEMENT
BT-1 FAUCET)	SYMMONS	9602-PLR	TUB / SHOWER TRIM	1.5 GPM	1/2"	1/2"	-	-	WATERSEBSE-LABELED
HBT-1	FREEDOM SHOWERS	APTG3260TSADA3P	60" X 32" ACCESSIBLE TUB-SHOWER COMBINATION, ADA COMPLIANT	-	-	-	2"	2"	
(HBT-1 FAUCET)	SYMMONS	6601	1.5 GPM SINGLE LEVER SHOWER SYSTEM WITH ADJUSTABLE SHOWER SPRAY	1.5 GPM	1/2"	1/2"	-	-	SYMMONS 9603-PLR HANDSHOWER WITH SLIDEBAR WATERSENSE-LABELED
SH-1	STERLING	72240100	36" x 36" ED SHOWER WITH BACKERBOARDS	-	-	-	2"	2"	FAIR HOUSING WALL REINFORCEMENT
SH-1 FAUCET)	SYMMONS	6601	1.5 GPM SINGLE LEVER SHOWER SYSTEM WITH ADJUSTABLE SHOWER SPRAY	1.5 GPM	1/2"	1/2"	-	-	WATERSEBSE-LABELED
HSHR-1	FREEDOM SHOWERS	APFQ3838BF1PRRF	38"X38" ROLL IN SHOWER, ADA COMPLIANT	-	-	-	2"	2"	
HSHR-1	FREEDOM SHOWERS	APFX\$T6232LDCOL	60"X30" ADA COMPLIANT ALCOVE SHOWER WITH FULL PLYWOOD BACKING, SEAT, GRAB BARS, SOAP DISHES.						
(HSHR-1 FAUCET)	SYMMONS	6601	1.5 GPM SINGLE LEVER SHOWER SYSTEM WITH ADJUSTABLE SHOWER SPRAY	1.5 GPM	1/2"	1/2"	-	-	SYMMONS 9603-PLR HANDSHOWER WITH SLIDEBAR, WATERSENSE-LABELED
MB-1	MUSTEE	19F	UTILATUB LAUNDRY/UTILITY TUB	-	-	-	3"	2"	
(MB-1 FAUCET)	KOHLER	K-15271-4	4" CENTERSET 6" SWING SERVICE SINK FAUCET	2.2 GPM	1/2"	1/2"	-	-	
KS-1	KOHLER	K-5267-1	STAINLESS STEEL 33" X 22" X 9" DOUBLE BOWL DROP-IN SINK WITH SINGLE FAUCET HOLE	-	-	-	1-1/2"	1-1/2"	
(KS-1 FAUCET)	KOHLER	K-22972	PULL-DOWN SINGLE-HANDLE KITCHEN FAUCET	1.5 GPM	1/2"	1/2"	-	-	
(KS-1 GARBAGE DISPOSAL)	Insinkerator	BADGER 5	1/2 HP MOTOR, GALVANIZED STEEL CONSTRUCTION, CONTINUOUS FEED GARBAGE DISPOSAL WITH STEEL GRINDING ELEMENTS.	-	-	-	-	-	
WF-1	ELKAY	LZWS-LRPBM28K	EZH2O BOTTLE FILLING STATION WITH INTEGRAL SWIRLFLO FOUNTAIN	8 GPH	1/2"	1/2"	1-1/4"	1-1/4"	
WFA-1	OATLEY	38529	WASHING MACHINE FILLER ASSEMBLY	0.5 GPM	1/2"	1/2"	2"	2"	
FD-1	ZURN	Z415B	FLOOR DRAIN BODY ASSEMBLY WITH "TYPE B" STRAINER	-	-	-	3" / 4"	2"	PROVIDE TRAP PRIMER CONNECTION ON ALL FLOO DRAINS ABOVE GRADE
СО	ZURN	Z-1440	FLOOR CLEANOUT	-	-	-	3" / 4"	-	
TP-1	PRECISION PLUMBING PRODUCTS	P2-500	PRESSURE DROP ACTIVATED TRAP PRIMER	-	1/2"	-	-	-	
HB-1	ZURN	Z1341	WALL FAUCET	-	1/2"	-	-	-	
(HB-1 BOX)	ZURN	Z1341-BOX	FAUCET BOX	-	-	-	-	-	
RD-1	JAY R SMITH	1470	8" PROMENADE DECK DRAIN, SIZE A	-	-	-	-	-	
NOTE: MERIEY AL	L FINISHES MEPHUARECHITECT	T-10/ECODER	LEAD-FREE WATER METER WITH REMOTE METER READING, LEAK, TAMPER, REVERSE FLOW DETECTION.	_	_	_	_		

				ELI	ECTRIC	: WA	TER HEA	ATER SC	CHEDULE	•	
TAG	MANUFACTURER	MODEL	STORAGE (GAL)	DELIVERY TEMP. (°F)		DELTA TEMP. (°F)	VOLT/PH/HZ	CURRENT (A)	ELECTRIC REQUIRED (KW)	CW/HW SIZES	REMARKS
DWH-1	AO SMITH	CAHP 120	119	140	90	100	208/1/60	67	11.13	2" / 2"	- -

			SUMP	PUMP SC	HEDUL	.E	
TAG	MANUFACTURER	model number	CAPACITY	VOLTAGE	AMP	HP	NOTES
SP-1	LIBERTY PUMP	ELV280	50 GPM	115	15	1/2	ELEVATOR SUMP PUMP WITH OILTECTOR CONTROL AND ALARM

### Fukui Architects Pc

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- 3. All work shall be installed in accordance with applicable codes and regulations.
- 4. Contractor shall be responsible for the patching, repairing, and preparations of all existing floor, wall, and ceiling surfaces as required to receive scheduled finishes.
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- 6. All reports, plans, specifications, computer files, field data, notices, and other documents and instruments prepared by the Architect as instruments of service shall remain the property of the Architect. The Architect shall retain all common law statutory, and other reserved rights, including the copyright thereto.

revisions

project title

#### Owner: HACP

200 Ross Street Pittsburgh,PA,15219

#### **Client:**

Allies & Ross Management and Development Corporation (ARMDC) 200 Ross Street Pittsburgh, PA 15219

Project Location:
Northview Heights Midrise
246 Penfort Street Pittsburgh, PA 15214

drawing title

SCHEDULES

As Noted

December 3rd, 2023

P501

Sheet No.

#### **HVAC SYMBOLS & LEGEND:** REFRIGERANT LIQUID NEW DUCT (WIDTH x DEPTH, NOT INCLUDING INSULATION) **REFRIGERANT SUCTION** 10x8 REFRIGERANT HOT GAS CONDENSER WATER TO TOWER DUCT WITH INTERNAL LINING <del>----</del> CONDENSER WATER FROM TOWER ------CWR ------ $\bowtie$ SUPPLY DUCT (UP & DOWN) CHILLED WATER SUPPLY EXHAUST DUCT (UP & DOWN) CHILLED WATER RETURN CHILLED GLYCOL-WATER SUPPLY ——— CHGS ——— FLEXIBLE CONNECTION ——— CHGR ——— CHILLED GLYCOL-WATER RETURN ELBOW (PROVIDE ALL SQUARE OR CONDENSATE RECTANGULAR ELBOWS WITH VANES ON SUPPLY AIR) HOT WATER HEATING SUPPLY HOT WATER HEATING RETURN ——— HWR ——— VANED ELBOW (SHORT RADIUS) ———— HGS ———— HOT GLYCOL-WATER HEATING SUPPLY ——— HGR ——— HOT GLYCOL-WATER HEATING RETURN STANDARD RADIUS ELBOW STEAM SUPPLY \_\_\_\_\_ ST \_\_\_\_\_ STEAM CONDENSATE RETURN \_\_\_\_COND\_\_\_\_ PIPE CONNECTION, 45° OR 90° VANED ELBOW & AIR SPLIT TYPE DUCT TAKE-OFF CAPPED OUTLET RISE OR DROP IN PIPE CONNECT NEW DUCT TO EXISTING DUCT UNION STRAINER THERMOMETER INCLINED RISE, IN DIRECTION OF AIR FLOW PRESSURE GAGE **₩-**D INCLINED DROP, IN DIRECTION OF AIR FLOW WATER FLOW MEASURING DEVICE ANCHOR MANUAL SPLITTER DAMPER REDUCER OR INCREASER GATE VALVE STANDARD BRANCH SUPPLY OR **GLOBE VALVE** GATE VALVE WITH 3/4" HOSE ADAPTER CHECK VALVE RETURN, NO SPLITTER (45° TAP) ANGLE GLOBE VALVE **BUTTERFLY VALVE** CEILING DIFFUSERS BALL VALVE BALANCING VALVE SUPPLY TOP REGISTER OR GRILLE (WALL TYPE) CIRCUIT SETTER EXHAUST OR RETURN CEILING REGISTER OR GRILLE STRAIGHT-THRU MODULATING CONTROL VALVE STRAIGHT-THRU TWO POSITION CONTROL VALVE **─── ──** EXHAUST OR RETURN BOTTOM REGISTER OR GRILLE THREE-WAY MODULATING CONTROL VALVE EXHAUST OR RETURN REGISTER OR TOP GRILLE $\longrightarrow igtriangledown$ AUTOMATIC FLOW CONTROL VALVE MANUAL VOLUME DAMPER SAFETY OR PRESSURE RELIEF VALVE HORIZONTAL FIRE DAMPER PRESSURE REDUCING VALVE **─**─**─** VERTICAL FIRE DAMPER MANUAL AIR VENT VERTICAL FIRE SMOKE DAMPER TEST PLUG (PRESSURE/TEMPERATURE) POINT OF CONNECTION BETWEEN NEW AND EXISTING WORK BACK DRAFT DAMPER **THERMOSTAT** (ASSOC. EQUIP.) MOTORIZED DAMPER HUMIDISTAT DUCT DETECTOR DUCT MOUNTED COIL (HOT WATER OR STEAM COIL) DUCT HIGH PRESSURE SENSOR DUCT STATIC PRESSURE SENSOR VARIABLE VOLUME TERMINAL UNIT CARBON DIOXIDE SENSOR FAN POWERED VARIABLE VOLUME - DETAIL NUMBER DRAWING NUMBER WHERE DRAWN UNIT HEATER (HORIZONTAL) SECTION LETTER DRAWING NUMBER WHERE SHOWN AIR HANDLING UNIT AHU SYSTEM # \_\_\_ ROOM # AHU-#-# <del>▼</del> TYPICAL UNIT NO. MARK + X X + DIAMETER **DIFFUSER CALLOUT**

### HVAC

ACC

**ACCU** 

AHU

BOD

CCF

CD

CG

CO

COMP

CONV.

CP

CR

CU

CW

DPR

EDH

EER

ETR

**FCW** 

**FDPR** 

FTR

GRV

LCD

LPR

LPS

MA

MB

MAX

NOM

NO

Sp. Gr.

SPS

VCC

VFD

WFMD

LBS/HR

DWG(S)

CH

CF

C AI	BBREVIATIONS:
	AIR CONDITIONING UNIT AIR COOLED CONDENSER AIR COOLED CONDENSING UNIT ACCESS DOOR ABOVE FINISHED FLOOR AIR HANDLING UNIT ACCESS PANEL
	BELOW FINISHED CEILING BACKWARD INCLINED WHEEL BOTTOM GRILLE (WALL TYPE) BETWEEN JOISTS BOTTOM OF DUCT BOTTOM REGISTER (WALL TYPE)
	CONVERTOR COOLING COIL CENTRIFUGAL CEILING FAN CEILING DIFFUSER CENTRIFUGAL FAN CEILING GRILLE CHILLER UNIT CLEAN OUT COMPRESSOR CONVECTOR CONDENSATE PUMP CEILING REGISTER CONDENSING UNIT CABINET UNIT HEATER COLD WATER
	DRY BULB TEMPERATURE DECIBELS DUCT SMOKE DETECTOR DEWPOINT TEMPERATURE DAMPER DRAWING(S) DIRECT EXPANSION
	EXHAUST AIR ELECTRICAL CONTRACTOR ELECTRIC COIL DUCT HEATER ENERGY EFFICIENCY RATIO EXHAUST FAN EXHAUST FAN ROOF END OF MAIN DRIP (STEAM) ENERGY RECOVERY UNIT ELECTRIC RADIANT CEILING PANEL EXPANSION TANK ELECTRIC UNIT HEATER EXISTING EXISTING TO REMAIN
	FAN COIL UNIT FORWARD CURVED FAN FLOOR FIRE DAMPER FIN TUBE RADIATION
	GRAVITY HOOD GENERAL CONTRACTOR GRAVITY RELIEF VENTILATOR
	HEATING COIL HOOD HEAT EXCHANGER HEPA FILTER HORSEPOWER HIGH PRESSURE STEAM CONDENSATE RETURN HIGH PRESSURE STEAM HYDRONIC RADIANT CEILING PANEL HOT WATER RETURN HOT WATER SUPPLY
	INTEGRAL FACE AND BYPASS INDUCTION UNIT INLET VANES
	LINEAR CEILING DIFFUSER LOW PRESSURE STEAM CONDENSATE RETURN LOW PRESSURE STEAM POUNDS PER HOUR MAKEUP AIR MIXING BOX MECHANICAL CONTRACTOR MAXIMUM MINIMUM
	NOMINAL NORMALLY OPEN NORMALLY CLOSED
	OUTDOOR AIR
	PUMP PLUMBING CONTRACTOR PRESSURE DROP PRESSURE REDUCING VALVE
	RETURN AIR RETURN FAN RECOMMENDED FUSE SIZE REHEAT COIL RELATIVE HUMIDITY POWER TYPE ROOF VENTILATOR
	SUPPLY AIR SMOKE DAMPER SPECIFIC GRAVITY STATIC PRESSURE STATIC PRESSURE SENSOR
	THROUGH JOISTS TYPICAL
	UNDERCUT UNIT HEATER UNDER JOISTS UNIT VENTILATOR
	VARIABLE AIR VOLUME VOLUMETRIC CONTROL CENTER

### **HVAC GENERAL NOTES:**

- 1. ALL MATERIALS FURNISHED AND ALL WORK INSTALLED SHALL BE IN STRICT ACCORDANCE WITH THE REQUIREMENTS OF THE OWNER AND ALL APPLICABLE CODES AND REGULATIONS, INCLUDING BUT NOT LIMITED TO THE LATEST APPLICABLE EDITIONS OF NFPA, IEEE, OSHA, SMACNA, INTERNATIONAL MECHANICAL CODE, INTERNATIONAL BUILDING CODE, STATE, COUNTY, AND LOCAL CODES.
- 2. HVAC CONTRACTOR SHALL PROVIDE ALL LABOR AND MATERIALS FOR A COMPLETE AND OPERABLE SYSTEM AS PART OF THE CONTRACT. FAILURE TO REVIEW DOES NOT RELIEVE THE CONTRACTOR OF FULFILLING THE CONTRACTUAL OBLIGATIONS.
- 3. THE HVAC CONTRACTOR SHALL GIVE ALL NECESSARY NOTICES, OBTAIN ALL PERMITS AND PAY ALL TAXES, FEES, AND OTHER COSTS IN CONNECTION WITH HIS WORK, THE CONTRACTOR SHALL FILE ALL NECESSARY APPROVALS OF ALL REQUIRED CERTIFICATES OF INSPECTION FOR HIS WORK JURISDICTION, THE CONTRACTOR SHALL INCLUDE IN HIS SCOPE OF WORK, WITHOUT EXTRA COST TO THE OWNER, ALL LABOR, MATERIALS, SERVICES, APPARATUS, IN ORDER TO COMPLY WITH ALL APPLICABLE CODES, LAWS, ORDINANCES, RULES AND REGULATIONS.
- 4. THE CONTRACTOR SHALL FURNISH ALL LABOR, MATERIALS, EQUIPMENT, RIGGING, APPLIANCES, TOOLS AND ACCESSORIES REQUIRED TO PROVIDE, INSTALL, CONNECT, AND TEST THE COMPLETE HEATING, VENTILATING AND AIR CONDITIONING SYSTEM AND ASSOCIATED EQUIPMENT IN ACCORDANCE WITH THE SPECIFICATIONS AND THE APPLICABLE DRAWINGS.
- 5. THE EXACT MOUNTING HEIGHTS AND LOCATIONS OF ALL HVAC EQUIPMENT SHALL BE FIELD VERIFIED AND COORDINATED WITH ALL OTHER MECHANICAL, ELECTRICAL, ARCHITECTURAL, AND STRUCTURAL SYSTEMS.
- 6. COORDINATE INSTALLATION OF ALL NEW WORK WITH ARCHITECTURAL AND STRUCTURAL PLANS AND ALL OTHER TRADES. CONTRACTOR SHALL TAKE ALL INTERFERENCES INTO CONSIDERATION. PROVIDE ALL NECESSARY OFFSETS AND TRANSITIONS WITH AREAS EQUIVALENT TO DUCT SIZES INDICATED ON DRAWINGS.
- 7. REFER TO ARCHITECTURAL AND STRUCTURAL DRAWINGS FOR ALL DIMENSIONS AND STRUCTURAL STEEL LOCATIONS AND SIZES. COORDINATE INSTALLATION OF ALL PIPING AND DUCTWORK, AND INSTALL ALL PIPING IN JOIST SPACE OR AS HIGH AS POSSIBLE TO PERMIT INSTALLATION OF ALL DUCTWORK, OFFSET DUCTWORK AS REQUIRED IN ORDER TO ACCOMMODATE WORK OF ALL OTHER TRADES.
- 8. DO NOT INSTALL ANY MECHANICAL WORK ABOVE ELECTRICAL PANELS OR
- 9. FOR ALL BRANCH DUCT CONNECTIONS TO MAIN TRUNK, PROVIDE 45 DEGREE TRANSITION FITTING OR CONICAL TAP FOR ROUND DUCT. BUTT FITTINGS ARE NOT PERMITTED. PROVIDE MANUAL VOLUME DAMPER WITH LOCKING QUADRANT IN ALL BRANCH RUNOUTS TO GRILLES AND DIFFUSERS.
- 10. PROVIDE MITERED ELBOW WITH TURNING VANES OR ELBOW WITH CENTERLINE RADIUS EQUAL TO 1.5 TIMES DUCT WIDTH AT ALL CHANGES IN DIRECTION.
- 11. INSTALL ALL FIRE DAMPERS S IN STRICT ACCORDANCE WITH MANUFACTURER'S RECOMMENDATIONS. PROVIDE UL FIRE DAMPERS WITH BLADES OUT OF AIR STREAM. PROVIDE ACCESS DOOR AT ALL FIRE DAMPER LOCATIONS. FIRE DAMPERS IN RETURN AIR TRANSFER DUCTS ONLY MAY HAVE BLADES IN AIR STREAM.
- 12. THE FINISH AND COLOR OF ALL EXPOSED DUCTWORK, EQUIPMENT, AND AIR DEVICES SHALL BE COORDINATED WITH THE ARCHITECT. DUCTWORK THAT IS TO BE PAINTED SHALL BE OIL FREE.
- 13. VERIFY ALL EQUIPMENT VOLTAGES WITH THE ELECTRICAL CONTRACTOR PRIOR TO
- 14. PROVIDE DISCONNECT SWITCHES FOR ALL HVAC EQUIPMENT INCLUDING WEATHERPROOF UNITS AS REQUIRED.
- 15. PROVIDE PHASE LOSS PROTECTION FOR ALL POLY-PHASE MOTOR DEVICES.
- 16. THE FINAL LOCATION OF AIR DEVICES MUST BE COORDINATED WITH THE REFLECTED CEILING PLAN AND ALL OTHER MECHANICAL, ELECTRICAL, ARCHITECTURAL, AND
- 17. DUCTWORK SHALL BE CONSTRUCTED OF GALVANIZED SHEET STEEL, EXCEPT WHERE NOTED, IN STRICT COMPLIANCE WITH THE LATEST EDITION OF THE ASHRAE, NFPA, AND SMACNA RECOMMENDATIONS, SIZES AS SHOWN INDICATE INSIDE CLEAR DIMENSIONS OF THE AIR PASSAGE.
- 18. DUCT SIZES MUST BE VERIFIED FOR CLEARANCES AT THE JOB SITE PRIOR TO FABRICATION. DIMENSIONS MAY BE CHANGED TO ACCOMMODATE CONSTRUCTION AS LONG AS EFFECTIVE CROSS-SECTIONAL AREA IS MAINTAINED.
- 19. ALL CEILING MOUNTED EQUIPMENT MUST BE SUPPORTED DIRECTLY FROM BUILDING STRUCTURE WITH COMBINATION SPRING AND NEOPRENE- IN-SHEAR HANGERS AND ROD. PROVIDE SUPPLEMENTARY STEEL AS REQUIRED TO ADEQUATELY SUPPORT THE
- 20. PROVIDE FLEXIBLE CONNECTIONS AND VIBRATION ISOLATION ON ALL HVAC
- 21. HVAC EQUIPMENT SHALL NOT RUN DURING CONSTRUCTION.
- 22. PROVIDE AIR VENTS AT HIGHEST POINTS OF HYDRONIC SYSTEM.
- 23. ALL MOTORS SHALL BE NEMA PREMIUM EFFICIENCY MOTORS.

STRUCTURAL SYSTEMS.

- 25. M.C. SHALL BE RESPONSIBLE FOR ALL LOOSE LINTELS NECESSARY FOR INSTALLATION
- 24. PROVIDE COGGED BELTS FOR ALL FAN DRIVES.

OF HIS MATERIALS. SIZES OF LINTELS SHOWN ON STRUCTURAL DRAWINGS.

### HVAC GENERAL NOTES (CONT.):

- 26. CONTRACTOR TO VERIFY THAT ALL MATERIALS, CONDUITS, PIPES, AND WIRING SHALL BE PLENUM RATED IF EXPOSED IN PLENUM SPACE. NON-PLENUM RATED MATERIALS MUST BE PROTECTED SUCH THAT A PLENUM RATING IS MAINTAINED. BETWEEN THE MATERIAL OR DEVICE AND THE PLENUM SPACE. CONTRACTOR SHALL NOTIFY ENGINEER IF NON-PLENUM-RATED WIRING EXISTS.
- 27. ALL METALLIC AND NON-METALLIC DUCTWORK JOINTS AND SEAMS SHALL BE SEALED, TAPED OR GASKETED.
- 28. ALL METALLIC AND NON-METALLIC DUCTWORK JOINTS AND SEAMS SHALL BE SEALED, TAPED OR GASKETED.THE MECHANICAL CONTRACTOR SHALL HAVE A THIRD PARTY CONTRACTOR TEST AND BALANCE ALL SYSTEMS PER DESIGN DOCUMENTS. PROVIDE A COPY OF THE TESTING AND BALANCING REPORT TO THE ENGINEER AND A COPY TO THE MECHANICAL INSPECTOR FOR REVIEW.
- 29. ALL CONTROL DEVICES, HEAT EXCHANGERS, AND HVAC SYSTEM COMPONENTS SHALL BE ACCESSIBLE WIHTOUT DISABLING FUNCTION OR VIOLATING A FIRE RATED ASSEMBLY OR REMOVING PERMANENT CONSTRUCTION, OTHER APPLIANCES, VENTING SYSTEMS OR PIPING/DUCTS NOT CONNECTED TO THE APPLIANCE BEING INSPECTED. A LEVEL WORKING SURFACE OF AT LEAST 30" DEEP BY 30" WIDE SHALL BE PROVIDED ON CONTROL SIDE OF APPLIANCE.
- 30. FLOAT CONTROL SWITCHES SHALL BE INSTALLED ON ALL HVAC EQUIPMENT IN WHICH CONDENSATE DRAIN PIPING IS UTILIZED AND REQUIRED. A DETECTION OF OVERFLOW OR FAILURE BY THE FLOAT CONTROL SWITCH SHALL DEACTIVATE THE HVAC EQUIPMENT IT IS ASSOCIATED WITH.
- 31. CONDENSATE PUMPS SHALL BE CONNECTED TO APPLIANCES OR EQUIPMENT WHERE NOTED SUCH THAT WHEN THE CONDENSATE PUMP FAILS, THE APPLIANCE OR EQUIPMENT BEING SERVED BY THE PUMP WILL BE DE-ENERGIZED AND SHALL SHUT DOWN. FLOAT CONTROLS SHALL BE WIRED IN SERIES WITH HVAC EQUIPMENT TO ENSURE THIS CONDITION.
- 32. THE MAXIMUM LENGTH OF EXHAUST DUCT FOR A DRYER SHALL BE DETERMINED BY THE INSTALLATION AND MAXIMUM EQUIVALENT LENGTH REQUIREMENTS OF THE DRYER MANUFACTURER.
- 33. REFRIGERATION ACCESS PORTS SHALL BE PROTECTED IN ACCORDANCE WITH IMC 2015 SECTION 1101.10 WHENEVER REFRIGERANT IS ADDED TO OR REMOVED FROM REFRIGERATION OR AIR CONDITIONING SYSTEMS.
- 34. CONDENSATE DRAIN LINES TO BE CONFIGURED OR EQUIPPED TO ALLOW FOR MAINTENANCE OF THE DRAIN. CAPS OR TEES, CROSS FITTINGS, UNIONS, REMOVABLE MECHANICAL CUFFLINKS AND SPECIALTY DEVICES MAY BE USED TO ALLOW FOR MAINTENANCE OF CONDENSATE DRAIN PIPING.
- 35. ALL EXHAUST AIR AND INTAKE OPENINGS THAT TERMINATE OUTDOORS SHALL BE PROTECTED WITH CORROSION-RESISTANT SCREENS, LOUVERS OR GRILLES. BIRDSCREENS ARE TO BE PROVIDED FOR ALL MECHANICAL AIR INTAKE AND EXHAUST OUTLET LOUVERS.

### Fukui Architects Pc

205 Ross Street


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revisions

project title

#### Owner: HACP

200 Ross Street Pittsburgh,PA,15219

#### **Client:**

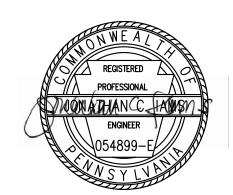Allies & Ross Management and Development Corporation (ARMDC) 200 Ross Street

### Pittsburgh, PA 15219 **Project Location:**

Northview Heights Midrise 246 Penfort Street Pittsburgh, PA 15214

drawing title

MECHANICAL COVERSHEET

As Noted December 3rd, 2023

186 | 233

**Sheet No.** 

M000

Project #2040

MARK RETURN/EXHAUST/TRANSFER GRILLE

WET BULB TEMPERATURE WATER FILTER WATER FLOW MEASURING DEVICE WEATHER PROOF

VARIABLE FREQUENCY DRIVE

VACUUM PUMP


VOLUME DAMPER (MANUAL OPPOSED BLADE)

VACUUM STEAM CONDENSATE RETURN

- 1. FOR ALL AIR HANDLING UNITS AND BRANCH CONTROLLERS CONCEALED ABOVE GYPSUM CEILINGS, AN ACCESS PANEL MUST BE PROVIDED FOR SERVICE AND MAINTENANCE PER THE MANUFACTURER'S SERVICE REQUIREMENTS. THE ACCESS PANEL MUST ALSO BE SUFFICIENTLY SIZED TO PERMIT THE REMOVAL AND REINSTALLATION OF THE AIR HANDLING UNIT AND BRANCH CONTROLLER. REFER TO ARCHITECTURAL SPEC.
- 2. COORDINATE ALL DUCTWORK AND EQUIPMENT WITH STRUCTURAL.
- 3. COORDINATE FINAL DIFFUSER LOCATIONS WITH LIGHT FIXTURES. LIGHT FIXTURES SHALL TAKE PRECEDENCE, SHIFT DIFFUSERS AS REQUIRED.
- 4. PROVIDE VOLUME CONTROL DAMPERS AND MOTORIZED DAMPERS ON ALL OUTDOOR AIR BRANCH DUCTS CONNECTED TO INDOOR AIR HANDLING UNITS. PROVIDE ACCESS PANELS AS REQUIRED FOR DAMPERS.
- 5. ALL SUPPLY, RETURN AND OUTDOOR AIR DUCTWORK SHALL BE INSTALLED BELOW STRUCTURE (UNLESS INDICATED OTHERWISE). ALL EXHAUST DUCTWORK SHALL BE ROUTED THROUGH STRUCTURE.
- 6. COORDINATE ALL EXTERIOR TERMINATIONS WITH ARCHITECTURAL DRAWINGS.

### **DRAWING NOTES**

- TRANSITION DUCT AS REQUIRED TO CONNECT TO OUTDOOR AIR INTAKE. INTAKE MUST BE A MINIMUM OF 10 FT FROM ALL MECHANICAL EXHAUST TERMINATIONS.
- EXHAUST LOUVER WITH PLENUM. EXHAUST TERMINATION MUST BE A MINIMUM OF 3 FT FROM OPERABLE OPENINGS INTO THE BUILDING AND
- 3 UNIT ACCESS PANEL. REFER TO GENERAL NOTE 1.
- 4 OUTDOOR AIR INTAKE INSTALLED IN CANOPY CEILING. TRANSITION DUCT AS REQUIRED TO CONNECT TO INTAKE. INTAKE MUST BE A MINIMUM OF 10 FT FROM ALL MECHANICAL EXHAUST TERMINATIONS.
- EXTEND OA DUCT INTO WATER UTILITY ROOM. DUCT SHALL MATCH INTAKE LOUVER DIMENSIONS. PROVIDE MOTORIZED DAMPER INTERLOCKED WITH EF-1.
- 6) IN-LINE EXHAUST FAN SHALL BE MOUNTED TIGHT TO CEILING ABOVE WITH VIBRATION ISOLATORS.

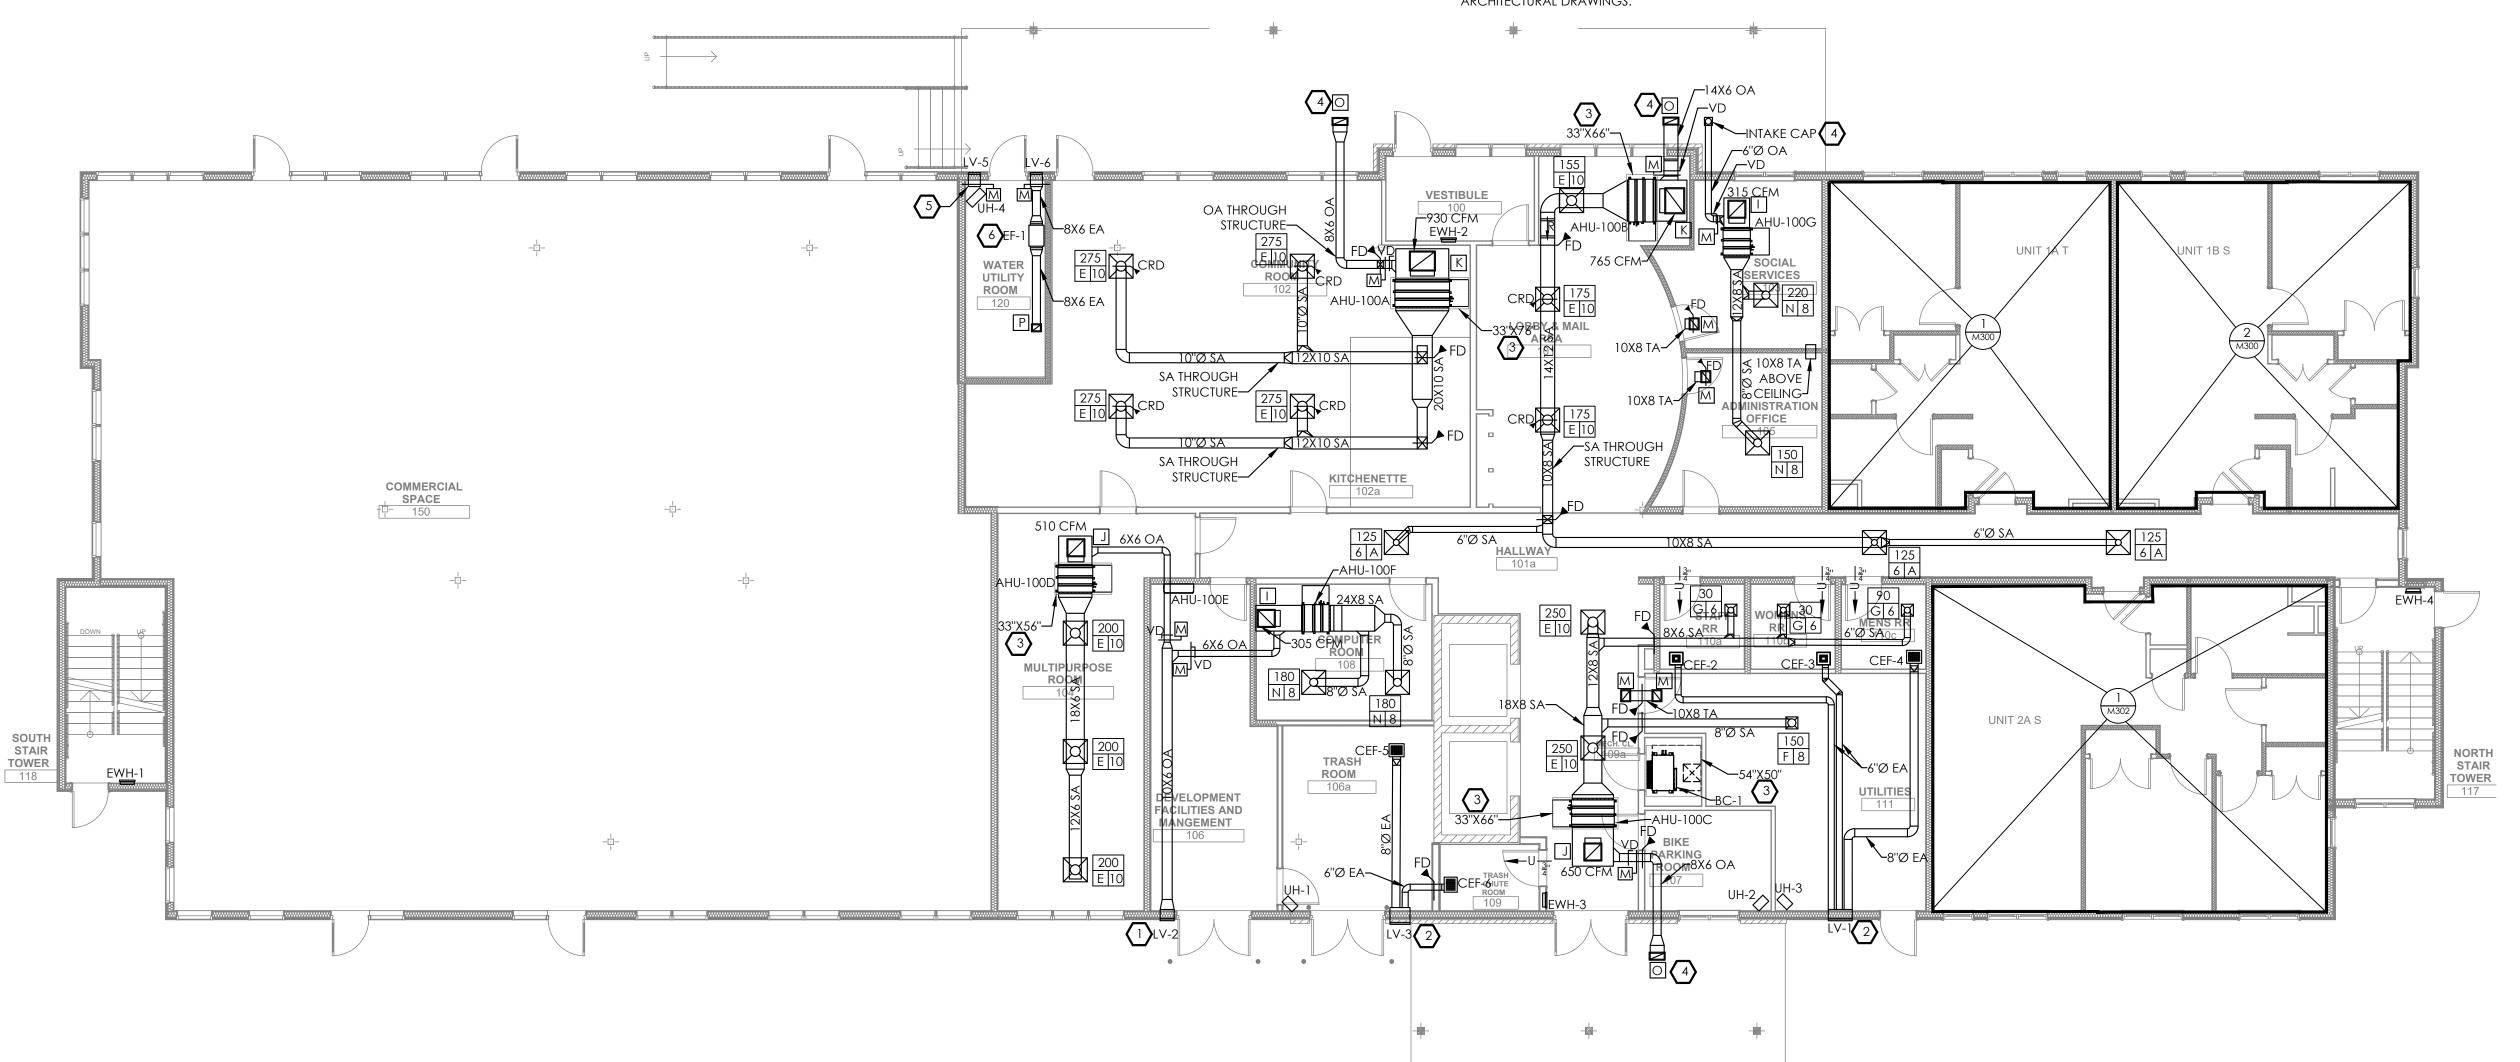




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revisions

project title

#### Owner: HACP

200 Ross Street Pittsburgh,PA,15219

#### **Client:**

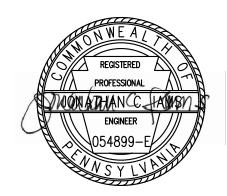Allies & Ross Management and Development Corporation (ARMDC) 200 Ross Street Pittsburgh, PA 15219

### **Project Location:**

Northview Heights Midrise 246 Penfort Street Pittsburgh, PA 15214

drawing title

**MECHANICAL** FIRST FLOOR PLAN

As Noted


December 3rd, 2023

**M101** Project #2040

- 1. FOR ALL AIR HANDLING UNITS AND BRANCH CONTROLLERS CONCEALED ABOVE GYPSUM CEILINGS, AN ACCESS PANEL MUST BE PROVIDED FOR SERVICE AND MAINTENANCE PER THE MANUFACTURER'S SERVICE REQUIREMENTS. THE ACCESS PANEL MUST ALSO BE SUFFICIENTLY SIZED TO PERMIT THE REMOVAL AND REINSTALLATION OF THE AIR HANDLING UNIT AND BRANCH CONTROLLER. REFER TO ARCHITECTURAL SPEC.
- 2. COORDINATE ALL DUCTWORK AND EQUIPMENT WITH STRUCTURAL.
- 3. COORDINATE FINAL DIFFUSER LOCATIONS WITH LIGHT FIXTURES. LIGHT FIXTURES SHALL TAKE PRECEDENCE, SHIFT DIFFUSERS AS REQUIRED.
- 4. PROVIDE VOLUME CONTROL DAMPERS AND MOTORIZED DAMPERS ON ALL OUTDOOR AIR BRANCH DUCTS CONNECTED TO INDOOR AIR HANDLING UNITS. PROVIDE ACCESS PANELS AS REQUIRED FOR DAMPERS.
- 5. ALL SUPPLY, RETURN AND OUTDOOR AIR DUCTWORK SHALL BE INSTALLED BELOW STRUCTURE (UNLESS INDICATED OTHERWISE). ALL EXHAUST DUCTWORK SHALL BE ROUTED THROUGH STRUCTURE.
- 6. COORDINATE ALL EXTERIOR TERMINATIONS WITH ARCHITECTURAL DRAWINGS.

### **DRAWING NOTES**

- TRANSITION DUCT AS REQUIRED TO CONNECT TO OUTDOOR AIR INTAKE. INTAKE MUST BE A MINIMUM OF 10 FT FROM ALL MECHANICAL EXHAUST TERMINATIONS.
- TRANSITION DUCT AS REQUIRED TO CONNECT TO EXHAUST TERMINATION. EXHAUST TERMINATION MUST BE A MINIMUM OF 3 FT FROM OPERABLE OPENINGS INTO THE BUILDING AND 10 FT FROM
- 3 UNIT ACCESS PANEL. REFER TO GENERAL NOTE 1.

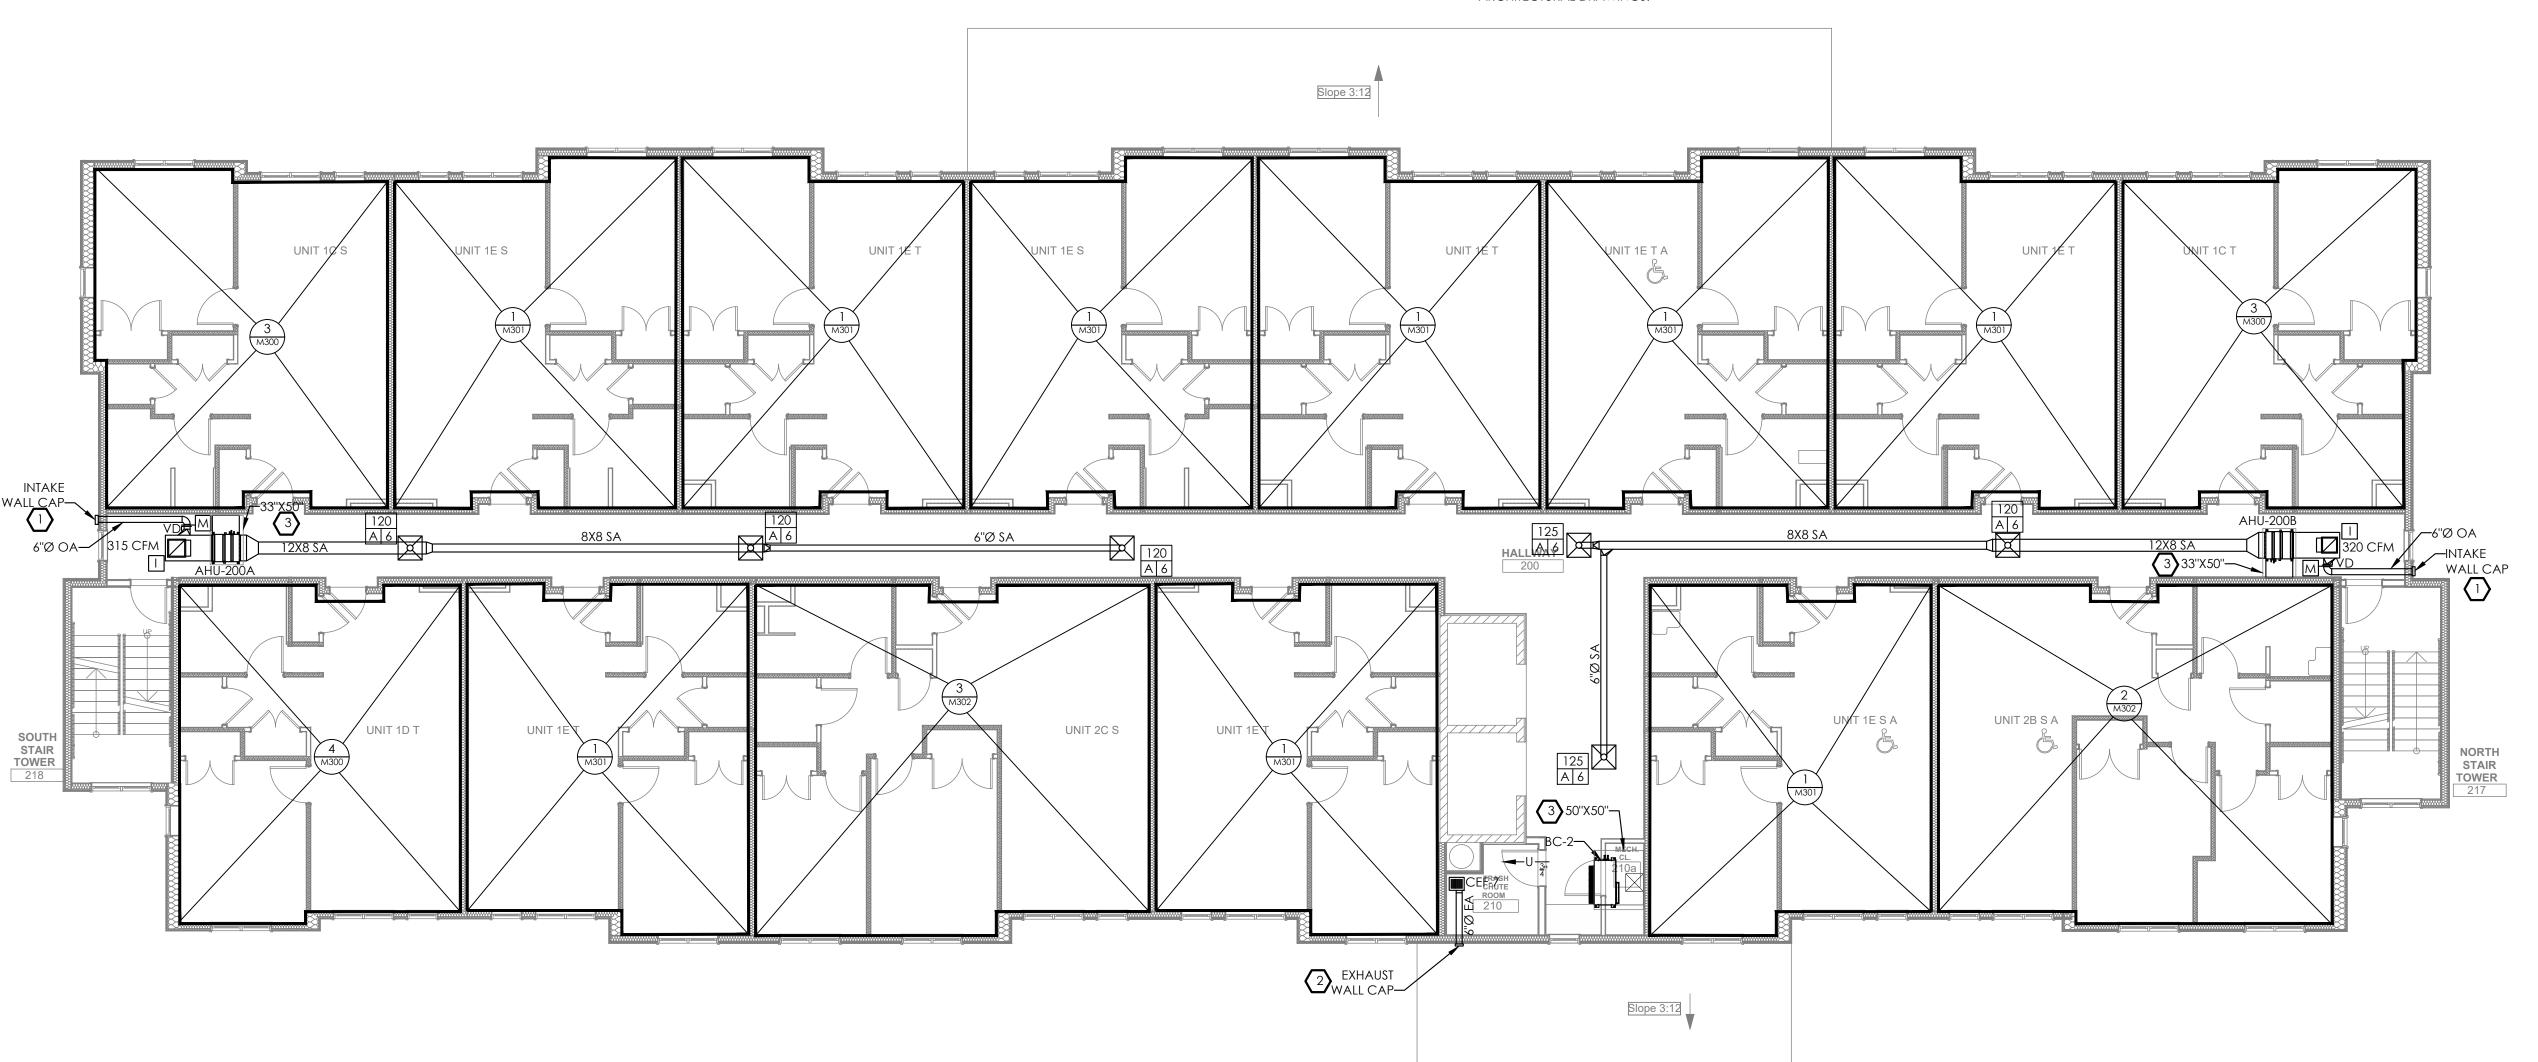




### Fukui Architects Pc

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revisions

project title

#### Owner: HACP

200 Ross Street Pittsburgh,PA,15219
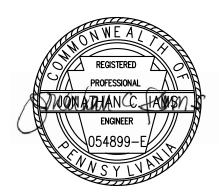
#### **Client:**

Allies & Ross Management and Development Corporation (ARMDC) 200 Ross Street Pittsburgh, PA 15219

### **Project Location:**

Northview Heights Midrise 246 Penfort Street Pittsburgh, PA 15214

drawing title

**MECHANICAL** SECOND FLOOR PLAN

scale As Noted

December 3rd, 2023


**M102** 

Project #2040

- 1. FOR ALL AIR HANDLING UNITS AND BRANCH CONTROLLERS CONCEALED ABOVE GYPSUM CEILINGS, AN ACCESS PANEL MUST BE PROVIDED FOR SERVICE AND MAINTENANCE PER THE MANUFACTURER'S SERVICE REQUIREMENTS. THE ACCESS PANEL MUST ALSO BE SUFFICIENTLY SIZED TO PERMIT THE REMOVAL AND REINSTALLATION OF THE AIR HANDLING UNIT AND BRANCH CONTROLLER. REFER TO ARCHITECTURAL SPEC.
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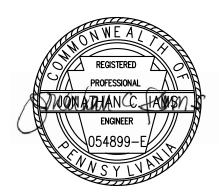
### Fukui Architects Pc

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revisions

project title
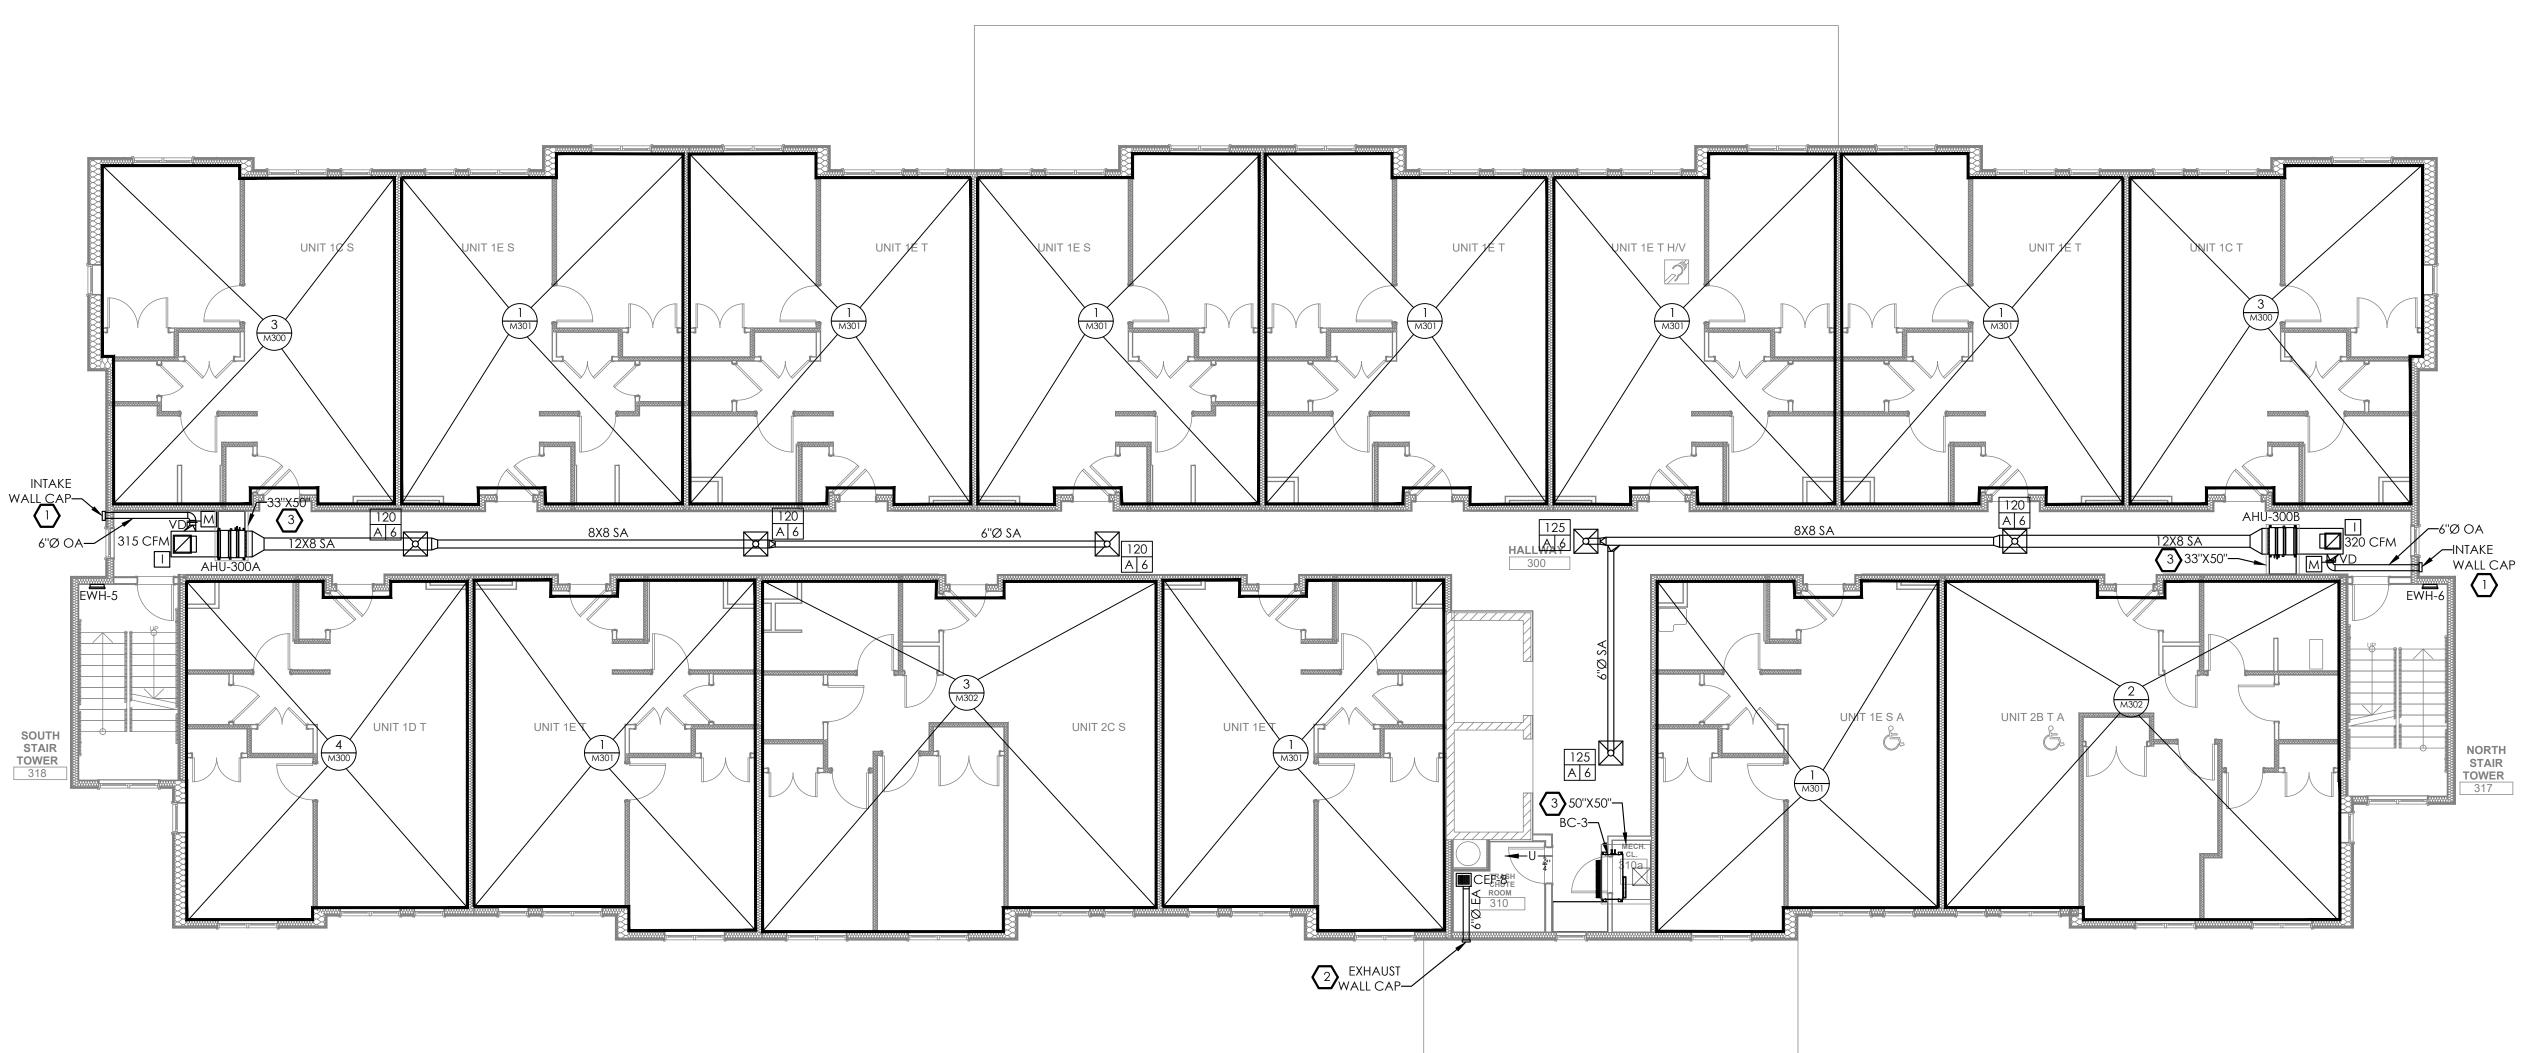
#### Owner: HACP

200 Ross Street Pittsburgh,PA,15219

#### **Client:**

Allies & Ross Management and Development Corporation (ARMDC) 200 Ross Street Pittsburgh, PA 15219

### **Project Location:**

Northview Heights Midrise 246 Penfort Street Pittsburgh, PA 15214

drawing title

**MECHANICAL** THIRD FLOOR PLAN

scale As Noted

December 3rd, 2023


M103

Project #2040

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- TRANSITION DUCT AS REQUIRED TO CONNECT TO EXHAUST TERMINATION. EXHAUST TERMINATION MUST BE A MINIMUM OF 3 FT FROM OPERABLE OPENINGS INTO THE BUILDING AND 10 FT FROM
- DRYER VENT TERMINATION WITH INTEGRAL BACKDRAFT DAMPER. VERIFY VENT SIZE WITH MANUFACTURER. VENT MUST TERMINATE A MINIMUM OF 3FT FROM OPERABLE OPENINGS INTO THE BUILDING, 10 FT FROM INTAKES AND 2FT ABOVE ROOF DECK.
- 4) UNIT ACCESS PANEL. REFER TO GENERAL NOTE 1.



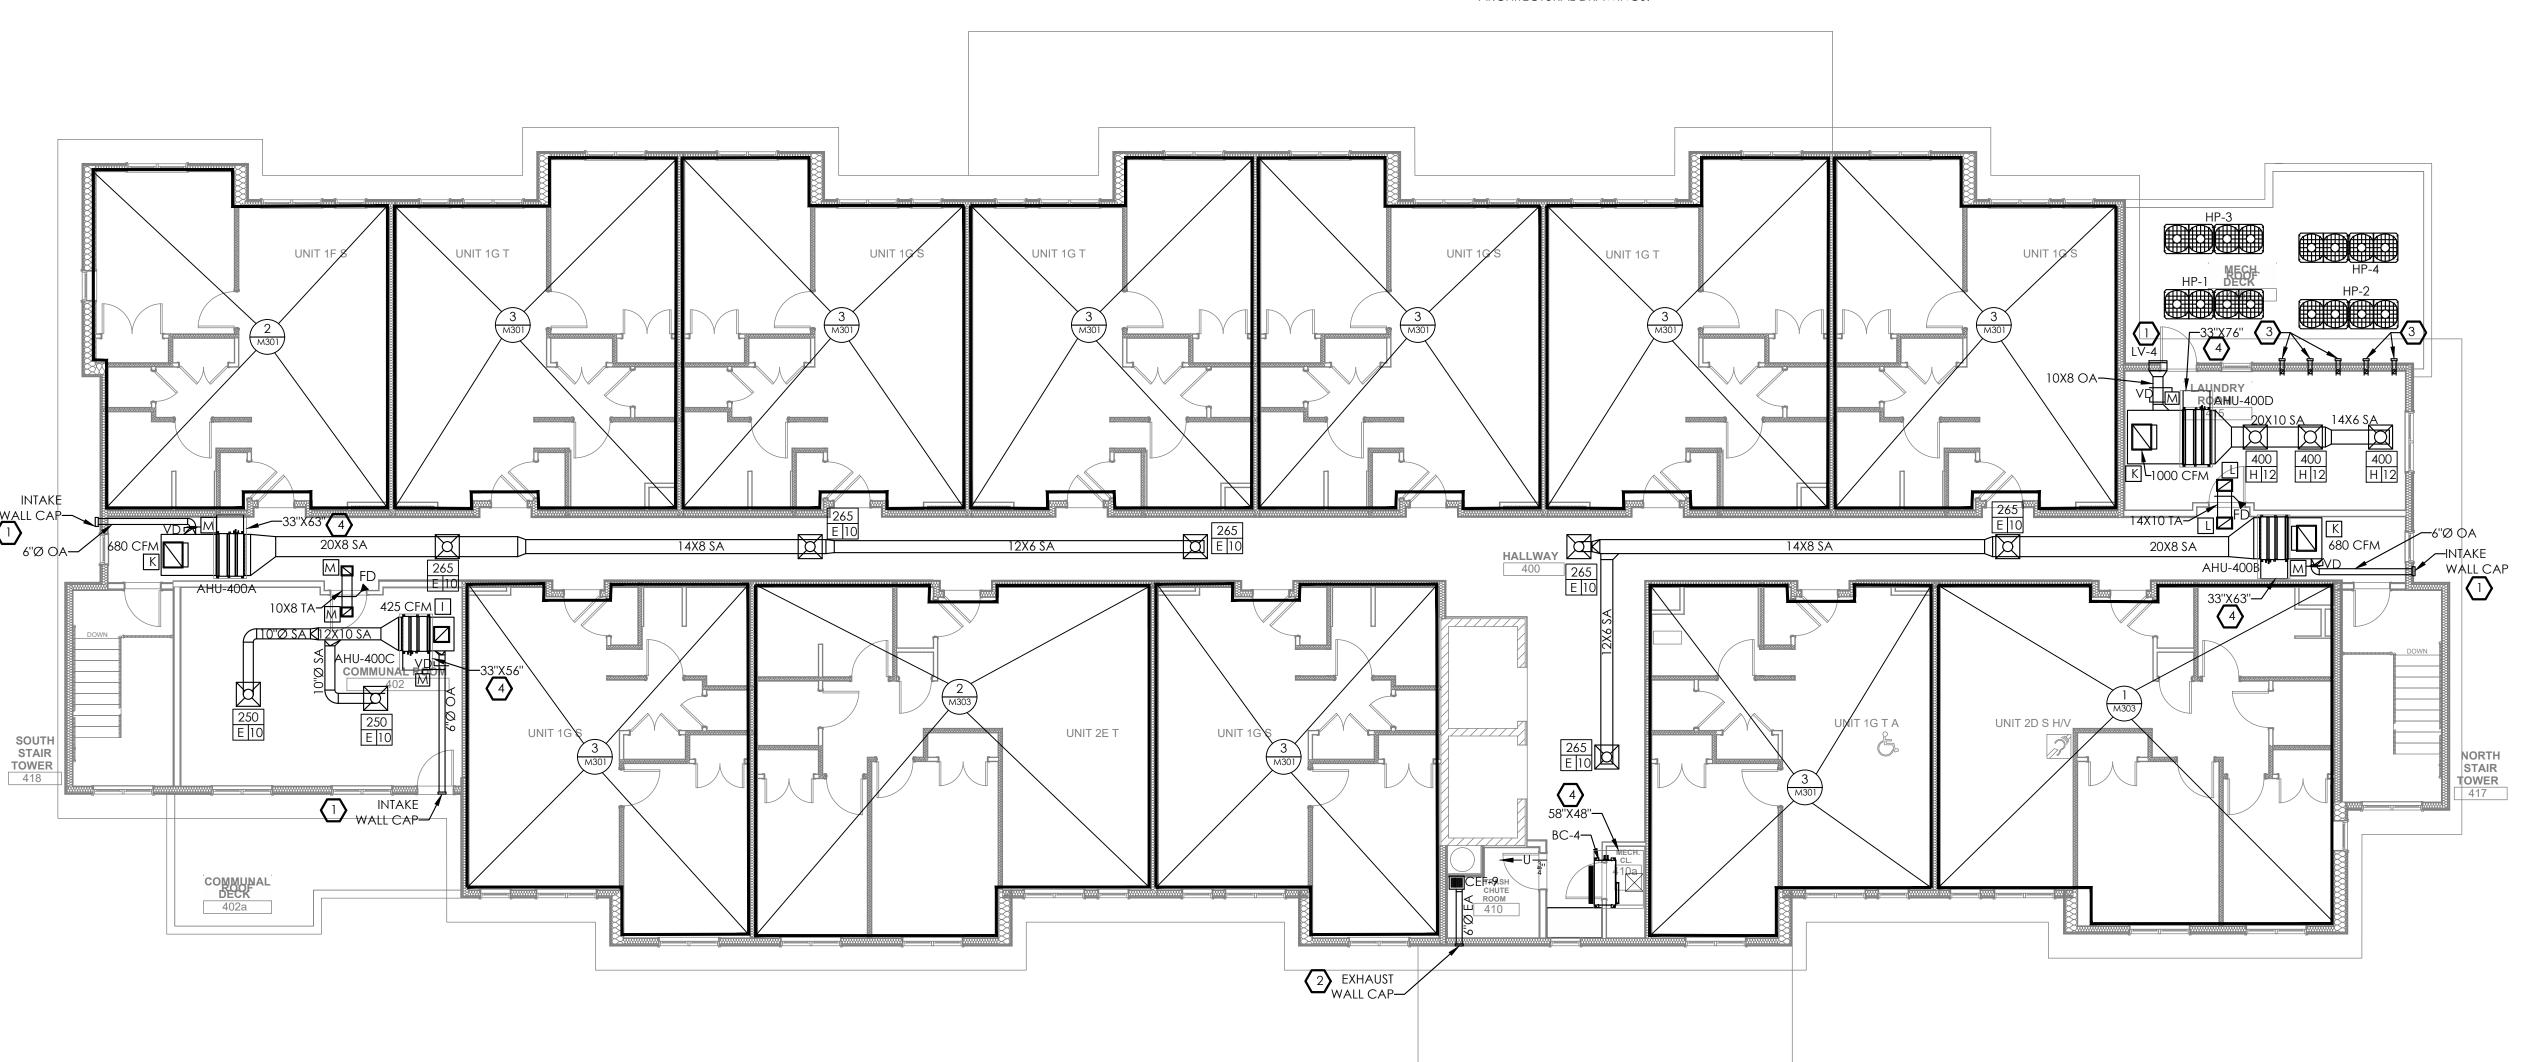

### Fukui Architects Pc

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revisions

project title

#### Owner: HACP

200 Ross Street Pittsburgh,PA,15219

#### **Client:**

Allies & Ross Management and Development Corporation (ARMDC) 200 Ross Street

### Pittsburgh, PA 15219

**Project Location:** Northview Heights Midrise 246 Penfort Street Pittsburgh, PA 15214

drawing title

**MECHANICAL** FOURTH FLOOR PLAN

As Noted

December 3rd, 2023


**M104** 

Sheet No.

- 1. FOR ALL AIR HANDLING UNITS AND BRANCH CONTROLLERS CONCEALED ABOVE GYPSUM CEILINGS, AN ACCESS PANEL MUST BE PROVIDED FOR SERVICE AND MAINTENANCE PER THE MANUFACTURER'S SERVICE REQUIREMENTS. THE ACCESS PANEL MUST ALSO BE SUFFICIENTLY SIZED TO PERMIT THE REMOVAL AND REINSTALLATION OF THE AIR HANDLING UNIT AND BRANCH CONTROLLER. REFER TO ARCHITECTURAL SPEC.
- 2. COORDINATE ALL REFRIGERANT PIPING AND EQUIPMENT WITH STRUCTURAL.
- 3. REFRIGERANT PIPING SHOWN IS SCHEMATIC ONLY.
- 4. PROVIDE 7-DAY PROGRAMMABLE THERMOSTATS FOR EACH AIR HANDLING UNIT. ALL THERMOSTATS IN COMMON AREAS SHALL BE PROVIDED WITH LOCKABLE COVERS. COORDINATE THERMOSTAT LOCATIONS AND LOCKABLE COVER REQUIREMENTS WITH OWNER.

### **DRAWING NOTES**

- INSTALL BC CONTROLLER PER MANUFACTURER'S REQUIREMENTS.
  DISCHARGE CONDENSATE AT FLOOR DRAIN IN MECHANICAL CLOSET.
- LIQUID AND GAS REFRIGERANT PIPING FROM ASSOCIATED OUTDOOR UNIT TO BC CONTROLLER. COORDINATE ROUTING IN FIELD. VERIFY QUANTITIES, SIZES AND LINE LENGTHS WITH MANUFACTURER.
- LIQUID AND GAS REFRIGERANT PIPING FROM BC CONTROLLER TO INDOOR AIR HANDLING UNIT. COORDINATE ROUTING IN THE FIELD. VERIFY QUANTITIES, SIZES AND LINE LENGTHS WITH MANUFACTURER.
- CONDENSATE FROM AIR HANDLING UNIT AND SECONDARY DRAIN PAN TO FLOOR DRAIN. VERIFY DRAIN PIPE SIZES AND QUANTITIES WITH MANUFACTURER.

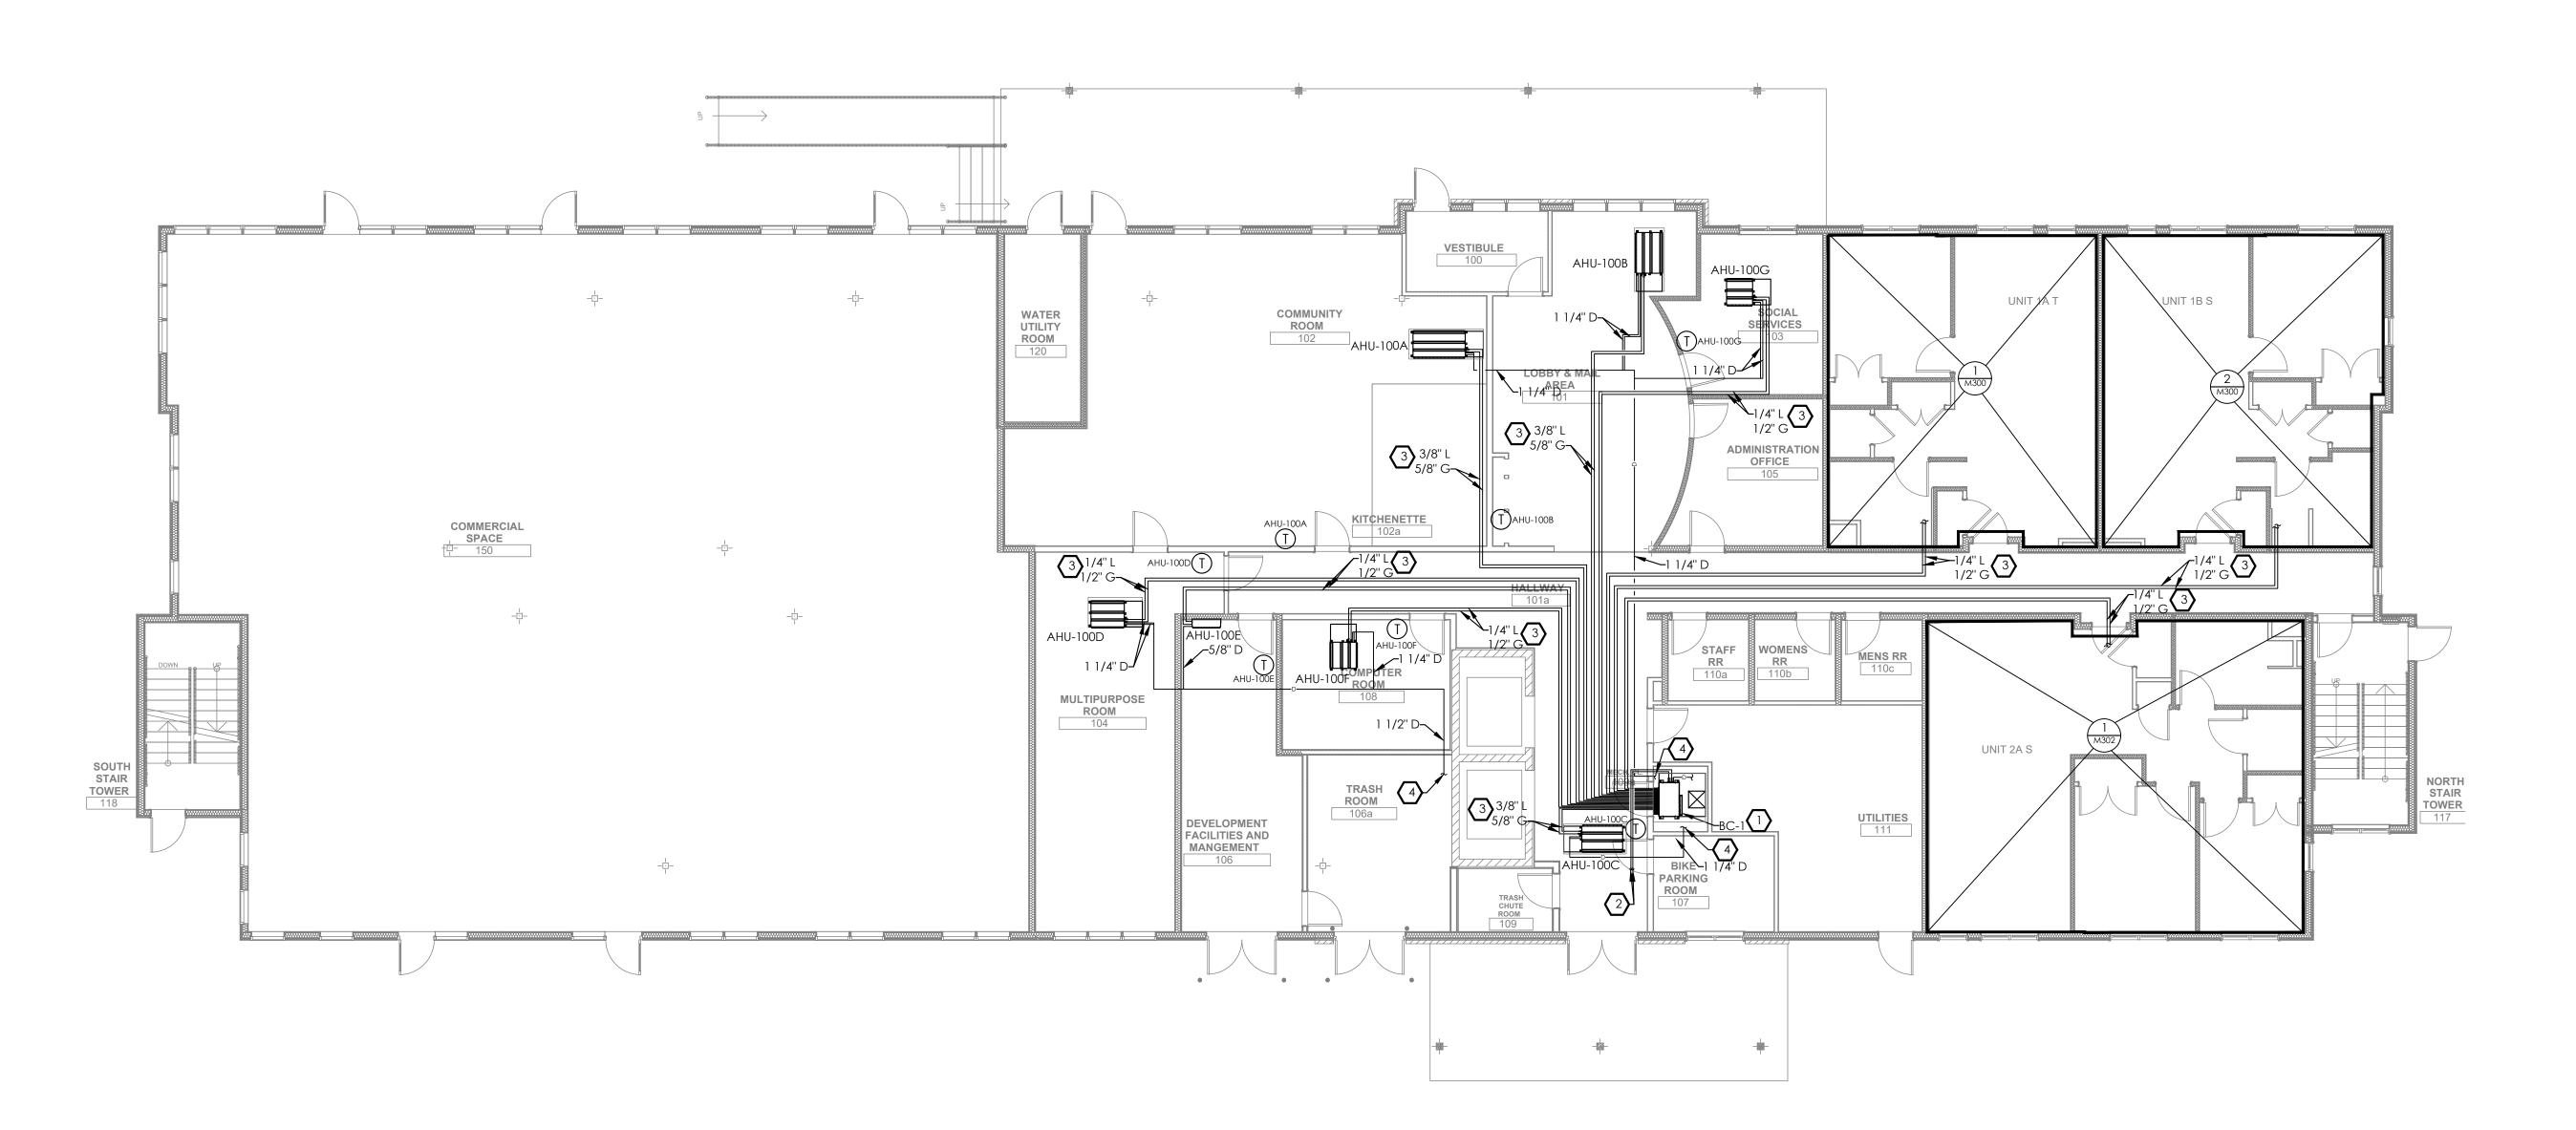



MECHANICAL PIPING FIRST FLOOR PLAN


### Fukui Architects Pc

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revisions

\_project title

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#### **Client:**

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### **Project Location:**

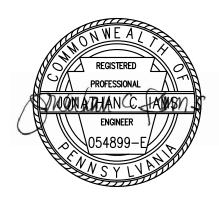Northview Heights Midrise 246 Penfort Street Pittsburgh, PA 15214

drawing title

MECHANICAL PIPING FIRST FLOOR PLAN

As Noted

December 3rd, 2023


**M201** 

**Sheet No.** 

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### **DRAWING NOTES**

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- LIQUID AND GAS REFRIGERANT PIPING FROM ASSOCIATED OUTDOOR UNIT TO BC CONTROLLER. COORDINATE ROUTING IN FIELD. VERIFY QUANTITIES, SIZES AND LINE LENGTHS WITH MANUFACTURER.
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MECHANICAL PIPING SECOND FLOOR PLAN


Fukui Architects Pc
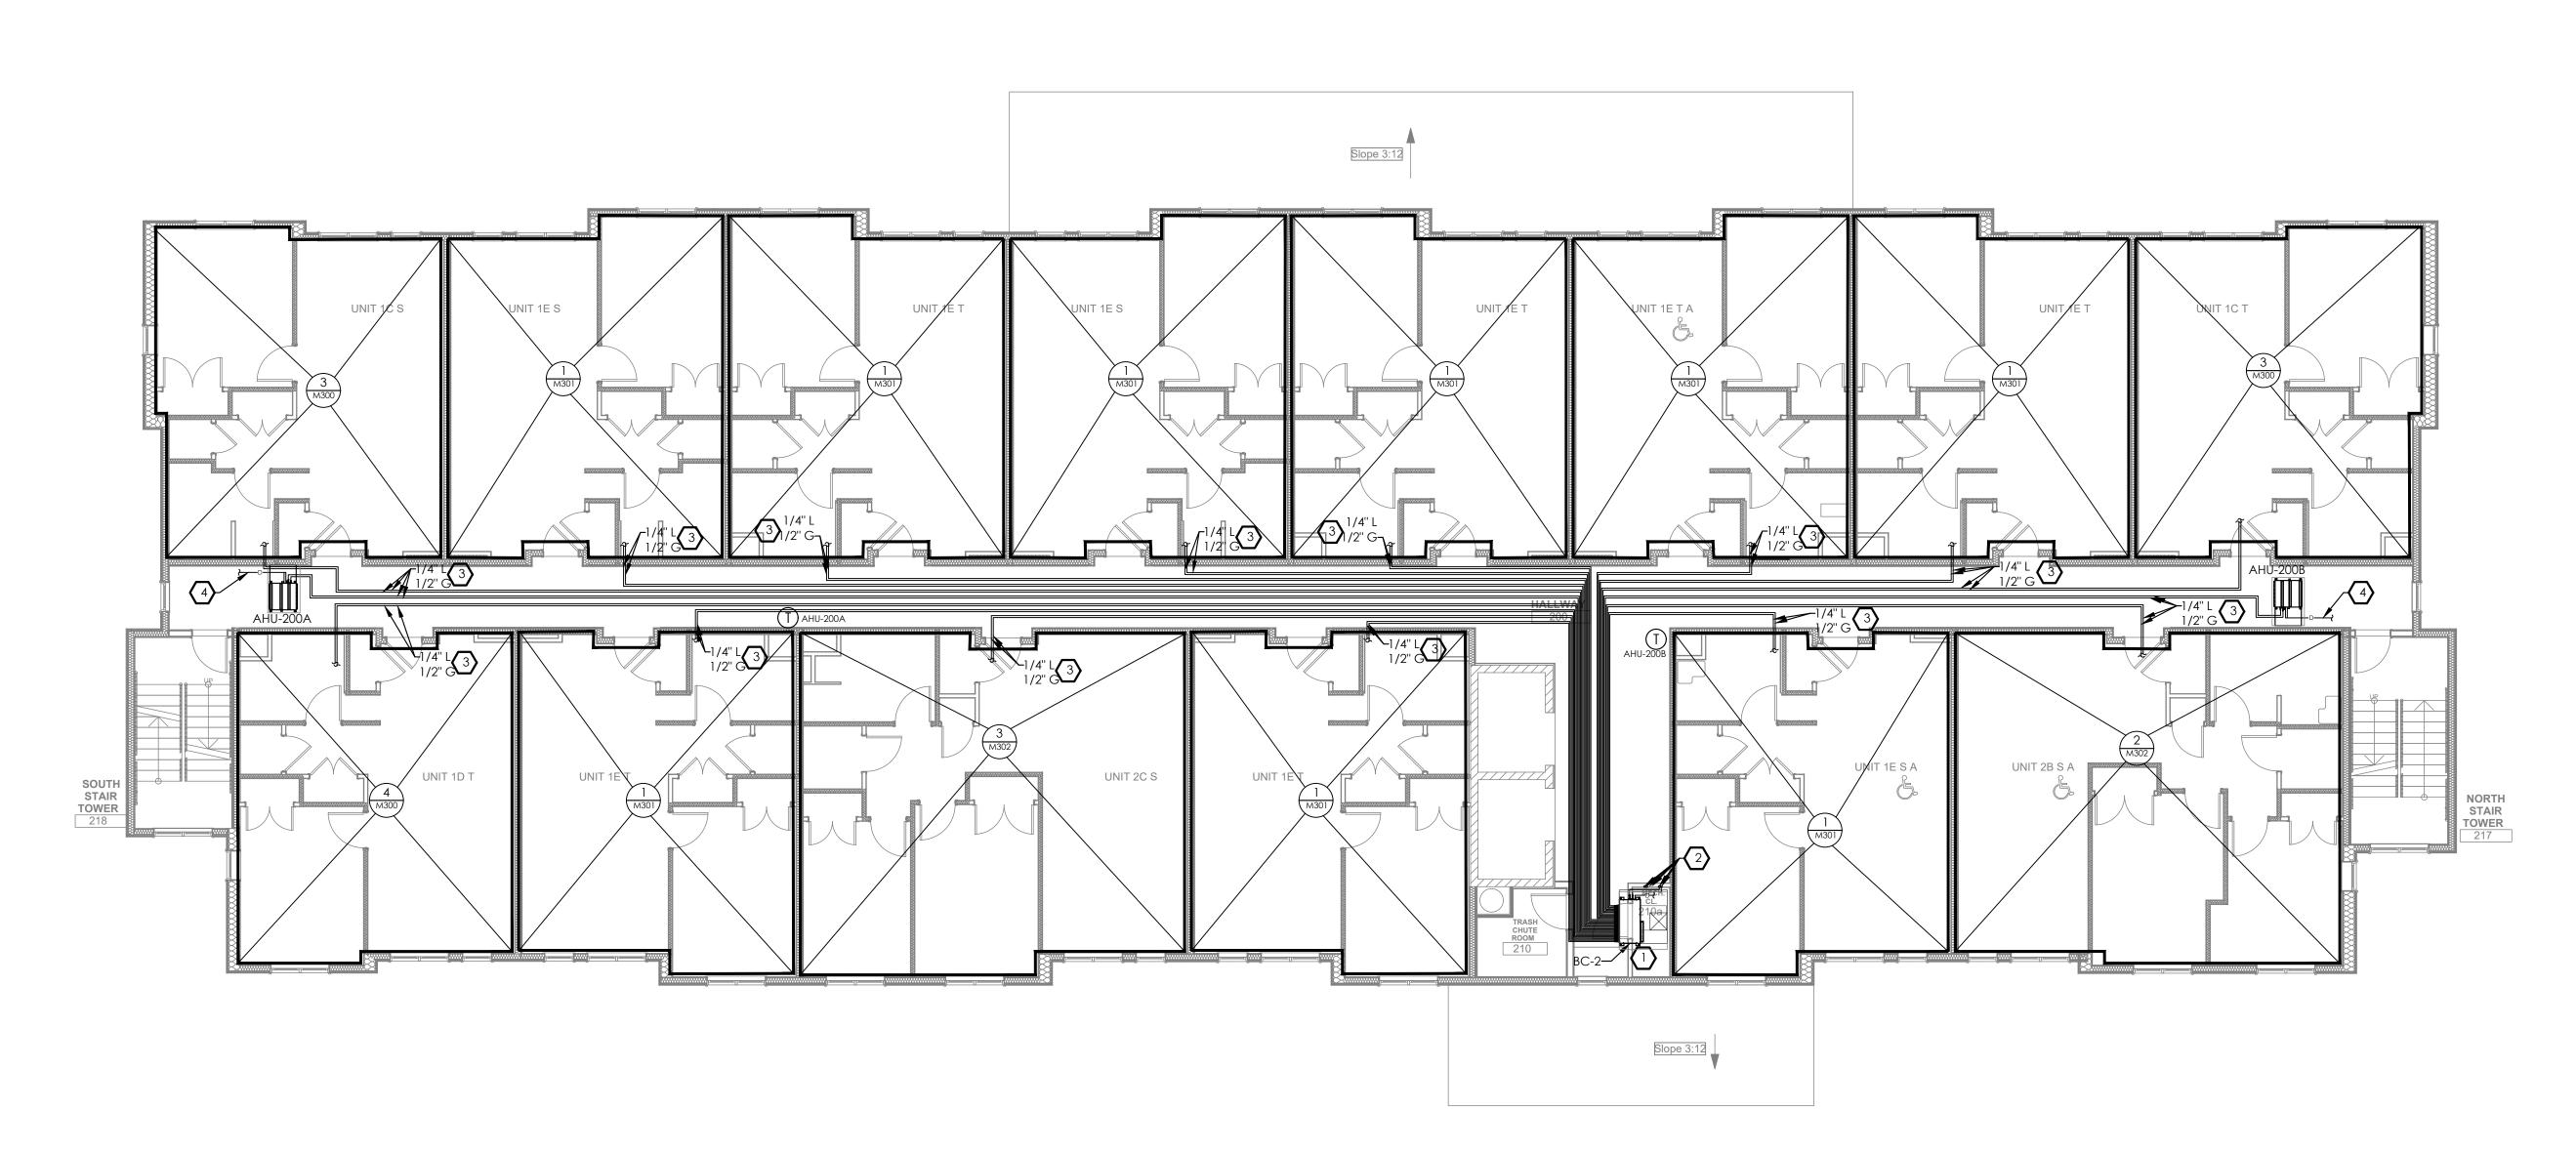
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revisions

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### **Project Location:**

Northview Heights Midrise 246 Penfort Street Pittsburgh, PA 15214

drawing title

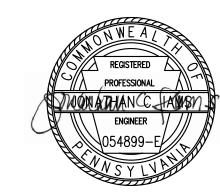MECHANICAL PIPING SECOND FLOOR PLAN

scale As Noted

December 3rd, 2023


**M202** 

Sheet No.

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MECHANICAL PIPING THIRD FLOOR PLAN


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revisions

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### **Project Location:**
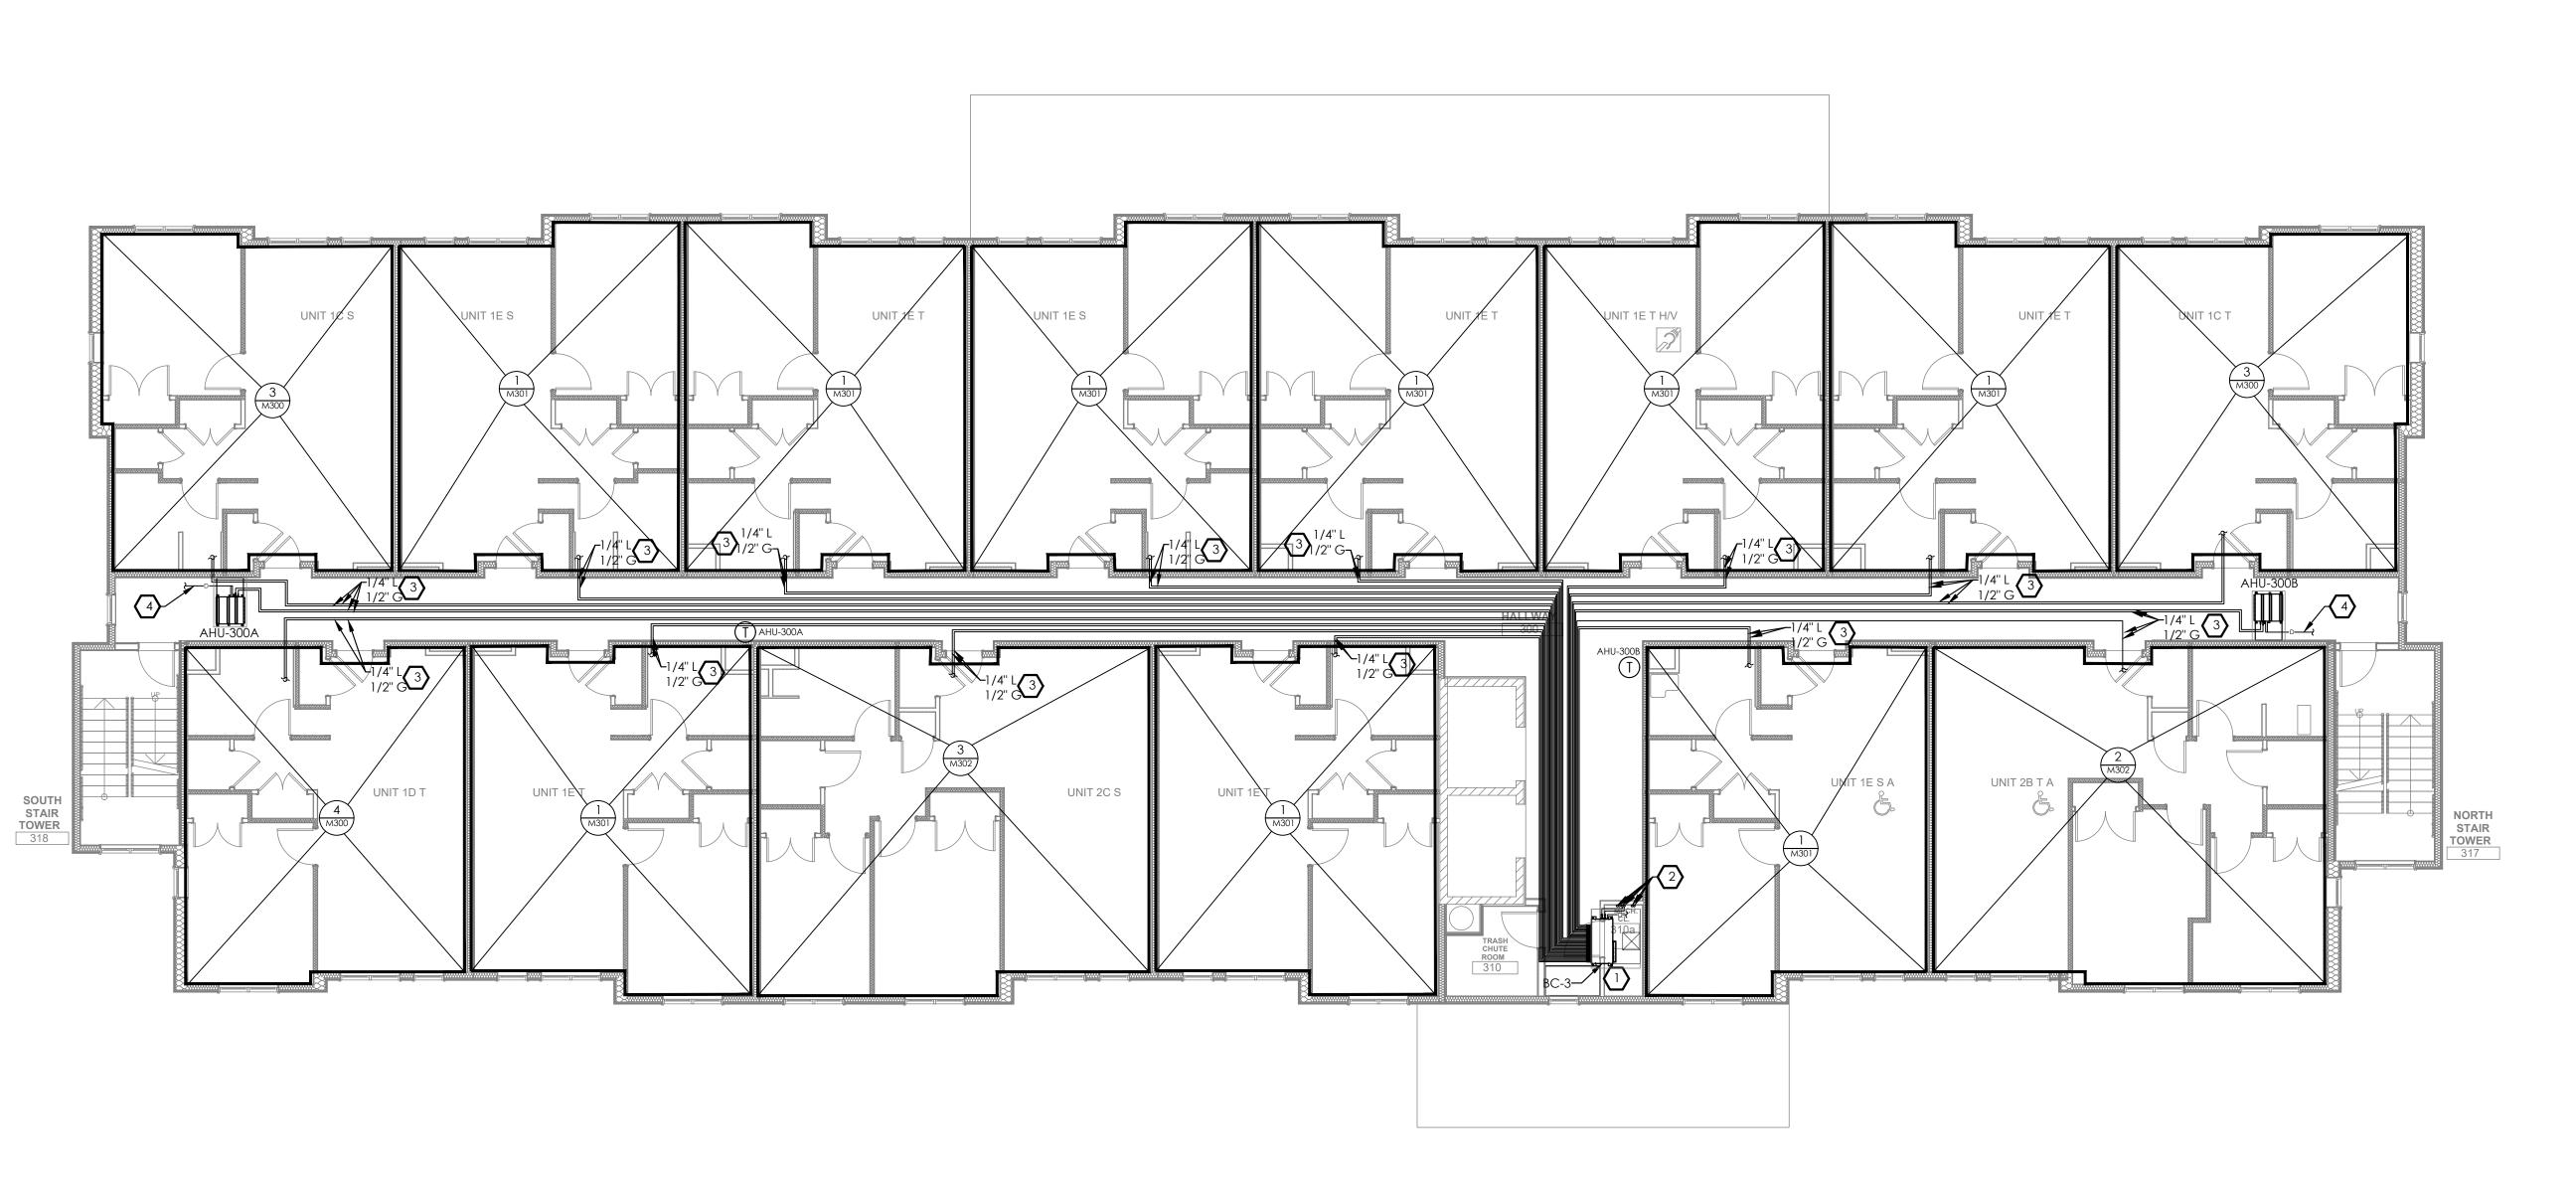
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drawing title

MECHANICAL PIPING THIRD FLOOR PLAN

scale As Noted

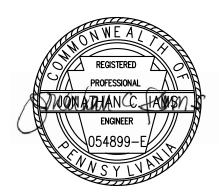December 3rd, 2023

193 233

**M203** 

Sheet No.

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### **DRAWING NOTES**

UNIT 2D S H/V

- INSTALL BC CONTROLLER PER MANUFACTURER'S REQUIREMENTS.
  DISCHARGE CONDENSATE AT FLOOR DRAIN IN MECHANICAL CLOSET.
- LIQUID AND GAS REFRIGERANT PIPING FROM ASSOCIATED OUTDOOR UNIT TO BC CONTROLLER. COORDINATE ROUTING IN FIELD. VERIFY QUANTITIES, SIZES AND LINE LENGTHS WITH MANUFACTURER.
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## Fukui Architects Pc

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revisions

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### **Project Location:**

Northview Heights Midrise 246 Penfort Street Pittsburgh, PA 15214

drawing title

MECHANICAL PIPING FOURTH FLOOR PLAN

scale As Noted

December 3rd, 2023

194 | 233

**M204** 

Sheet No.

Project #2040



UNIT 1G T

UNIT 2E T

UNIT 1G T

AHU-400C

SOUTH STAIR TOWER 418