Northview Heights Midrise

New Building with Apartments and Ammenities 246 Penfort Street, Pittsburgh, PA 15214

Contact Schedule

Note: Any questions concerning the Construction Documents shall first be directed to the Architect. The Architect will forward questions as appropriate to the consulting engineers.

Architect:

Floor 2

Fukui Architects, PC

Pittsburgh, PA 15219

contact: Kento Ohmori, AIA

205 Ross Street

ph: 412.281.6001

fx: 412.281.6002

kento@farpc.com

Owner:

Allies & Ross Management and Development, Corp. 200 Ross Street, Floor 9 Pittsburgh, PA 15219 ph: 412.456.5000

HACP 200 Ross Street, Pittsburgh, PA 15219 contact: Jerome Frank

contact: Jerome Frank

jerome.frank@hacp.org

Iams Consulting, LLC 807 James Street Suite 301 Pittsburgh, PA 15212 ph: 412.697.3590 jiams@iamsconsulting.com

MEP Engineer:

Suite 219 contact: Jonathan C. Iams, P.E

Geotechincal Engineer:

Sci-Tek Consultants, Inc. 655 Rodi Road Suite 303 Pittsburgh, PA 15235 ph: 412.371.4460 contact: Jason Baguet

Structural Engineer:

Providence Engineering, Corp. 4955 Steubenville Pike, Pittsburgh, PA 15205 ph: 412.407.2250 nateb@proveng.com contact: Nate Babyak, P.E.

Civil Engineer:

Red Swing, Group Penn Office Building 4314 Old William Penn Hwy, Suite 101 Monreville, PA 15146 ph: 724.325.1215 matthew.smith@redswinggroup.com contact: Matthew E. Smith, P.E.

Engergy Performance Engineer:

Building Performance Architecture, LLC. 2121 Noblestown Road, Pittsburgh, PA 15205 ph: 412.441.1075 rhosken@buildingperformarch.com contact: Rob Hosken, AIA, C.E.M.

Landscape Architect:

UpStudio Landscapes, LLC. 606 Liberty Ave Suite 226 Pittsburgh, PA 15222 ph: 412.203.3524 contact: Elizabeth A. Dugan, PLA

Plan Review & Inspection:

City of Pittsburgh Department of permits, Licenses and Inspections 200 Ross Street 3rd floor, room 320 Pittsburgh, PA 15205 ph: 412.255.2175

Code Conformance Information

Applicable Codes 2018 International Building Code Accessibility: ANSI/ICC A117.1 2009

2018 IBC Chapter 11 and related provisions in other chapters Section 504 of the Federal Rehabilitation Act of 1973 The Fair Housing Act of 1988 7 Fair Housing Design Manual Uniform Federal Accessibility Standards (UFAS) PFHA Visitablity (per Submission Guide Section 1.08) 2018 International Energy Conservation Code

Electrical: 2017 NEC (NFPA 70) 2018 International Fire Code Fuel Gas: 2018 International Fuel Gas Code Mechanical: 2018 International Mechanical Code

Plumbing: 2017 Allegheny County Health Department Plumbing Code Fire Alarm: 2016 NFPA 13

Contractor:

PDDM Solutions, LLC. 125 Technology Drive Suite 101 Canonsburgh, PA 15317 ph: 724.788.4040 contact: Steve Twiss


Signatures

Owner:	date:
Contractor:	date:
Architect:	date:
PHFA:	date:

PHFA Project No. 2023-XXX (fka 2021-156)

Project Location

PITTSBURGH, PENNSYLVANIA

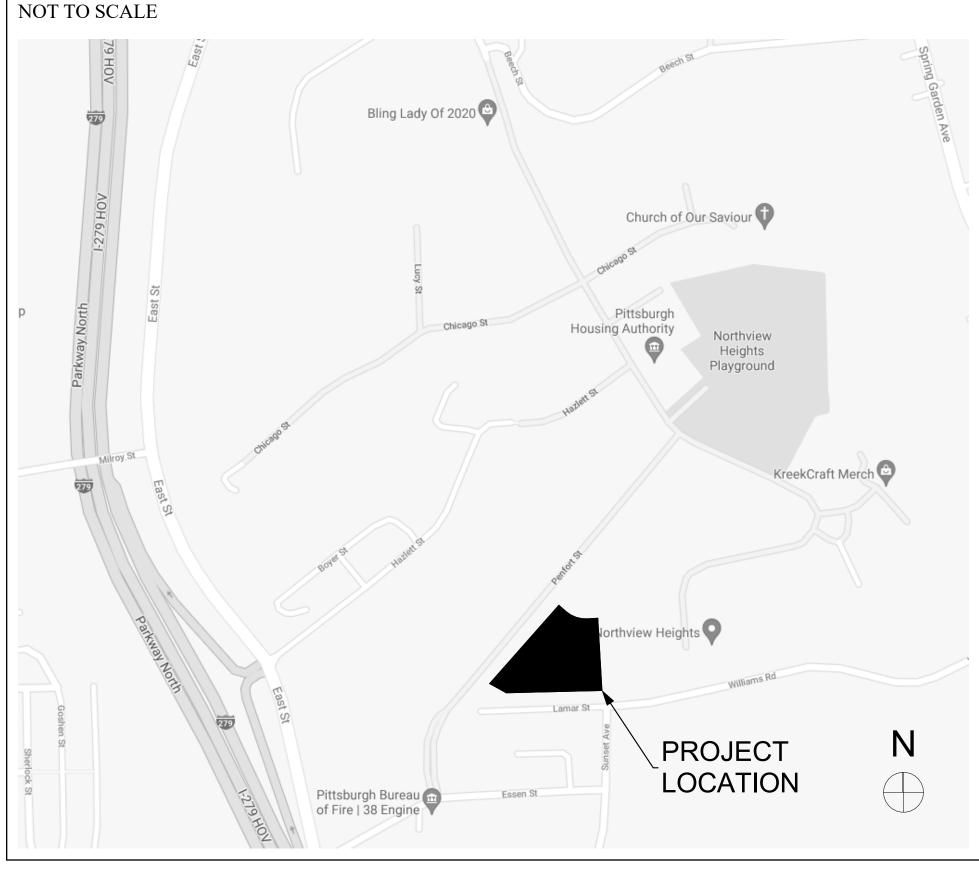

A.F.F.	Above Finish Floor	EQUIP.	Equipment	MISC.	Miscellaneous
A.P.	Access Panel	E.F.	Exhaust Fan		
ACOUST.	Acoustical	EXIST.	Existing	N.I.C.	Not In Contract
A.C.T.	Acoustical Ceiling Tile	EXP.	Expansion	N.T.S.	Not To Scale
ADH.	Adhesive	E.J.	Expansion Joint		
ADJUST.	Adjustable	ESH	Exterior Sheathing	O.C.	On Center
A/C	Air Conditioning	EXIST.	Existing	OPP.	Opposite
ALT.	Alteration	EXP.	Exposed	O.H.	Overhead
ALTN.		EXT.	Exterior	0.11.	Overnead
	Alternate			PR.	Dain
ALUM. A.O.R.	Aluminum Area of Refuge	E.I.F.S.	Exterior Insulation & Finish System	PLAS.	Pair Plaster
APPROX.	Approximate	F.R.P.	Fiberglass Reinforced Polyester	PLAS.LAM.	Plastic Laminate
ARCH.	Architectural	F.F.	Finish Floor	P.C.	Plumbing Contractor
ASB.	Asbestos	FIN	Finish	PLYWD.	Plywood
		FIN.FLR.	Finish Floor	POLY.	Polyethylene
ASPH.	Asphalt	F.A.C.P.	Fire Alarm Control Panel	P.V.C.	Polyvinyl Chloride
AUTO.	Automatic	F.E.	-	PRE-FAB.	Prefabricated
AVG.	Average		Fire Extinguisher	PRE-FAD.	Freiabilcaled
DLIZ	B	FLR.	Floor	DE	D (T
BLK.	Block	F.D.	Floor Drain	RE.	Refer To
BD.	Board	FTG.	Footing	REF.	Refrigerator
ВОТ	Bottom			R.C.P.	Reinforced Concrete Pip
BLDG	Building	GA.	Gauge	REINF.	Reinforcement
		G.C.	General Contractor	RD.	Roof Drain
C.I.P.	Cast In Place	G.F.I.	Ground Fault Interrupter	RM.	Room
C.B.	Catch Basin	GYP.	Gypsum		
CEM.	Cement	G.W.B.	Gypsum Wall Board	S.A.T.	Suspended Acoustical Ti
CER.	Ceramic	GSH GSH	Gypsum Sheathing	SCHED.	Schedule
CG	Corner Guard	l Gon	Gypsulli Sileatillig	SHT.	Sheet
C.M.T.		H/C	Handicap	SIM.	Similar
C.W.T.	Ceramic Mosaic Tile	H.V.A.C.	•	S.C.	Solid Core
_	Ceramic Wall Tile		Heating, Ventilation &	-	
C.O.	Cleanout	HT	Height	SPECS.	Specifications
င	Center Line	HC	Hollow Core	SQ.	Square
CLO.	Closet	H.M.	Hollow Metal	S.F.	Square Foot
C.W.	Cold Water	HORIZ.	Horizontal	S.S.	Stainless Steel
CLG.		HR.	Hour	STL.	Steel
	Ceiling	H.W.	Hot Water	STOR.	Storage
COL.	Column	INI		STRUCT.	Structural
CONC.	Concrete	IN.		0111001.	ou dotard.
C.M.U.	Concrete Masonry Unit		Inch	TEL.	Telephone
CONT.	Continuous	I.M.	Insulated Metal	THK.	Thick
CORR.	Corridor	INSUL.	Insulation or Insulated		
C.M.P.	Corrigated Metal Pipe	INT.	Interior	T.B.D.	To Be Determined
CRS.	Courses	INV.	Invert	T&G	Tongue & Groove
J. 10.		ISO.	Isolation	T.O.	Top Of
DIA.	Diameter			T.G.	Top Of Grade
DET	Detail	JAN.	Janitor's Closet	T.O.S.	Top Of Steel
DGL	Detail Dens Glass Gold	J.T.	Joint	TYP.	Typical
DGL DR.	Door	J.1.	JOHN		
		LAM.	Laminate	UNFIN.	Unfinished
DN.	Down			U.N.O.	Unless Noted Otherwise
D.S.	Downspout	LAV.	Lavatory	\/ B	\/ D
DWG.	Drawing	LG.	Long	V.B.	Vapor Barrier
D.F.	Drinking Fountain			VFY	Verify
D.I.P.	Ductile Iron Pipe	M.D.F.	Medium Density Fiberboard	V.I.F.	Verify In Field
	· -·· · · · r -	M.D.H.	Magnetic Door Holder	VERT.	Vertical
EA.	Each	M.H.	Manhole	VEST.	Vestibule
E.W.		MFGR.	Manufacturer	V.C.T.	Vinyl Composition Tile
ELEC.	Each Way	MAX.	Maximum		•
	Electrical		Mechanical	W.H.	Water Heater
E.C.	Electrical Contractor	MECH.	Metal	W.W.F.	Welded Wire Fabric
EL.	Elevation	MET.		WIN.	Window
ELEV.	Elevation	MIN.	Minimum	W/	With
				W/O	Without
				WD.	Wood

1st Floor:			12,115	11,191		
100	Vestiblue	Circulation	100	88		
	Lobby & Mail Area	Residential Common	475			
	-	_				
	Hallway	Circulation	895	840		
102 & 102a	Community Room & Kitchenette	Residential Common	1,125	982		
	Social Services	Residential Common	151	144		
	Multi-Purpose Room	Residential Common	460	424		
		_				
	Administration Office	Residential Common	170	154		
106	Development Facilities and Maintenance	Residential Common	280	261		
	Trash Room	Residential Common	210	196		
	Bike Parking Room	Residential Common	100	88		
	-					
	Computer Rooom	Residential Common	180	167		
109	Trash Chute Room	Residential Common	55	46		
109a	Mechanical Closet	Residential Common	32	27		
	Staff Restroom	Residential Common	55			
110b	Womens Restroom	Residential Common	55	49		
110c	Mens Restroom	Residential Common	55	49		
111	Utilities	Residential Common	360	336	180	168
					100	100
	North Stair Tower	Circulation	175	145		
118	South Stair Tower	Circulation	165	135		
120	Water Utility Room	Residential Common	126	110	63	55
150	Commerical Space	Residential Common	4,500	4,288		
	·	_				
	1 Bedroom, Type B	Residential Unit		nit Plan		
Unit 1B S	1 Bedroom, Type B	Residential Unit	See U	nit Plan		
Unit 2A S	2 Bedroom, Type B	Residential Unit	See U	nit Plan		
0 m d E1 -			40.40	22.0=0		
2nd Floor:			12,424	-		
200	Hallway	Residential Common	1,470	1,335		
210	Trash Chute Room	Residential Common	60	48		
	Mechanical Closet	Residentia Common	32			
	North Stair Tower	Circulation	175			
218	South Stair Tower	Circulation	165	135		
Unit 1C S	1 Bedroom, Type B	Residential Unit	See U	nit Plan		
	1 Bedroom, Type B	Residential Unit	_	nit Plan		
	- 1					
Unit 1E T	1 Bedroom, Type B	Residential Unit	See U	nit Plan		
Unit 1E S	1 Bedroom, Type B	Residential Unit	See U	nit Plan		
	1 Bedroom, Type B	Residential Unit	See II	nit Plan		
	1 Bedroom, Type A	Residential Unit	_	nit Plan		
	• • • • • • • • • • • • • • • • • • • •	-	_			
	1 Bedroom, Type B	Residential Unit		nit Plan		
Unit 1C T	1 Bedroom, Type B	Residential Unit	See U	nit Plan		
	1 Bedroom, Type B	Residential Unit	See II	nit Plan		
	1 Bedroom, Type B	Residential Unit	_	nit Plan		
	• • • • • • • • • • • • • • • • • • • •	-	_			
	2 Bedroom, Type B	Residential Unit		nit Plan		
Unit 1E T	1 Bedroom, Type B	Residential Unit	See U	nit Plan		
Unit 1F S A	1 Bedroom, Type A	Residential Unit	See II	nit Plan		
		Residential Unit	_	nit Plan		
OTHE ZD S A	2 Bedroom, Type A	r vesideriudi Utill	See U	inti iali		
3rd Floor:			12,406	11,950		
300	Hallway	Residential Common	1,470	1,335		
	Trash Chute Room	Residential Common	60			
		-		-		
	Mechanical Closet	Residentia Common	32			
317	North Stair Tower	Circulation	175	145		
318	South Stair Tower	Circulation	165	135		
	1 Bedroom, Type B	Residential Unit		nit Plan		
			_			
Unit 1E S	1 Bedroom, Type B	Residential Unit	See U	nit Plan		
Unit 1E T	1 Bedroom, Type B	Residential Unit	See U	nit Plan		
	1 Bedroom, Type B	Residential Unit	See H	nit Plan		
			_			
	1 Bedroom, Type B	Residential Unit	_	nit Plan		
Jnit 1E T H/V	1 Bedroom, Type B, Hearing/Vision	Residential Unit	See U	nit Plan		
Unit 1E T	1 Bedroom, Type B	Residential Unit	See U	nit Plan		
	1 Bedroom, Type B	Residential Unit	_	nit Plan		
Unit 1D T	1 Bedroom, Type B	Residential Unit	See U	nit Plan		
Unit 1E T	1 Bedroom, Type B	Residential Unit	See U	nit Plan		
	2 Bedroom, Type B	Residential Unit	See H	nit Plan		
	• • • • • • • • • • • • • • • • • • • •	-		nit Plan		
	1 Bedroom, Type B	Residential Unit				
Unit 1E S A	1 Bedroom, Type A	Residential Unit	See U	nit Plan		
Unit 2B T A	2 Bedroom, Type A	Residential Unit	See U	nit Plan		
4.1						
4th Floor:			11,432	11,000		
400	Hallway	Residential Common	1,470	1,335		
402	Communal Room	Residential Common	410			
	Trash Chute Room	Residential Common				
			60			
	Mechanical Closet	Residential Common	32	24		
415	Laundry Room	Residential Common	290	264		
	North Stair Tower	Circulation	175			
	South Stair Tower	Circulation	165			
Unit 1F S	1 Bedroom, Type B	Residential Unit	See U	nit Plan		
	1 Bedroom, Type B	Residential Unit		nit Plan		
	1 Bedroom, Type B	Residential Unit		nit Plan		
Unit 1G T	1 Bedroom, Type B	Residential Unit	See U	nit Plan		
Unit 1G S	1 Bedroom, Type B	Residential Unit	See U	nit Plan		
	1 Bedroom, Type B	Residential Unit		nit Plan		
	1 Bedroom, Type B	Residential Unit	See U	nit Plan		
Unit 1G S	1 Bedroom, Type B	Residential Unit	See U	nit Plan		
	1 Bedroom, Type B	Residential Unit	See II	nit Plan		
	1 Bedroom, Type B			nit Plan		
	• • •	Residential Unit				
Unit 1G T A	1 Bedroom, Type A	Residential Unit	See U	nit Plan		
	2 Redroom Type B. Hearing/Vision	Residential Unit		nit Plan		

See Unit Plan

Unit 2D S H/V 2 Bedroom, Type B, Hearing/Vision Residential Unit

Project Summary

General Building / Project Information

Unit Count & Gross Square Footage

Unit Type

1 Bedroom / 1 Bath

2 Bedroom / 1 Bath

Total: 43 Units

New Construction

A-3, R-2, S-1, M, B

Ansi Type B

Gross S.F.

12,115

Yes

BUILDING SQUARE FOOTAGE MATRIX

48,377 G.S.F. 12,115 G.S.F. 1st Floor. 12,424 G.S.F. 2nd Floor.

Ansi Type A

6 (Twice 5%)

Net S.F.

12,406 G.S.F. 3rd Floor. 11,432 G.S.F. 4th Floor.

Hearing / Vision Impaired

2 (Twice 2%)

50% Gross S.F 50% Net S.F

Classification of Work:

Occupancy Group:

Construction Type:

Gross Area:

Sprinklers:

644

Space # Space Name

1st Floor:

Fire Alarm:

Fukui Architects Pc

Ross Street Pittsburgh, Pennsylvania 15219 ph 412.281.6001 fx 412.281.6002

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general notes Any conflicts in the drawings or between new and

existing construction shall be referred to the Architect.

2. Contractor shall verify all dimensions and existing conditions in the field and shall advise Fukui Architects. Pc of any discrepancies between, additions to, deletions from, or alterations to any and all conditions prior to proceeding with any phase of work. Do not scale

- 3. All work shall be installed in accordance with applicable codes and regulations.
- 4. Contractor shall be responsible for the patching, repairing, and preparations of all existing floor, wall, and
- ceiling surfaces as required to receive scheduled finishes. 5. All items shown on drawings are finished construction assemblies. Contractor shall provide and install all

material required for finished assemblies.

6. All reports, plans, specifications, computer files, field data, notices, and other documents and instruments prepared by the Architect as instruments of service shall remain the property of the Architect. The Architect shall retain all common law statutory, and other reserved rights, including the copyright thereto.

project title

Owner:

HACP 200 Ross Street Pittsburgh,PA,15219

Client:

Allies & Ross Management and Development Corporation (ARMDC) 200 Ross Street Pittsburgh, PA 15219

Project Location:

Northview Heights Midrise 246 Penfort Street Pittsburgh, PA 15214

COVER SHEET

As Noted					
date					
December					
no.	of.				
1	233				

Sheet No.

drawing title

TS01 Project #2040

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Client:

Owner:

200 Ross Street

Pittsburgh, PA, 15219

HACP

Allies & Ross Management and Development Corporation (ARMDC) 200 Ross Street Pittsburgh, PA 15219

Fukui Architects Pc

Pittsburgh, Pennsylvania 15219

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general notes

revisions

project title

Any conflicts in the drawings or between new and

conditions in the field and shall advise Fukui Architects,

Pc of any discrepancies between, additions to, deletions

from, or alterations to any and all conditions prior to

proceeding with any phase of work. Do not scale

existing construction shall be referred to the Architect.

2. Contractor shall verify all dimensions and existing

3. All work shall be installed in accordance with applicable

Contractor shall be responsible for the patching,

5. All items shown on drawings are finished construction

material required for finished assemblies.

rights, including the copyright thereto.

repairing, and preparations of all existing floor, wall, and

ceiling surfaces as required to receive scheduled finishes.

assemblies. Contractor shall provide and install all

All reports, plans, specifications, computer files, field

data, notices, and other documents and instruments

prepared by the Architect as instruments of service shall

remain the property of the Architect. The Architect shall

retain all common law statutory, and other reserved

codes and regulations.

205 Ross Street

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Project Location:

Northview Heights Midrise 246 Penfort Street Pittsburgh, PA 15214

DRAWING INDEX

As Noted December 3rd, 2023

Sheet No.

drawing title

TS02

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Code Conformance Information
 4-STORY APARTMENT BUILDING WITH (43) 1 & 2 BEDROOM UNITS
 APPLICABLE CODES:
  General:
Accessibility:
                                                                                                           2018 IBC Chapter 11 and related provisions in other chapters Section 504 of the Federal Rehabilitation Act of 1973,
                                                                                                           The Fair Housing Act of 1988,
The Fair Housing Design Manual,
                                                                                                           Uniform Federal Accessibility Standards (UFAS)
                                                                                                          PFHA VisitAbility (per Submission Guide Section 1.08)
2018 International Energy Conservation Code
2017 NEC (NFPA 70)
                                                                                                           2018 International Fire Code
                                                                                                           2018 International Fuel Gas Code
2018 International Mechanical Code
                                                                                                           2017 Allegheny County Health Department Plumbing Code
  2018 IBC:
IBC Chapter 3: Use and Occupancy Classification
                                                                                                           Community Room: on First Floor
Offices: all on First Floor
   Business B:
                                                                                                           Dwelling units, communal rooms, Central Laundry Room as accessory per 509.2
  Residential R-2:
                                                                                                           Residential R-2: on all floors. R-2 is the only Occupancy above the First Floor. Maintenance Room, Trash Room: on First Floor
  Moderate-Hazard Storage S-1:
 Business B & Mercantile M:
                                                                                                           Commercial Space: on First Floor
 IBC Chapter 5: General Building Height & Area
                                                                                                           70 ft. (average ground level to top of roof) per 504.3, 3 Stories (above grade) per 504.4
  Allowable Height for A-3 w/S1:
  Allowable Area for A-3 w/ S1:
Allowable Height for B w/ S1:
                                                                                                          46,000 s.f. per 506.2
70 ft. per 504.3, 4 Stories per 504.4
  Allowable Area for B w/S1:
                                                                                                           56,000 s.f. per 506.2
  Allowable Height for M w/ S1
Allowable Area for M w/ S1:
                                                                                                           70 ft. per 504.3, 4 Stories per 504.4
                                                                                                           70 ft per 504.3, 4 Stories per 504.4
   Allowable Height for R-2 w/ SM
   Allowable Area for R-2 w/ SM
                                                                                                           36,000 sf. per 506.2
                                                                                                             70 ft. per 504.3, 4 Stories per 504.4
   Allowable Area for S-1 w/ S1:
                                                                                                           56,000 s.f. per 506.2
   Frontage Increase:
 Actual Height and Area:
Occupancies are Separated per 508.4:
                                                                                                        60 ft., 4 Stories, approx. 12,000 sf. per Floor. Residential R-2: is the only Occupancy above the First Floor. A-3/R-2, B, M, S-1 = 1 Hour. R-2/B, M, S-1 = 1 Hour.
 IBC Chapter 6: Type of Construction
  Bearing Exterior Walls:
   Bearing Interior Walls:
                                                                                                             1 Hour (UL U305)
   Nonbearing Interior Walls:
                                                                                                           1 Hour (UL L528, UL G551)
  Floor/Ceiling Construction
                                                                                                           1 Hour (UL P533, UL P522, UL U415)
2 Hour (UL U906, UL U438)
Unit Demising Walls:
                                                                                                           1 Hour (UL U311)
 IBC Chapter 7: Fire and Smoke Protection Features:
                                                                                                           1 Hour per 709.3
  Unit Demising Walls:
Chute Access Room: Walls/Floors
                                                                                                          1 Hour per 713.13.3
2 Hour per 713.13.4
2 Hour per 709.3
     Chute Discharge Room: Walls/Ceiling
  Shafts Walls:
  Draftstopping in Floors:
                                                                                                           Fire Draftstopping not required per 718.3 Exception. Air Compartmentalization is provided at the demising line between R-2 Units
  Draftstopping in Attics:
                                                                                                          Fire Draftstopping not required per 718.4 Exception.
 IBC Chapter 9: Fire Protection System:
                                                                                                          NFPA 13 per 903.3.1.1
                                                                                                          NFPA 13 per 903.3.1.
 Residential R-2:
Moderate-Hazard Storage S-1:
                                                                                                          NFPA 13 per 903.3.1.
  Commercial Space: Business B:
                                                                                                           NFPA 13 per 903.3.1.
   Commercial Space: Mercantile M:
                                                                                                          NFPA 13 per 903.3.1.1
   Class 1 Standpipe System in accordance with 905.4 per 905.3.1
Fire Alarm and Detection System:

A Manual Fire Alarm System shall be installed per 907.2.9.1
Single and Multiple Station Smoke Alarms shall be installed in each R-2 Dwelling Unit per 907.2.11.2 and interconnected per 907.2.10.5

    • Provide one 1-A:10-B:C per R-2 Dwelling Unit per 906.1.1 exception 1.
    • Ordinary Hazard Classification and Class A fire hazard; Ordinary fuel load; Minimum size: 2-A per extinguisher and travel distances limited to 75° from any point per 906.3.

    Provide one in the S-2 area.

Provide two per floor in the R-2 Hallway
Provide one in the Commercial Space.

IBC Chapter 10: Means of Egress:
Occupant Load Factor per function of space: per 1004.5
                                                                                          OCCUPANCY LOAD CALCULATION
                                                                                                                                                           3RD FLOOR
                                                                                               1ST FLOOR 2ND FLOOR
             FUNCTION OF SPACE
                                                                                           5,128 26
                                                                                                                                                       12,406 63
   MECHANICAL
   BUINESS AREA
   ASSEMBLY W/O FIXED SEATING
   BUINESS AREA / MERCANTILE AREA

    Accessible Means of Egress to (2) Exits or Exit Access Doorways on each floor and from the A-3 Community Room, per 1006.2.1, 1009.1

          • In a sprinklered building where two exists, exist access doorways, or exit access stairways are required, they shall be distanced at least one-third the length of the maximum overall diagonal of the building or area served as measured in a straight line. The exit separation may be measured along the shortest direct line of travel within a 1 hour rated corridor connecting exit stairways per 1007.1.1

• Exit Access Travel Distance with Sprinkler System maximum 250 ft per 1017.2. Exit Access shall be measured along the unobstructed path to the entrance to an exit. This includes the measurement along the center
             of stairways made tangent to tread nosings per 1017.3.1
            • The loss of any one exit shall not reduce the available capacity or width to less than 50% of the required capacity or width per 1005.5
• One Accessible Means of Egress from the 4th Floor must be an Elevator complying with 1009.4 per 1009.2.1
• For Assembly A-3 the common path of egress travel shall not exceed 30 feet from any seat to a point where an occupant has a choice of two paths of travel to two exits per 1029.8
            • Exit Access Travel Distance with Sprinkler System maximum 250 ft per 1017.2. Exit Access shall be measured along the unobstructed path to the entrance to an exit per 1017.3

    Exit Access shall not pass through a room that can be locked to prevent egress per 1016.2
    Exits shall discharge directly to the exterior of the building at grade per 1028.1 and shall provide direct and unobstructed access to a public way per 1028.5
    Area of Refuge not required for stair in sprinklered buildings per 1009.3.3 or at elevators in sprinklered buildings per 1009.4.2
    Corridors shall be at least 44 inches in width per 1020.2 and unobstructed per 1020.3
     • Minimum clear width of means of egress doors shall be 32 inches as measured between the door face and the stop when the door is open 90 degrees per 1010.1.1. 1st floor egress components other than stairways shall have a capacity of at least (174)*0.2 = 34.8 inches per 1005.3.2

• Common area egress doors, when fully opened, shall not reduce the required width by more than 7 inches. Doors in any position shall not reduce the required width by more than one-half per 1005.7.1

    Corridor walls will be 1-hour fire rated and shall be at least 0.5hr fire rated per 1020.1
    Maximum dead ends shall be at most 20 feet unless the ratio of length to width of the dead-end corridor is less than 2.5 per 1020.4

     • Accessible Stairways must have a clear with of 48 inches in sprinklered buildings per 1009.3.2. Both Stairways will be accessible. Egress Stairway capacity shall be at least 63*0.3 = 18.9 inches wide per 1005.3

• Stairway headroom clearance shall be at least 80 inches measured vertically from a line connecting the edge of the nosings per 1011.3

• Stair riser heights shall be 7 inches maximum and 4 inches minimum. Rectangular tread depth shall be 11 inches minimum per 1011.5.2
        • Stairway landings shall be not less than the width of the stairway served. Doors opening onto a landing shall not be reduced the landing to less than one-half the required width per 1011.6
• Stairways shall have handrails on both sides per 1011.11 with gripping surfaces continuous per 1014.4
• Handrails for stairways shall extend horizontally at least 12 inches beyond the top riser and continue to slope for the depth of one tread beyond the bottom riser per 1014.6
        • Interior Exit Stairways shall have a 2-hour fire rated enclosure per 1023.2 and terminate at an exit discharge or public way per 1023
 Roof Decks: Guards shall be located along open walking surfaces located more than 30 inches above the floor or grade below per 1015.2

• Guards shall be at least 42 inches high with prevent the passage of a 4-inch sphere per 1015.3 and 1015.4

    Guards shall be provided if the roof hatch opening is within 10 feet of a roof edge per 1015.7

   Emergency Escape and Rescue Openings required in Unit Bedrooms per 1030.1
   Maintenance areas are not required to be accessible per 1103.2.9
   Accessible Route:

• There shall be an accessible route within the site from public transportation, accessible parking, accessible passenger loading, and sidewalks to the accessible building entrance per 1104.1 and this route shall connect all

    A single accessible route may pass through a kitchen in an Accessible unit per 1104.5

     • At least 60% of all public entrances shall be accessible per 1105.1

At least one accessible entrance shall be provided to each tenant space per 1105.1.6
At least one accessible entrance shall be provided to each dwelling unit per 1105.1.7

     • For 26-50 parking spaces provided, at least 2 shall be accessible spaces per 1106.1 including at least one accessible van space per 1106.5

    All units shall comply with ANSI 1117.1-2009 per 1107.2

Common rooms and patio shall be accessible per 1107.3

A minimum of 2% of the total dwelling units (or at least one unit) must be "Type A" per 1107.6.2.2.1

All other dwelling units must be "Type B" per 1107.6.2.2.2
  Common Facilities:
• Each common toilet room shall be accessible per 1109.2

The kitchenette shall be accessible per 1109.4
For dining surfaces in common areas, at least 5%, but not less than one, of the dining surfaces shall be accessible.

    At least two drinking fountains shall be provided, with at least 50% for people who use a wheelchair per 1109.5.1
    At least 5% of work surfaces shall be provided as accessible per 1109.11

    All recreational facilities will be accessible per 1110.2

       • Attic ventilation shall not be less than 1/300th of the area of the attic per 1202.2.1, Exception 2
       • Occupiable spaces shall have a ceiling height of not less than 7'-6" per 1207.2.
       • Attics with a clear height of over 30" shall be provided access by an opening of not less than 20" x 30" per 1208.2
 COMcheck shall demonstrate building envelope complies as a Commercial Building.
  ANSI/ICC 117.1 2009
Type A Accessible Dwelling Units:

    Accessible route shall connect all elements of the unit.
    All rooms served by accessible route shall provide a turning space.

    Maneuvering clearance for Entry doors and all other doorways for user passage.

        • Operable parts must comply with 309 with exceptions per 1003.9
• Reinforcements for grab bars required for future installation complying with 604.5 for the toilet, 607.4 for the bathtub, 608.3 for the shower seat, 608.2.1.3, 608.2.2.3, and 608.2.3.2 for the shower per 1003.11.1
             • Exception 4: for toilet clear floor space overlapping with the sink, the reinforcement for toilet's rear grab bar shall be for 24" centered on the toilet.
        Door shall not swing into the clear floor space for any fixture unless there is a clear floor space provided within the room beyond the arc of the door swing per 1003.11.2.1
                • Cabinetry under the sink is permitted IFF: 1) Cabinetry is removable, 2) floor finish extends under the cabinetry, 3) the walls behind and surrounding the cabinetry are finished per 1003.11.2.2

    Bottom edge of the mirror shall be at most 40" above the floor.
    Toilet located per 1003.11.2.4

             • Bathtub without permanent seat requires 30" clearance along the full length, grab bars, removeable seat is not required per 1003.2.5.1

    Standard Roll-in Shower requires 30" clearance along the full length except for sink with removeable cabinetry per 1003.2.5.2
    Kitchen aisle clearance 40" off face of counter/refrigerator/other appliances per 1003.12.2
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• Kitchen counter shall be 34" in height for 30" wide work surface for forward approach per 1003.12.3
         Parallel or forward approach shall be provided for each kitchen appliance per 1003.12.5 incld stove, oven, refrigerator.

    Clear floor space required for storage facilities except in the kitchen per 1003.14

  Type B Accessible Dwelling Units:
         · Accessible route shall connect all elements of the unit

Maneuvering clearance for the Entry door per 1004.5.2

31.75" clear opening width for all other doorways for user passage.

Operable parts must comply with 309.2 (clear floor space) 309.3 (height) with exceptions per 1004.9
        • Reinforcements for grab bars required for future installation complying with 604.5 for the bathtub, 608.3 for the shower seat, 608.2.1.3, 608.2.2.3, and 608.2.3.2 for the shower per 1003.11.1

• Exception 4: the reinforcement for toilet's side grab bar may be for 24" (12" off rear wall) instead of 42" if wall space is not available.

• Door shall not swing into the clear floor space for any fixture unless there is a clear floor space provided within the room beyond the arc of the door swing per 1003.11.2.1

saturroom: Option A & B
Sink shall provide side approach centered, or same as Type A, per 1004.11.3.1.1
Sink can be within toilet clear floor space per 1004.11.3.1.2

             • Sink should be 34" height per Option B per 1004.11.3.2.1

    Bathtubs can be same as Type A
    Showers can be same as Type A per commentary

         Kitchen aisle clearance 40" off face of counter/refrigerator/other appliances per 1003.12.2
         Kitchen sink, stove, oven, refrigerator, can be for parallel approach per 1004.12.2
 Accessibility per PHFA TAB Section 1.02:
     A minimum of 5% of the total dwelling units (or at least one unit) must be accessible by persons with mobility impairments. These units must include audible and visual signaling devices for the hearing/vision impaired.
• An additional 2% (or at least one unit) must be accessibly by persons with hearing or vision impairment.
• Building and Site Facilities provided for the use of tenants must be accessible to persons with disabilities. Parking spaces must be provided for mobility impaired tenants and visitors. The parking spaces must be designed in accordance with the Uniform Federal Accessibility Standards, Ansi A117.1-2009 and ADA. A minimum of 5% of the parking spaces (no less than two spaces) must be designed for persons in wheelchairs. If parking
  spaces are provided for each unit, accessible spaces must be provided for each accessible unit.
  • A full width kick plate must be provided on both sides of all exteriors entrance doors, all unit entrance doors, and all common area doors that permit tenant access

    Wall corner guards (textured vinyl 1-1/2" x 1-1/2" minimum) must be provided at all outside wall corners in all common areas.

    All accessibly units shall conform to the requirements for ICC/Ansi A117.1-2009 "Type A Units", with the following provisions:
    A full width kick plate must be provided on both sides of all interior doors that permit passage and on one side of all other doors

    Wall corner guards (textured vinyl 1-1/2" x 1-1/2" minimum) must be provided at all outside corners within accessible units.

    Grab bars must be installed at all required locations.

     • Orato bars must be instanted at an required tocations.

• A minimum of 50% of the accessible units shall include a bathroom with an accessible shower. (Not applicable to dwelling units in General Occupancy Developments with only one bathing fixture.) All accessibly showers shall have a maximum curb height of 1/2". The remaining accessible units may have an accessible bathtub/shower. A removeable seat, as shown in Ansi figure 610.2, shall be provided in all accessible
         • All bathrooms with 1/2" curbed showers shall have a floor drain provided in the bathroom floor outside of the shower.
• Accessible showers must be provided with a folding seat firmly secured to the shower walls, shower controls and a hand held shower head within reach of the seat and a compressible dam at the shower threshold.
        • Shower heads and mirrors in accessible units shall be mounted to permit use by those with mobility impairments and those without.
         Accessible pantry and linen cabinets or closets must be provided in accessible units.

Removable kitchen and bathroom base cabinets may be installed at the areas requiring knee space. These cabinets must be removable without disconnection of any plumbing lines. The walls, floor, and sides of adjacent
        cabinets must be finished and wall base installed during the initial construction.

Protection on drain and water piping beneath kitchen sinks and bathroom lavatories must be installed, even if removable cabinets are installed at these locations.
Refrigerators should be located to allow doors to open 180 degrees.
A 30" wide work surface with knee space (or removable cabinets) beneath must be provided beside the oven in all accessible kitchens.

The range must be a self-cleaning type in all dwelling units.

Accessible bedrooms must have a minimum 30" access aisle on both sides and at the foot of the bed. The primary bedroom must accommodate a queen size bed. All other bedrooms must accommodate a twin size bed.

At the exterior entrance to an accessible, adaptable or Visitable unit, an overhang or porch roof is required to protect the entrance door from rain and snow.
 • A minimum of (1) accessible parking space must be provided for visitors.
• Development should be designed implementing "VisitAbility" access methods to the greatest extent possible
  VisitAbility Requirements per PHFA TAB Section 1.08:
    The building must have at least one Zero-Step Entrance with a 36" wide door. A zero-step entrance is one with no step at the exterior door and with an than a 1/2" difference between the inside and outside surfaces or with a
    All doors, doorways and passage ways on the accessible entry level floor of a unit must be 36" wide minimum.
 • A 36" clear path of travel to the to bathroom and a clear floor place within the room and at the plumbing fixtures per the Fair Housing Act Design Manual is required. A parallel or front approach (with knee and toe clearance) is required at the vanity. If a front approach is provided, additional storage in the form of a cabinet or closet is required.
• A 24" grab bar shall be provided beside the toilet. Walls behind grab bars must have reinforcement (3/4" plywood or osb over studs (preferred) or at least 2" x 8" blocking between studs). Blocking should be centered at
 34" above the floor. Grab bars must be rated to hold at least 250 lbs.. of static weight, stand way from the wall 1 1/2" and be 1 1/4" to 1 1/2" diameter.

• Hallways must be 36" minimum, 42" preferred. A clear pathway to the living and dining areas is required.

• All newly constructed single family houses, townhouses, units in elevator buildings and all ground floor units in walk-up apartment buildings shall be Visitable. To meet VisitAbility design features: the building and units
must have at least one Zero-Step Entrance with a 36" wide door; all doorways and passages on the entry level floor must have a width of 36"; there must be a clear pathway to a bathroom or power room; such bathroom or powder room must include a minimum 24" grab bar beside the toilet on a reinforced wall, which can also serve as a towel bar; and there must be a clear pathway to the living room and dining area of the unit. The powder room and bathroom must meet the Fair Housing Act maneuverability clearances.
Elevator Policy per PHFA TAB Section 1.05:

General Occupancy Developments of 4 stories in height are required to have at least 1 elevator.
For developments with more than one elevator, it is recommended that one elevator be connected to an auxiliary generator.
  Minimum Insulation Standards per PHFA TAB Section 1.06:
 • New construction developments over 3 stories in height shall exceed the requirements of the IECC Chapter 4 Commercial Energy Efficiency by 7% as verified by the submission of a COMcheck certificate.

• All piping and heating/cooling ductwork must be located within the conditioned space. No ductwork will be allowed on the roof or on the exterior of the building.
  • All roof trusses with insulation located along the bottom chord of the truss shall be "energy" or "raised hee!" trusses.
• Interior wall insulation at below grade walls shall be foil-faced rigid insulation board rated for an exposed installation (in storage or mechanical rooms) or rigid foam insulation board covered with a code compliant approved
  material (in all finished areas). All joints shall be air sealed. Fiberglass or cellulose insulation will not be allowed.
  • The foundation insulation (minimum of 1") at all slab-on-grade construction shall begin at the top of the slab and extend the code required depth below grade. The top of insulation may be beveled at a 45° angle per the
     New Construction Developments: All appliances, HVAC equipment with a capacity less than 60,000 btuh, gas fired water heaters, windows, ceiling fans, exhaust fans, range hoods and exit signs shall be EnergyStar labeled.
  • Exception: Programmable thermostats do not need to be provided and windows in buildings over 3 stories in height may comply instead with ASHRAE Standard 189.1-2009. PTACs and PHTCs may only be used if it can be proved that they comply with the prescriptive requirements of Energy Star Version 3.1 for air source equipment.
• 100% of the permanent room light fixtures in the dwelling units shall be equipped with LED bulbs or high efficiency fluorescent lamps with electronic ballasts; and 100% of the community room and common area corridor
  and stair lighting shall be high efficiency fluorescent with electronic ballasts or shall utilize LED bulbs.
 and star infinite start regimes start of the electronic barrasts of shall utilize LED outside the valid evelopments utilizing central system refrigerant flow type equipment shall meet or exceed Energy Star criteria specification for light commercial HVAC or have the Energy Star Label.

New construction developments over 3 stories in height shall exceed the requirements of the IECC by 7% as verified by the submission of a COMcheck certificate. Air sealing of the exterior building envelope and attice.
plane shall be included.
    All newly constructed multifamily buildings shall comply with the requirements of the 2020 Enterprise Green Communities program criteria 5.1a.

No piping shall be located outside of the interior finish of the insulated building envelope.
All domestic water pipes except for PEX piping shall be insulation.
Termite shields or borate-based wood treatment shall be provided with low VOC caulking at all floor joints and penetrations to prevent insect infestation. Borate treatment shall be applied to all wood framing and sheathing
 to a height of 24" above the "at grade" floor level. Chemical soil treatment or bait stations shall not be used.
 New Construction in Flood-Prone Areas Per PHFA TAB Section 1.15:
    New construction buildings may not be located within a floodway, 100-year floodplain, or a coastal high hazard area. Sites will also be studied to determine if they would become inaccessible from dry land during flood
  • The lowest floor must be at least 1'-6" above the elevation of the 100-year flood at the site location.
     New construction must include radion resistant construction techniques. This includes the installation of a "passive" sub-slab depressurization system, vented through the roof.
  • Exhaust fans need not be installed prior to occupancy. When the building is complete, radon tests must be made in every ground floor apartment, community space, and commercial space to determine the need for exhaust
     ans. These tests must be made after construction completion and prior to occupancy. Any dwelling units or common areas with test results above the Action level of 4pCi/L must install exhaust fans on the radon venting
 Environmental Site Assessment Guidelines per PHFA TAB Section 1.24:
 Development Security Maintenance Requirements for Urban Locations per PHFA TAB Section 2.05:

• All developments with shared entrances must be equipped with an apartment intercom system or equivalent security system at the main entrance(s) used by tenants on a regular basis.
  · All dwelling unit entrance floors must be equipped with a passage latch set, dead bolt lot set, knocker, viewer and an apartment/unit identification num

    Avoid blind corner and courtyards unless they can be secured.
    Place all meters do that they are protected from vandalism and can be read from outside the building.
  · Provide "Door Ajar" alarms or, where approved by code, electromagnetic release devices for secondary or fire exit doors.

    Where practical, provide decorative code approved security grilles or screens for basement and first floor windows with sills than 60" above exterior finished grade.
    Avoid through wall penetrations (e.g. exhaust grills), unless small enough to prevent entry and placed a minimum of 60" above exterior finished grade.
    The first 8' above grade should be masonry or equivalent strength material with "Anit-Graffiti" coating.
Mechanical Requirements per PHFA TAB Section 2.06:

• All tubs and showers must have an anti-scald valve. Baths with accessible showers must include a drain in the bathroom floor in addition to the shower. Single piece tub/shower units must not be installed directly to stude a drain in the bathroom floor in addition to the shower.
 on exterior walls but must be installed over tapped gypsum wallboard to eliminate air infiltrati
    Plumbing fixtures in dwelling units and common areas shall meet the following usage rates:
        • Urinals - 0.5 gpf
        · Showerheads - 2.0 gpm

    Kitchen faucets - 2.0 gpm
    Lavatory faucets - 1.5 gpm

  • Exposed refrigerant, power and control wiring from building to the remove condensing unit must be protected. Piping must be bundled and covered with PVC split insulation jacket and cemented joints
  • Kitchen exhaust must be provided with a combination fan and light range hood and must be controlled by a separate switch and be ducted to the exterior.
• In new construction the living areas and bedrooms of all dwelling units must be air conditioned. Window units will not be considered as meeting this criteria.

    In new construction all common areas must be air conditioned except for stair towers, mechanical and storage areas.

  • A minimum 5 year compressor and refrigeration circuit warranty is required on all developments for all refrigeration (mechanical cooling) units. This includes through-the-wall equipment, split systems and central systems.
• A one shot type, 2 quart minimum capacity chemical feeder must be installed on all developments utilizing central hot and/or chilled water piping systems.
    Clothes Dryers exhaust ductwork must be rigid duct with accessible cleanouts to vacuum clean entire duct system.
 • If provided, water coolers must be dual height type with standard and accessible height spouts.
• In accessible units insulate or otherwise protect the hot, cold and drain piping exposed below the kitchen sink and bathroom lavatories.
• All group R-2 buildings must be provided with an automatic fire suppression system throughout the building in accordance with PA UCC and IBC as applicable. All sprinkler/water rooms must be heated.
• All water piping and heating/cooling ductwork must be located within the conditioned space, (I.e. on dwelling unit side of the air barrier on the interior of the exterior wall and roof/ceiling assemblies).
  • All water heaters must have a drip pan connected through a trap to a waste line. Minimum capacity water heaters must be provided as follows:

    1 bedroom units - 30 gal.

All central hot water piping systems shall include a pumped return to prevent bio-hazard growth.

Domestic water plumbing systems using PEX or other cross-linked polyethylene piping shall be installed with manifolds in each individual dwelling unit. The manifolds shall be accessible by means of an access panel or door. All piping from the manifold block to each plumbing fixture shall be a single length of continuous polyethylene cross-linked pipe (not joints are allowed).

    Sealing for Air Conditioning: all duct joints and seams shall be sealed with mastic or similar product as listed in SMACNA Manual N.
    Hangers for Air Conditioning: duct hangers shall not include fasteners that penetrate the duct.
    In mechanical rooms or closets containing multiple pieces of equipment, it must be possible to service and replace each piece of equipment without removed any other equipment.

  · Electric Resistance Heat may not be used as the primary heat source

    All plumbing lines must be concealed except in mechanical rooms.
    Shut-off valves must be installed at the main water line(s) where they enter the unit and on each line at all plumbing fixtures, including the water heater.

Electrical Requirements per PHFA TAB Section 2.07:

Site lighting fixtures must be shatter resistant and tamperproof. Lamps must be high efficiency design, low energy type (e.g. high pressure sodium. Provide 0.5fc minimum).

Smoke detectors must be furnished and installed in the following areas:

In the areas adjacent to the sleeping area, one in each bedroom. Detectors must be 120 volt AC type with battery backup.
     • Hearing/vision impaired units must have strobe/horn type visual signaling devices wired to the units smoke detectors and the building fire alarm system (if provided) and must be visible in all rooms of the dwelling unit including the bathroom.

    In all public areas.

    In all non-sprinklered storage rooms and in all storage rooms in excess of 100 SF.
    All mechanical and electrical rooms must have a smoke or heat detector.

    At the top of each stair.

In the trash collecting room and at the top of the trash chute.
At the ends of each corridor leading into stair towers or dead ended. Corridor coverage shall comply with IBC or NFPA 72, the National Fire Alarm Code.
In accessible and adaptable units, tenant electrical panels shall be mounted with the top breaker within the accessible reach range.

  · Every building and every unit shall be pre-wired for telephone and TV cable service.
  • Electric Resistance Heart may not be used as the primary heat source.
• Broadband Infrastructure is required to be installed in compliance with Federal Register Citation 81 FR 31181 "Narrowing the Digital Divide through Installation of Broadband Infrastructure".
```

LIHTC Minimum Design Standards per PHFA TAB Section 4.02:

1 bedroom units shall be 550 to 850 SF with dining for 2 chairs.

2 bedroom units shall be 700 to 1,100 SF with dining for 4 chairs.

Primary bedroom shall be at least 120 SF with least dimension of 10'-0"

Each Unit shall have closets as follows:
 Closets shall extend no more than 12" on each side of the door opening.

Secondary bedroom shall be at least 90 SF with least dimension of 9'-0".
 Living Room shall be at least 150 SF with least dimension of 11'-0". Dining area shall be in addition to this for combination living/dining room.
 Ceiling height 7'-6" minimum. 7'-0" allowed in bathrooms, storage rooms, mechanical rooms, corridors and closets. 7'-0" allowed for 15% of other rooms for soffits.

205 Ross Street Primary bedroom shall have at least 5 linear feet x 24" minimum denth closet. Pittsburgh, Pennsylvania 15219 Misc. 3 SF (in 1 bedroom units) and 12 SF additional storage space (in 2 bedroom units). Pantry of either 2 linear feet x 18" minimum depth or 18" minimum width pantry cabinet.
 Linen storage of either 2 linear feet x 18" minimum depth or 18" minimum width linen cabinet. ph 412.281.6001 fx 412.281.6002 • Floor finishes shall be sheet vinyl or ceramic tile. LVT is permitted if manufacturer's documentation, indicating product is permitted if bathrooms, is provided.
• Vanity bases must be provided unless an additional storage cabinet or closet is provided. Removable fronts are recommended in adaptable units. • Provide (2) 24" towel bars, toilet paper holder, shower rod, medicine cabinet with mirror and a light fixture located over the mirror. • Provide solid blocking behind wall mounted accessories. Blocking installed for future grab bars shall be continuous. Blocked for small grab bars for Visitability or Fair Housing Act conformance shall be sized to accommodate the grab bars required by ANSI 117.1-2009. • For central laundry facilities at least (1) washer and (1) dryer shall be provided for every 12 units in general occupancy. This includes at least (1) front loading washer and dryer.

Coat closet of 2 linear feet x 24" minimum depth.

Interior finish: A level 4 minimum drywall finish must be installed.

• IIC 50 and STC 50 for floor/ceiling assemblies, and STC 50 for partitions, separating living units from other living units and public spaces with moderate noise levels.
• IIC 55 and STC 55 for floor ceiling assemblies, and STC 55 for partitions, separating living units from high noise areas (e.g. mechanical and trash compactor rooms, elevator and trash chases, laundry and maintenance

Full width kick plate must be provided on both sides of all exterior entrance doors, accessible unit entrance doors, and all common area doors that permit tenant access.

nent Communities: New construction: USPS approved 4C centralized mailbox equipment. 1 parcel locker for every 10 mailbox compartments min.

• Wall corner guards (textured vinyl 1 1/2" x 1 1/2" minimum) must be provided at all outside wall corners in all common areas.

Each Unit shall have 1 bathroom as follows:

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revisions

project title

Owner:

HACP 200 Ross Street

Pittsburgh,PA,15219

Client:

Allies & Ross Management and Development Corporation (ARMDC) 200 Ross Street Pittsburgh, PA 15219

Project Location:


Northview Heights Midrise 246 Penfort Street Pittsburgh, PA 15214

drawing title

CODE CONFORMANCE INFORMATION

As Noted December 3rd, 2023

Project #2040

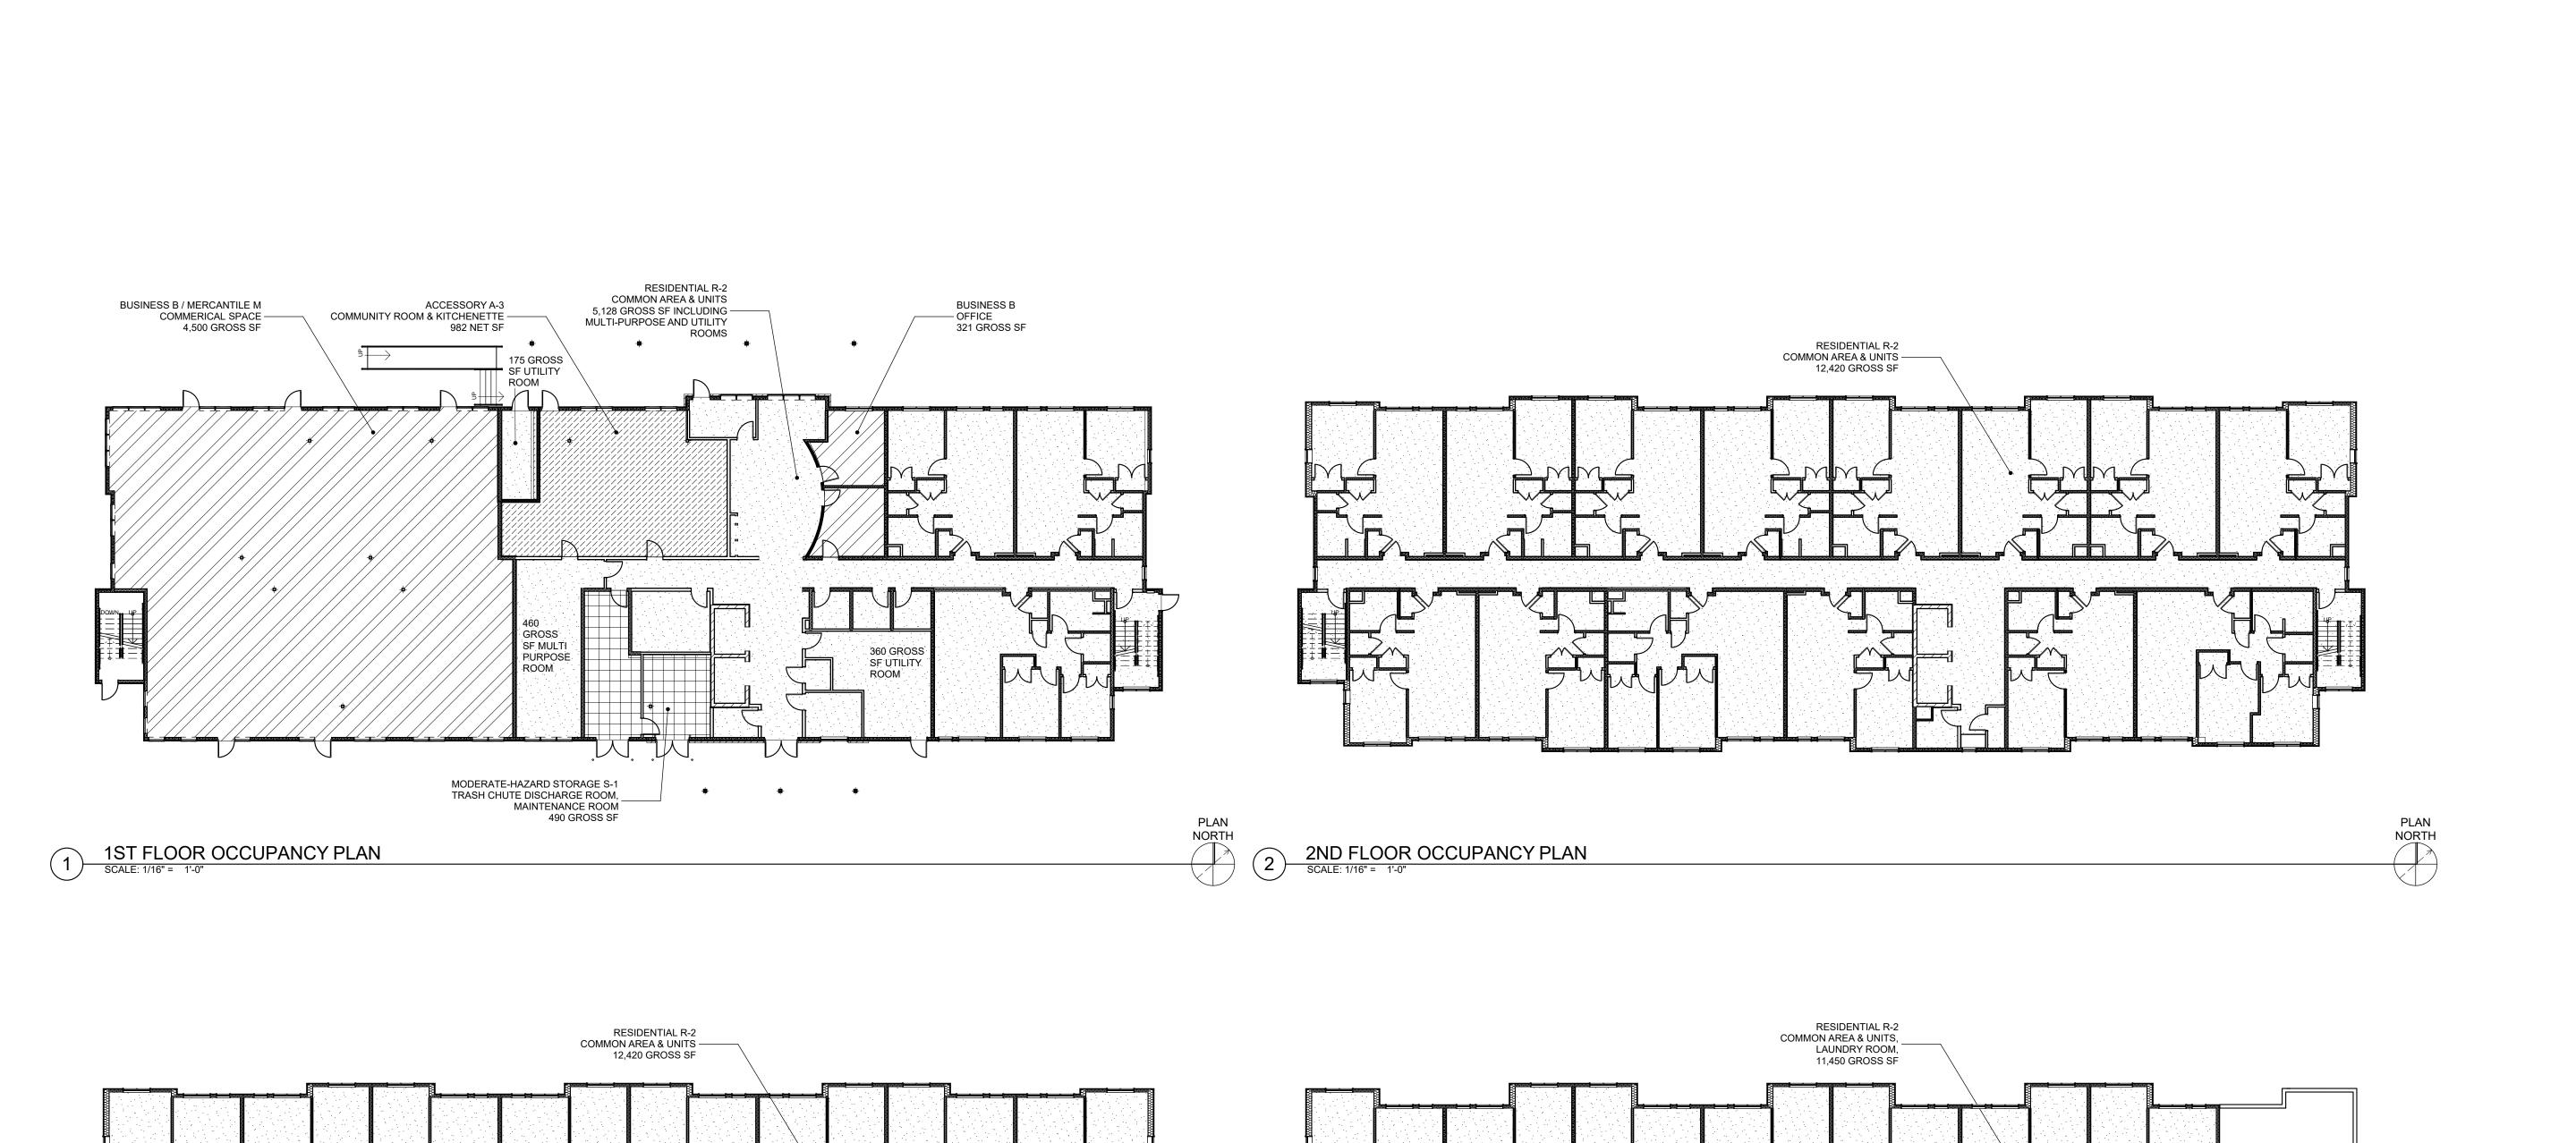

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revision

project title

1er•

Owner:

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Client:

Allies & Ross Management and Development Corporation (ARMDC) 200 Ross Street Pittsburgh, PA 15219

Project Location:

Northview Heights Midrise 246 Penfort Street Pittsburgh, PA 15214

drawing title

OCCUPANCY PLANS

As Noted

date

December 3rd, 2023

PLAN NORTH **TS04**


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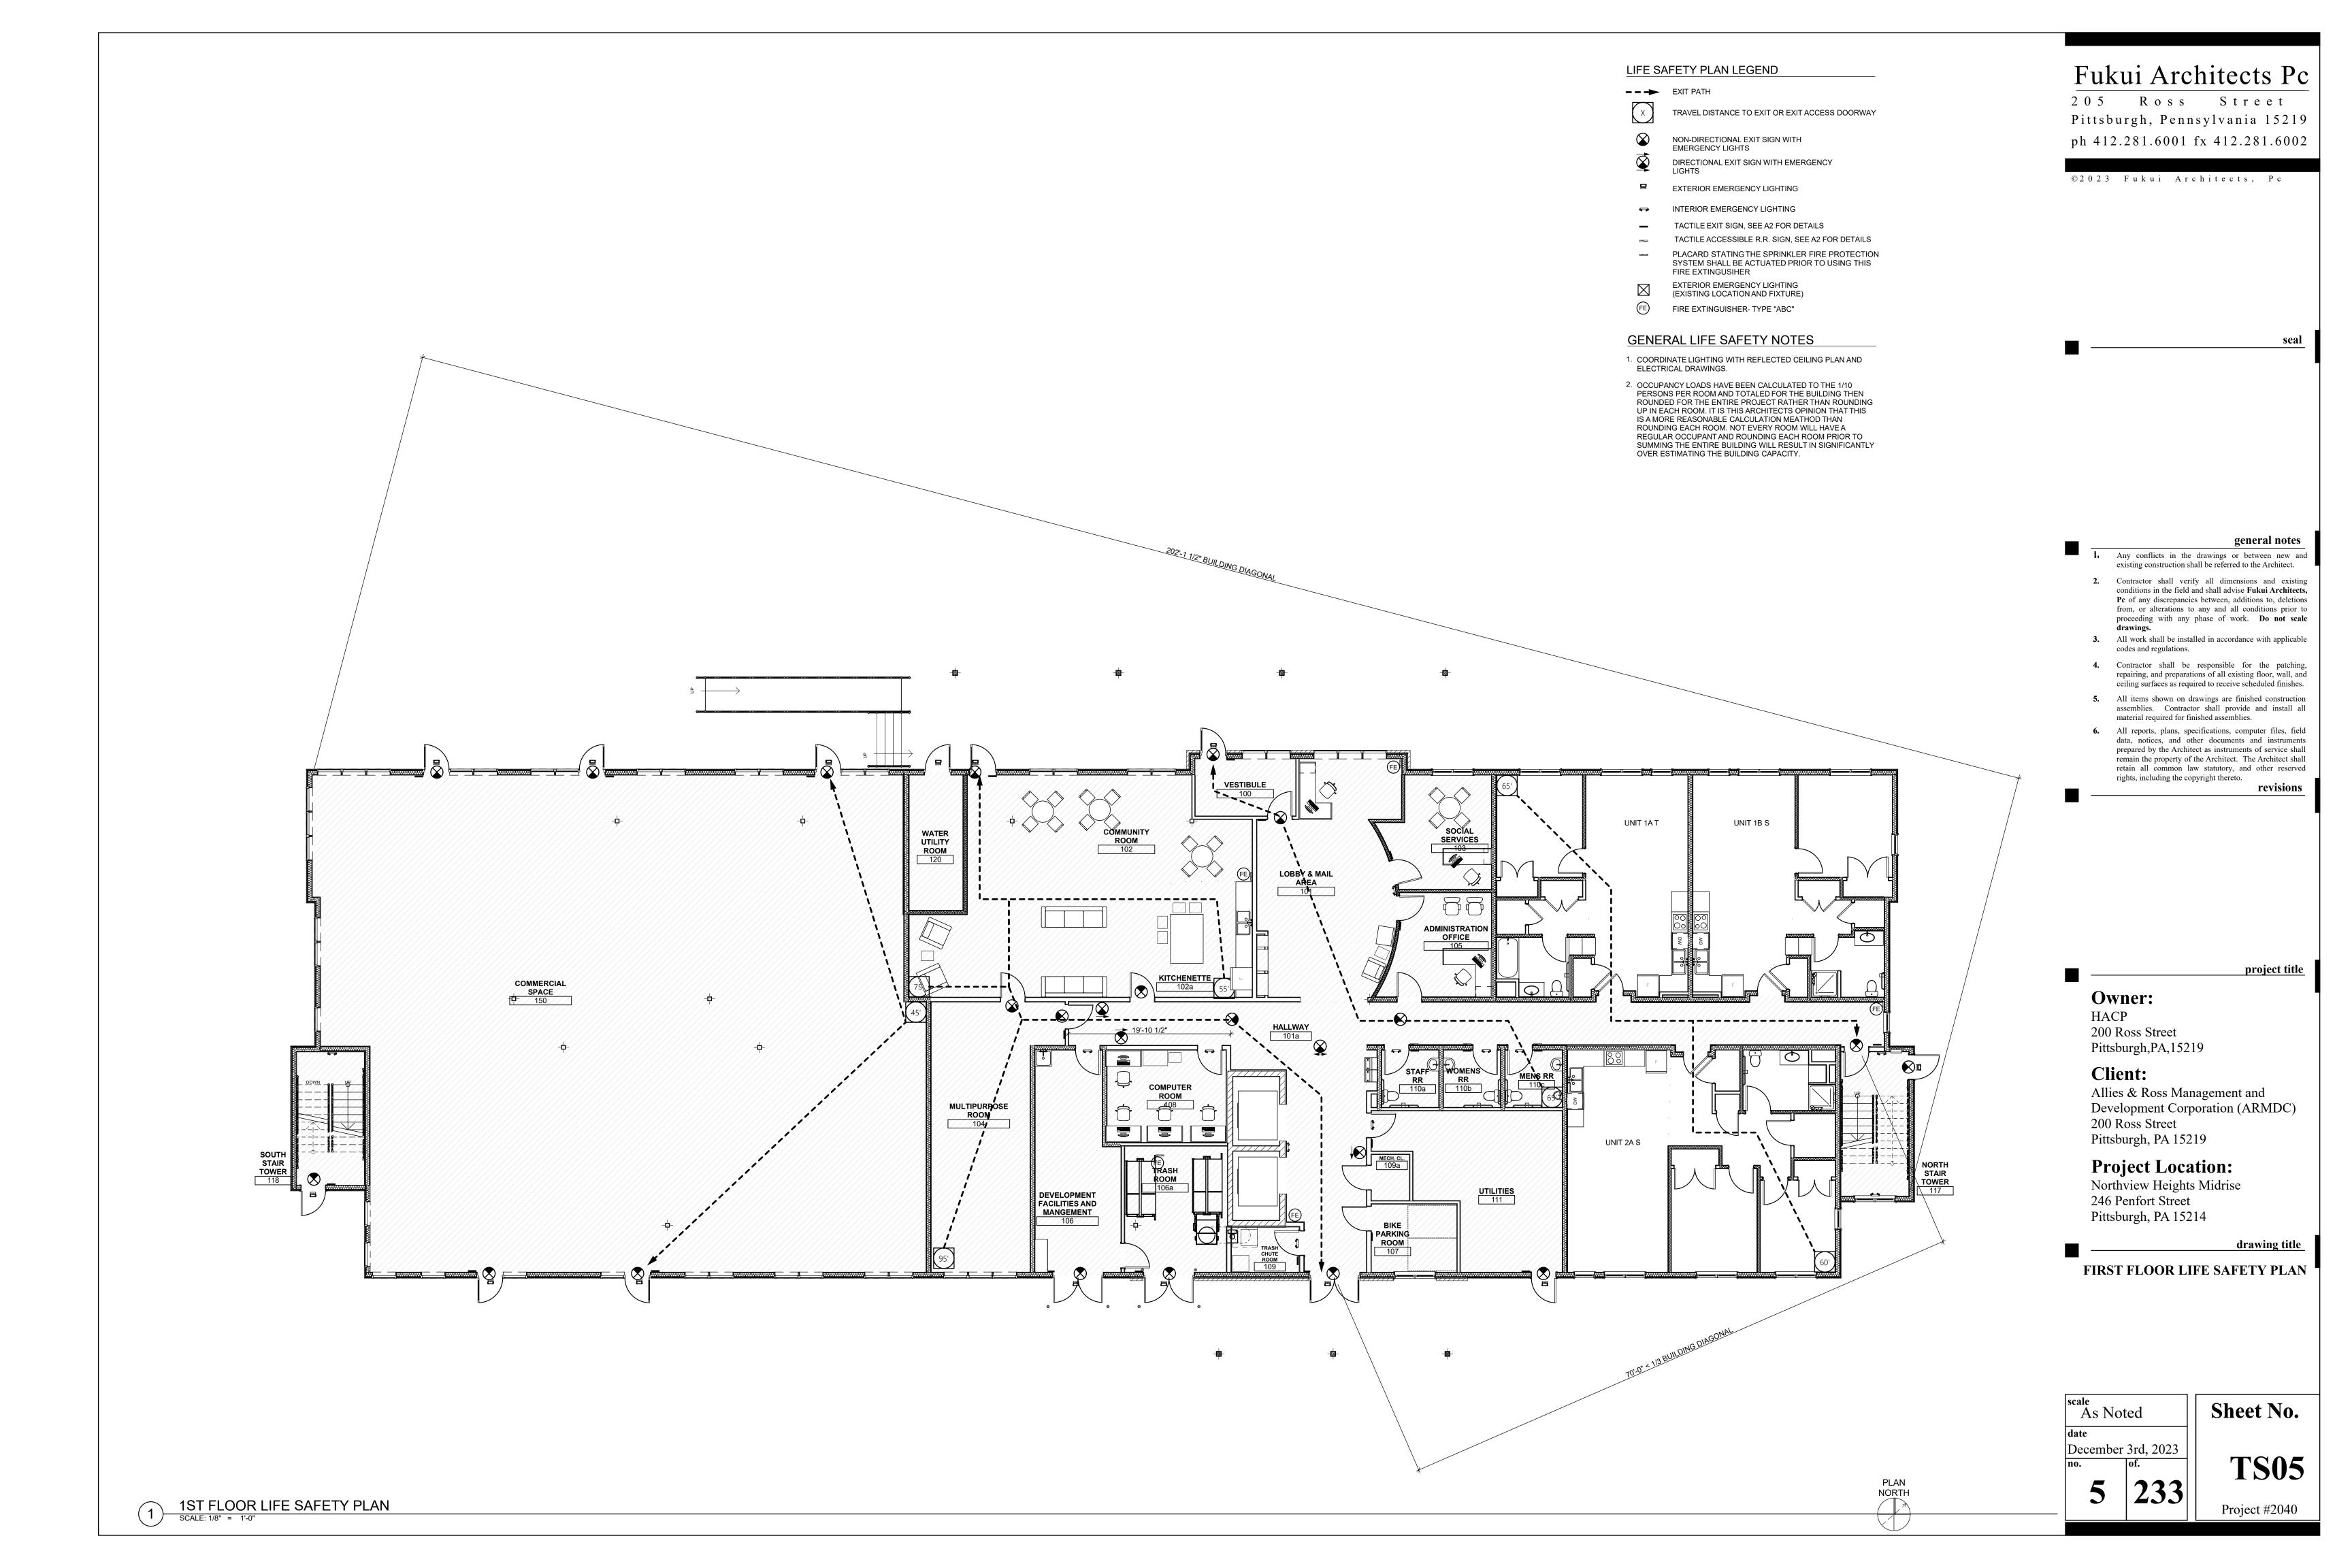
Project #2040


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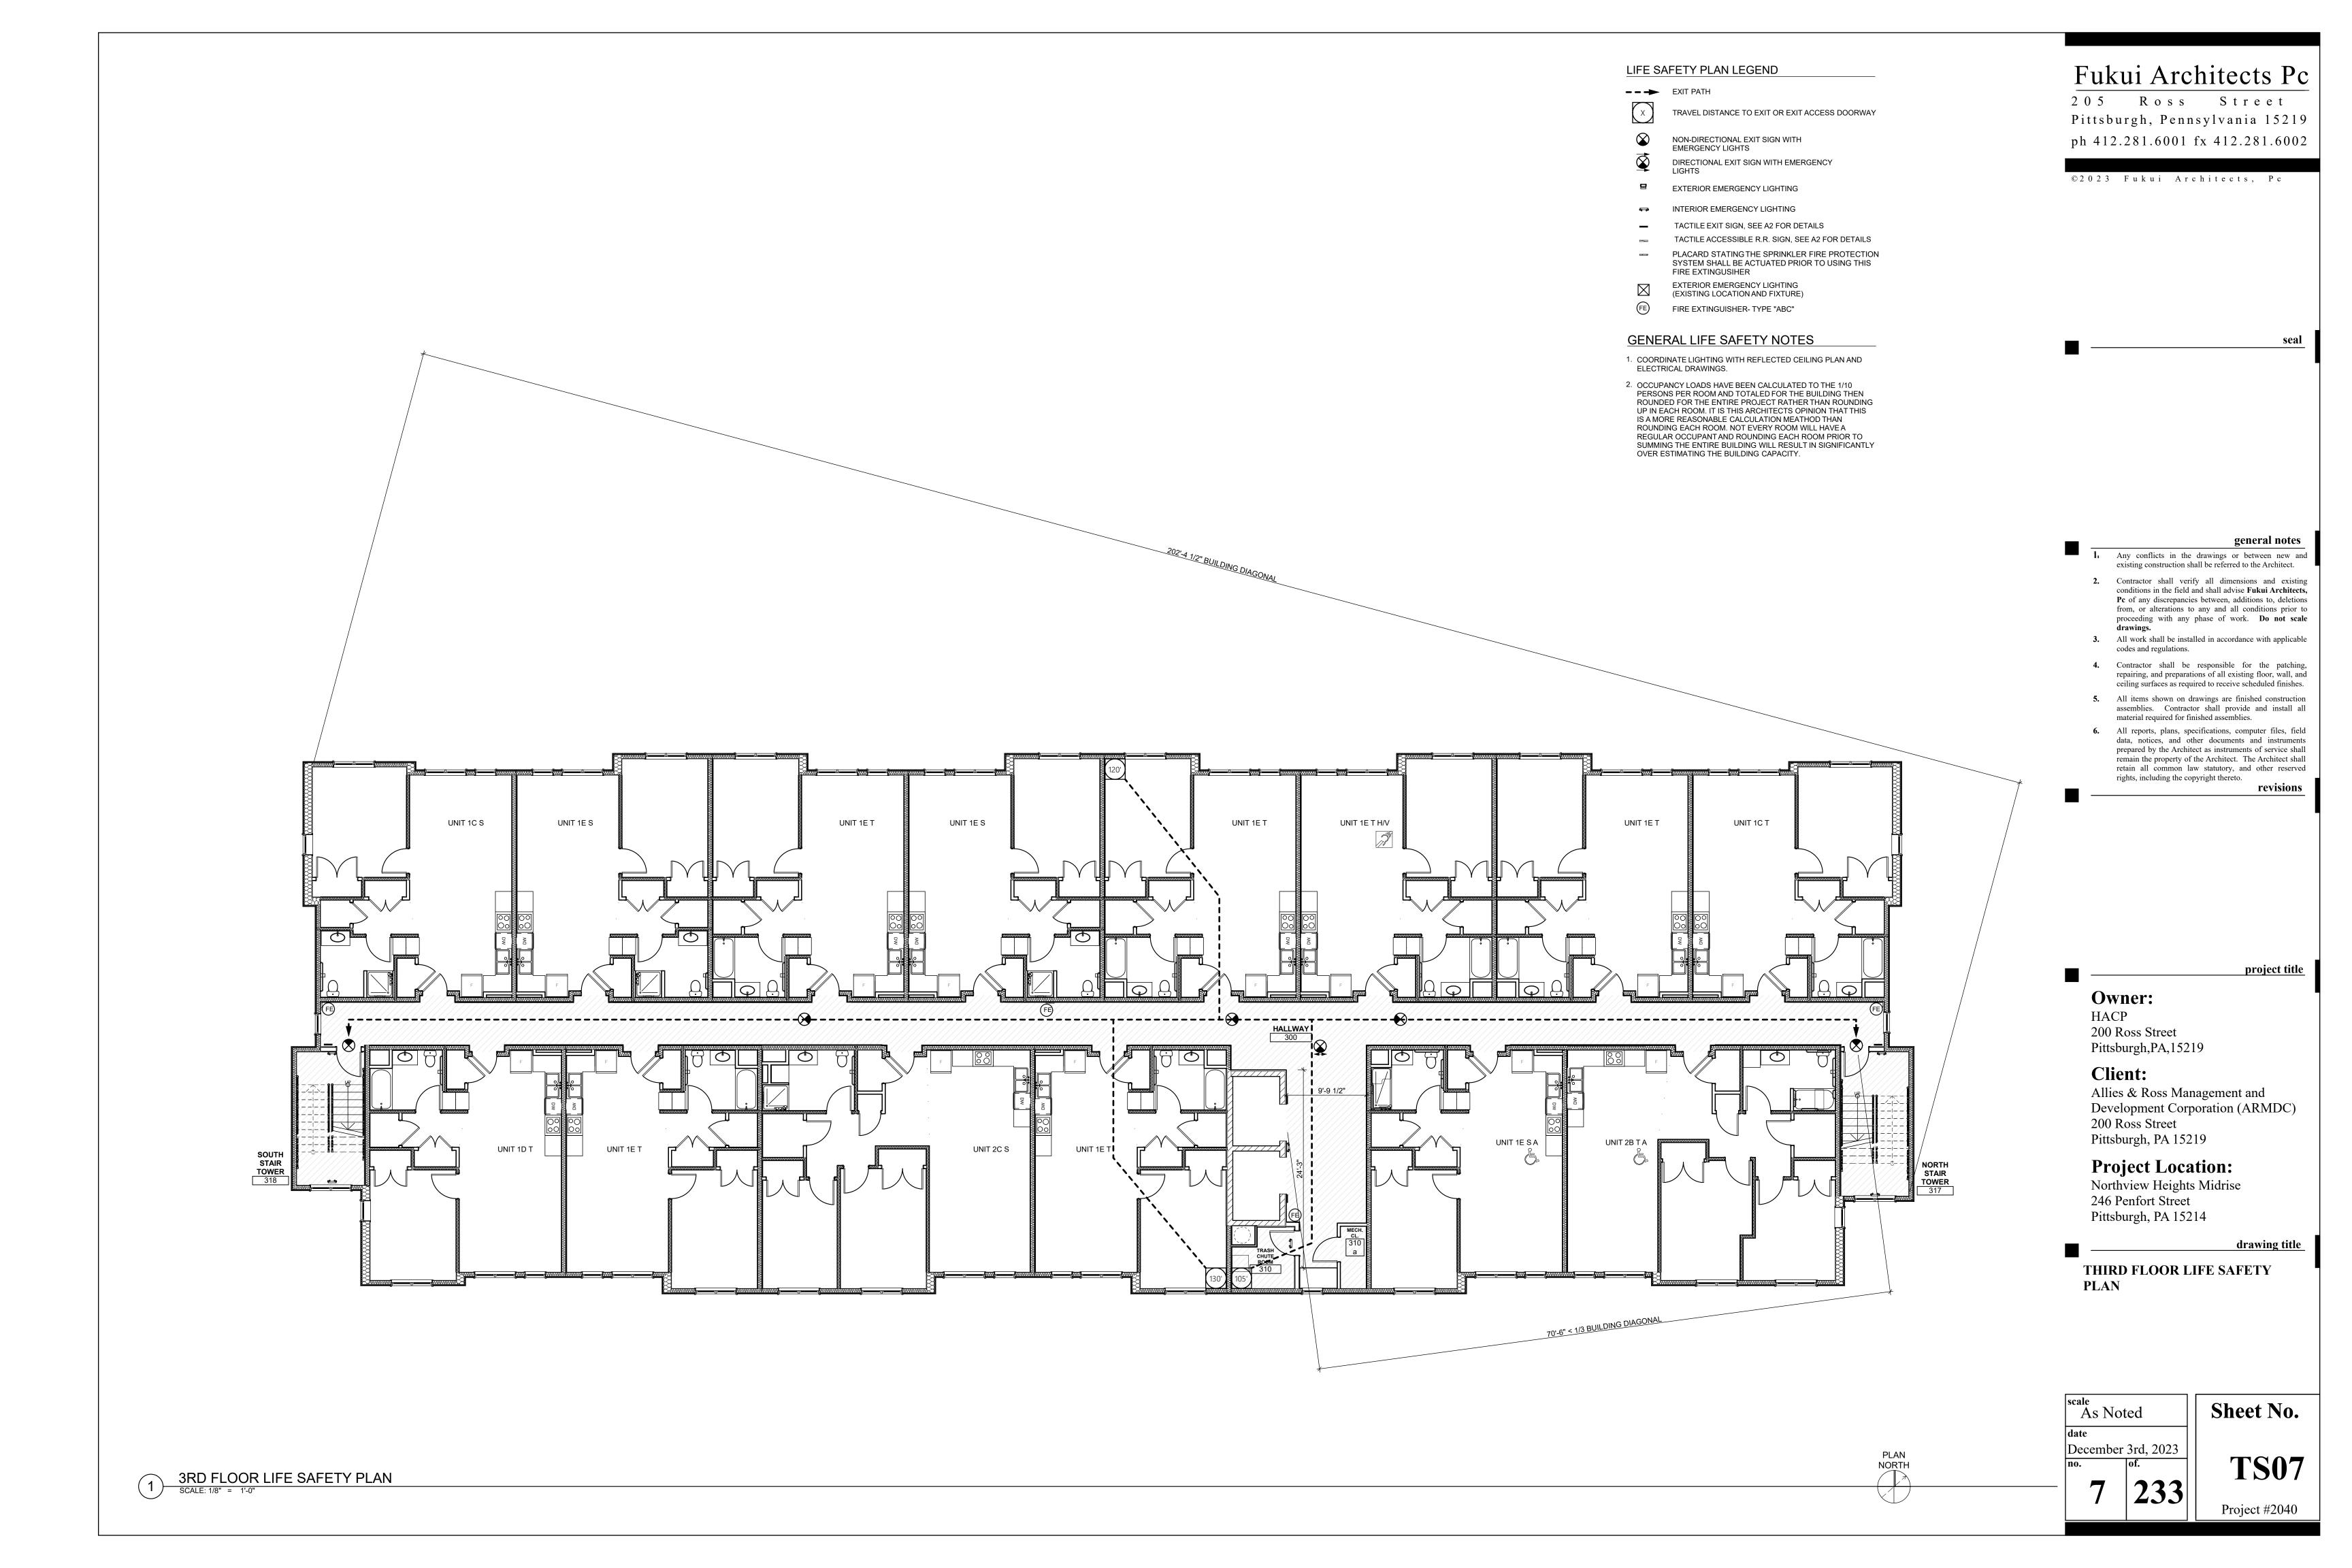
3RD FLOOR OCCUPANCY PLAN


SCALE: 1/16" = 1'-0"





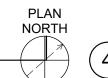

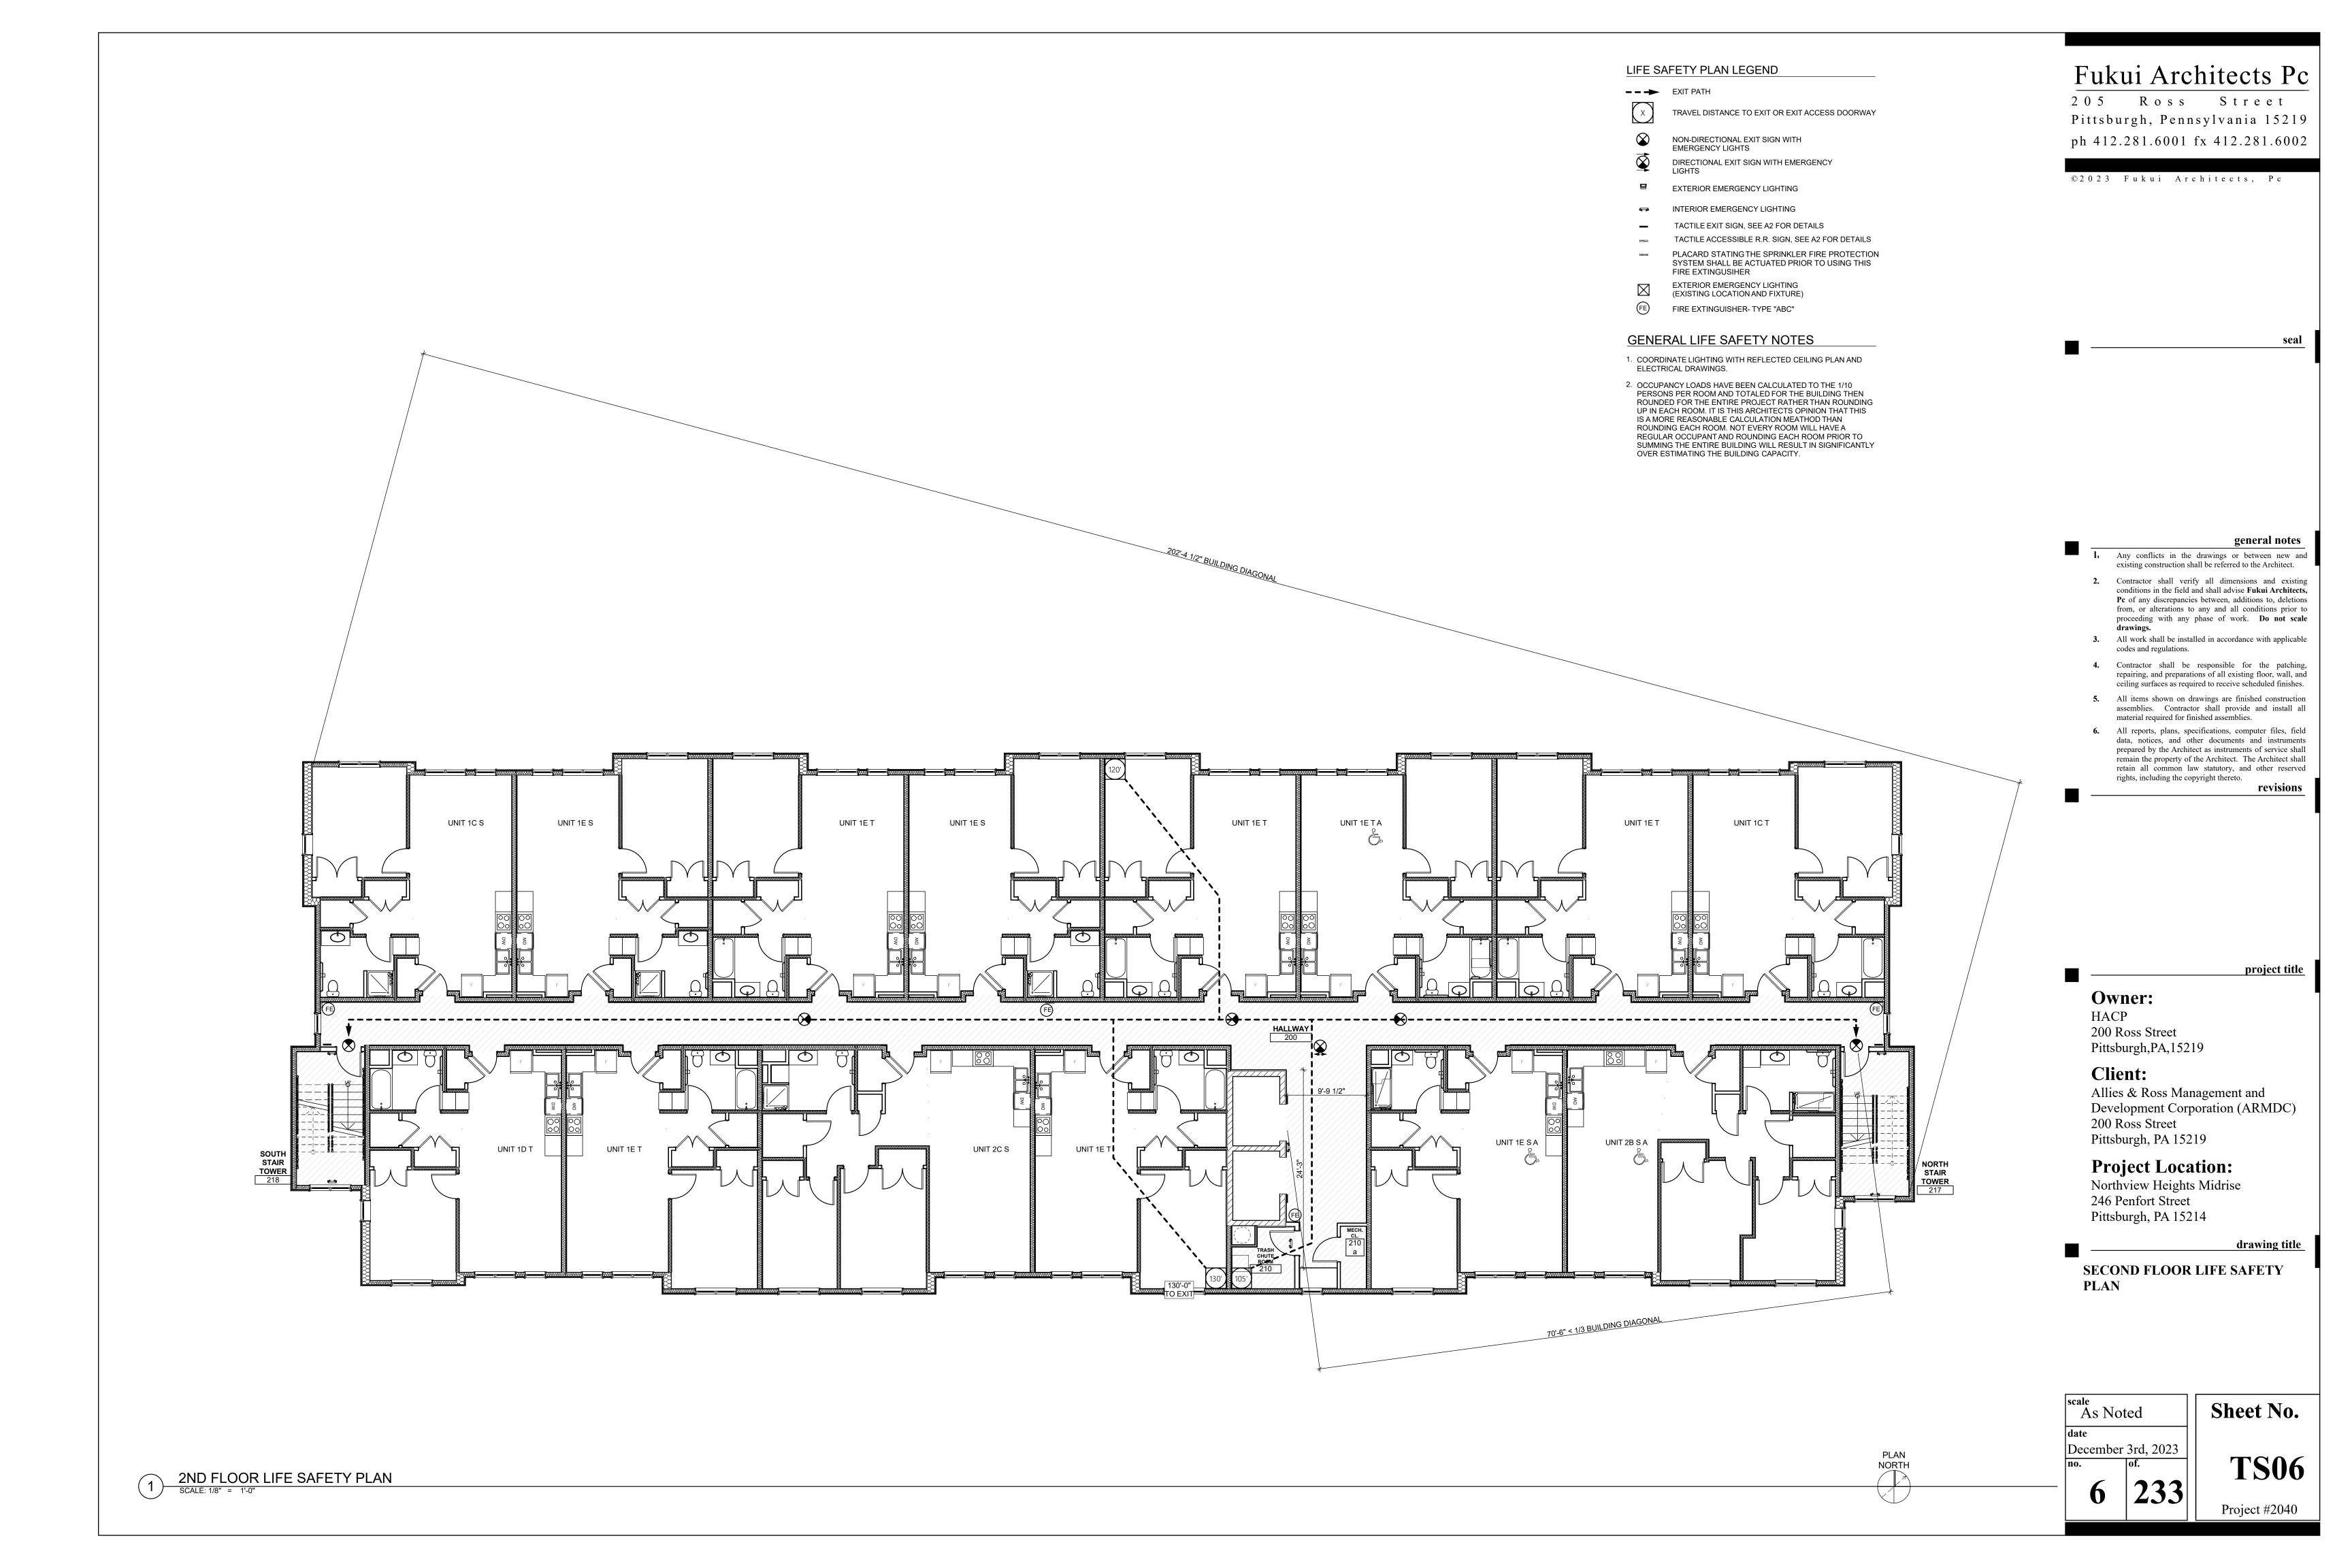

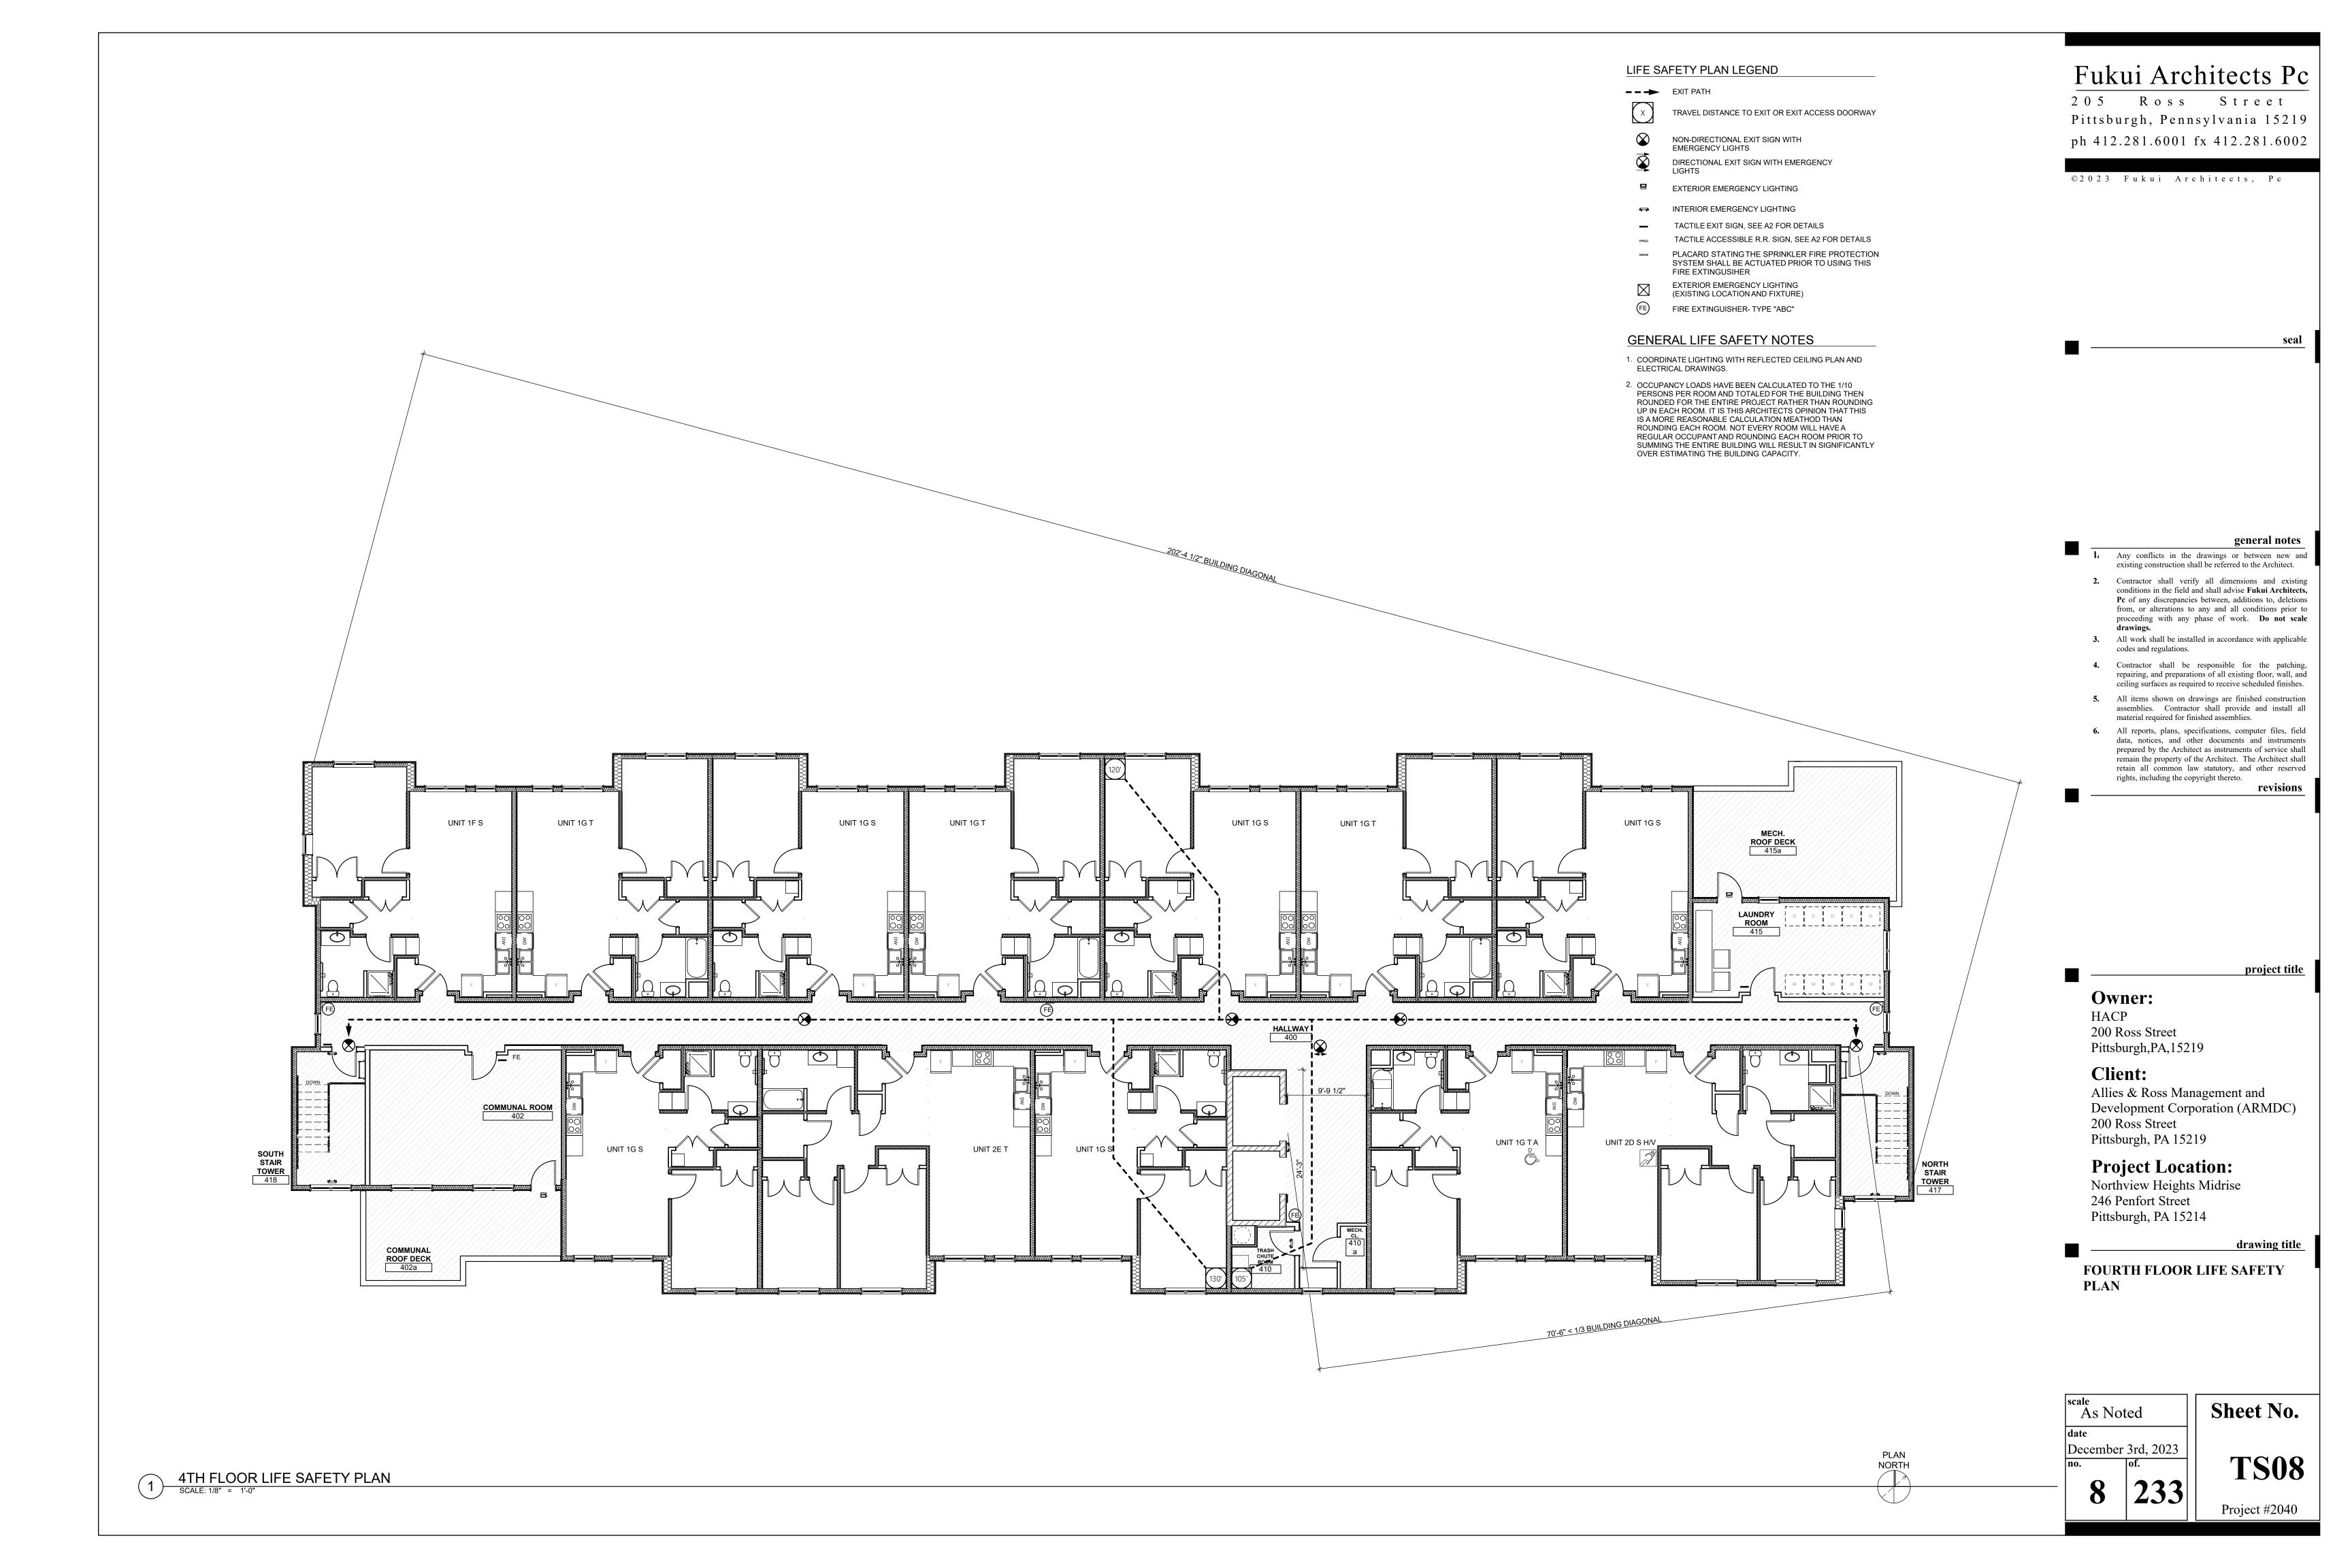

- DOOR WIDTH X 48"
- DOOR WIDTH+18" LATCH SIDE X 60"
- DOOR WIDTH+24" LATCH SIDE X 48"
- 60" X 66" (TYPE A W.C. W/ LAV. OVERLAP EXCEPTION)
- 30" X 48" CLEAR FLOOR SPACE
- 30" X FULL LENGTH OF BATHTUB (60" MIM) BATHTUB CLEARANCE
- 60" X 56" (W.C.)
- 60" DIA. TURNING SPACE
- DOOR WIDTH+12" LATCH SIDE X 48"
- DOOR WIDTH+24" LATCH SIDE X 54"
- 36" X 48" SHOWER CLEARANCE 60" X 60" T-SHAPED TURNING SPACE
- 36" X FULL LENGTH OF ROLL-IN SHOWER
- 36" WIDE UN-OBSTRUCTED PATH OF EGRESS
- 30" CLEARANCE (AROUND BED)

REFRIGERATOR AND PANTRY/LINEN CABINET DOOR SWING

PLAN NORTH

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205 Ross Street Pittsburgh, Pennsylvania 15219

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5. All items shown on drawings are finished construction

- assemblies. Contractor shall provide and install all material required for finished assemblies. 6. All reports, plans, specifications, computer files, field
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revisions

project title

Owner: HACP

200 Ross Street Pittsburgh,PA,15219

Client:

Allies & Ross Management and Development Corporation (ARMDC) 200 Ross Street Pittsburgh, PA 15219

Project Location:

Northview Heights Midrise 246 Penfort Street Pittsburgh, PA 15214


drawing title

FIRST FLOOR ACCESSIBILITY **PLAN**

scale As Noted December 3rd, 2023

TS09

Sheet No.

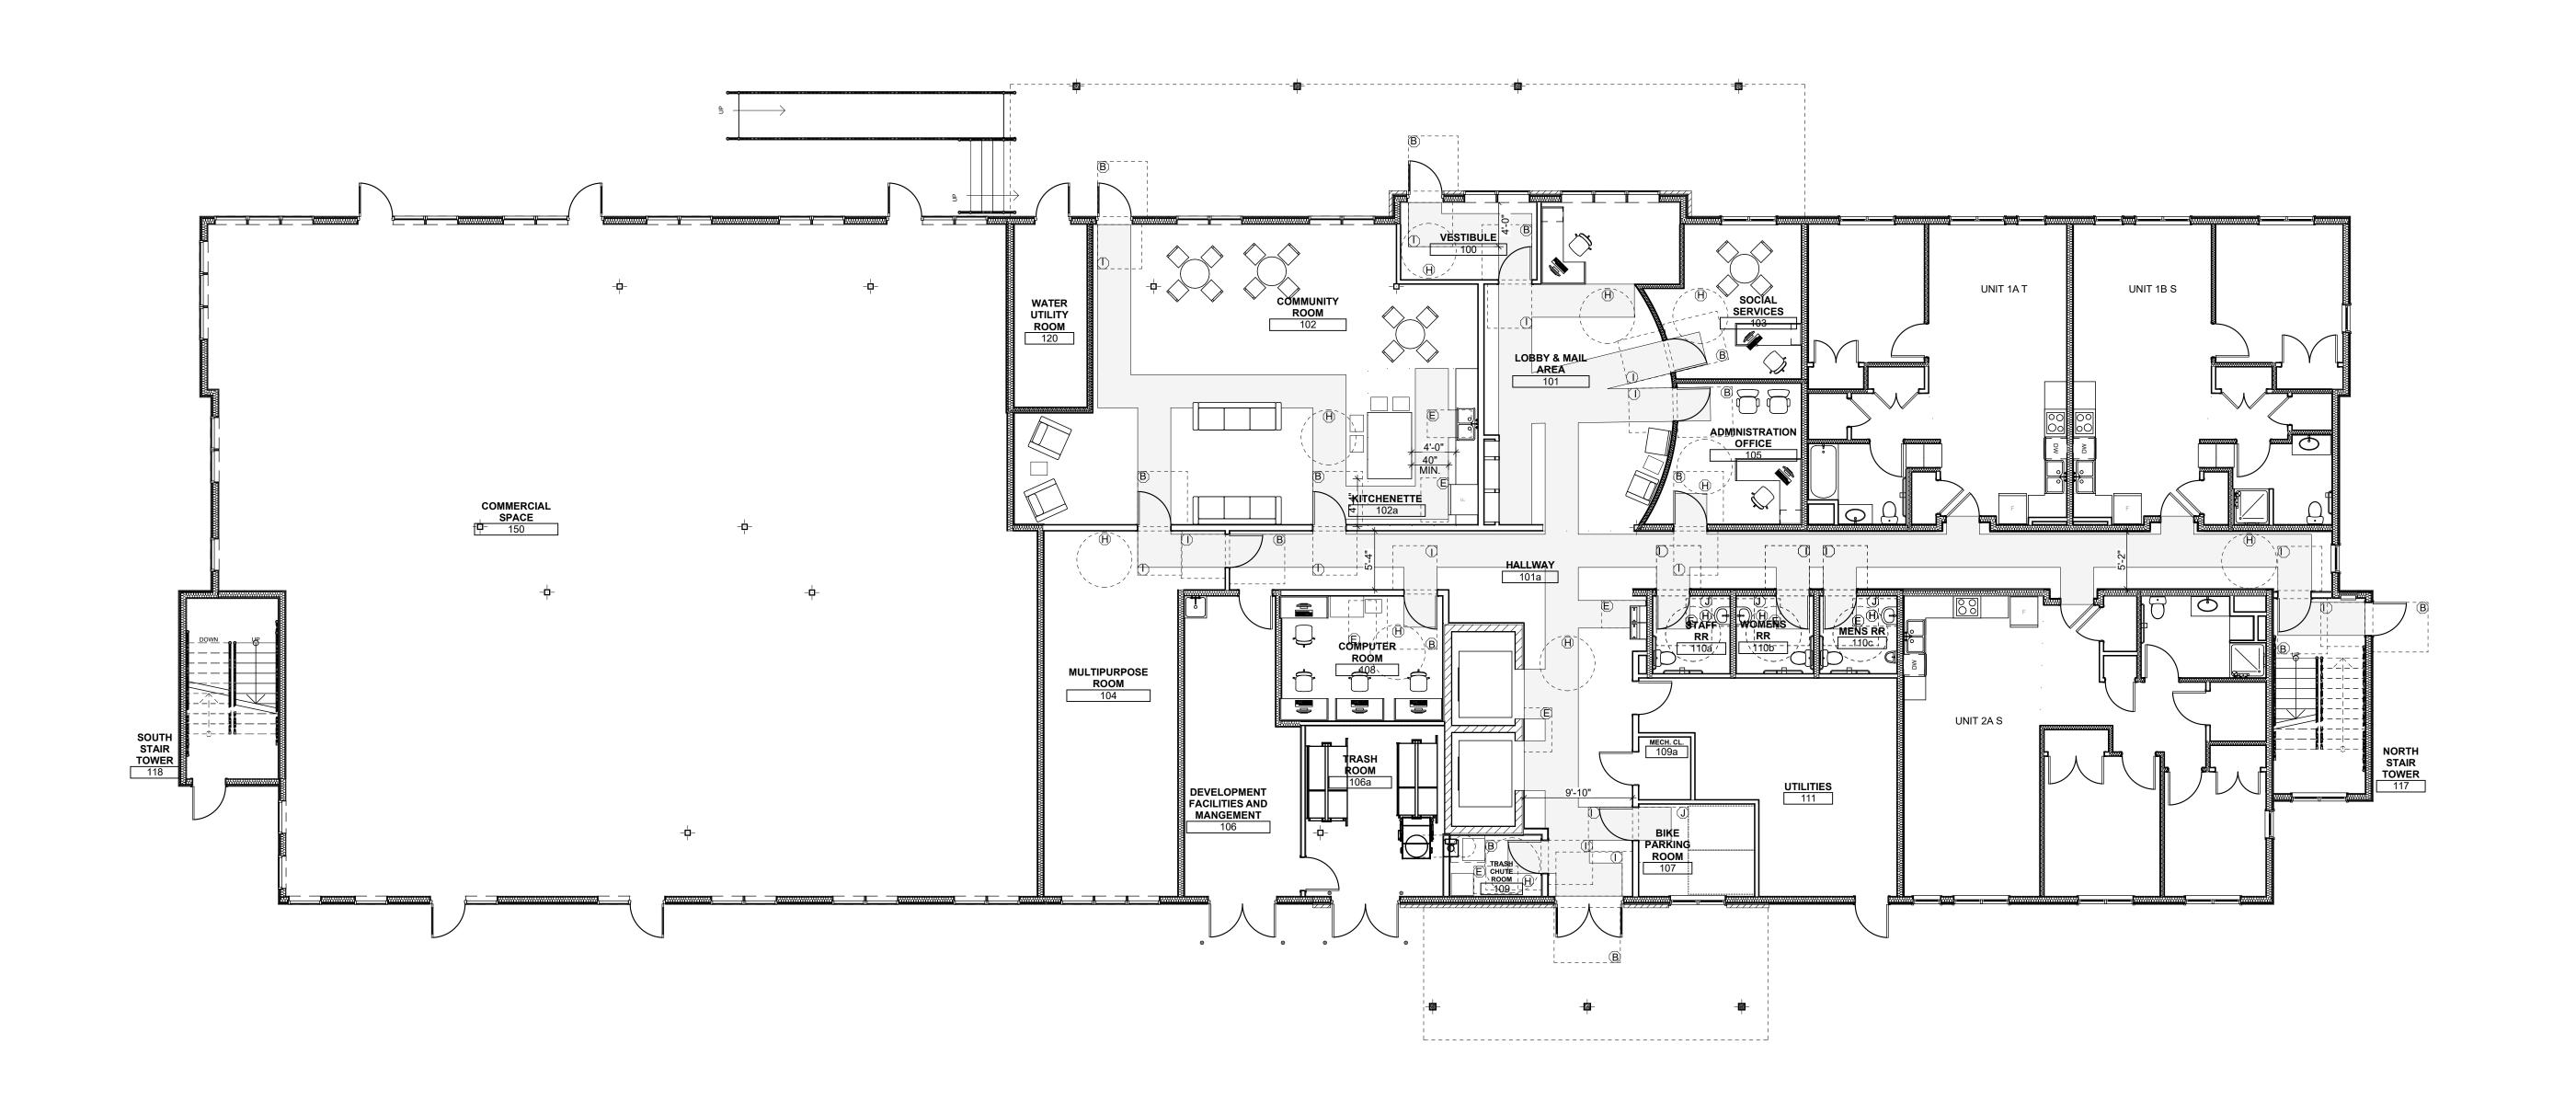

- DOOR WIDTH X 48"
- DOOR WIDTH+18" LATCH SIDE X 60"
- DOOR WIDTH+24" LATCH SIDE X 48"
- 60" X 66" (TYPE A W.C. W/ LAV. OVERLAP EXCEPTION)
- 30" X 48" CLEAR FLOOR SPACE
- 30" X FULL LENGTH OF BATHTUB (60" MIM) BATHTUB CLEARANCE
- 60" X 56" (W.C.)

UNIT 1E T

UNIT 1E S A

Slope 3:12

UNIT 1C T

Slope 3:12

UNIT 1E T

UNIT 1E S

UNIT 2C S

UNIT 1E T

- 60" DIA. TURNING SPACE
- DOOR WIDTH+12" LATCH SIDE X 48"
- DOOR WIDTH+24" LATCH SIDE X 54"
- 36" X 48" SHOWER CLEARANCE
- 36" X FULL LENGTH OF ROLL-IN SHOWER

60" X 60" T-SHAPED TURNING SPACE

- 36" WIDE UN-OBSTRUCTED PATH OF EGRESS
- 30" CLEARANCE (AROUND BED)

REFRIGERATOR AND PANTRY/LINEN CABINET DOOR SWING

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project title

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Client:

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Project Location:
Northview Heights Midrise
246 Penfort Street
Pittsburgh, PA 15214

drawing title

SECOND FLOOR ACCESSIBILITY **PLAN**

scale As Noted December 3rd, 2023

TS10

Project #2040

Sheet No.

10 | 233 |

2ND FLOOR ACCESSIBILITY PLAN

SCALE: 1/8" = 1'-0"

SOUTH STAIR TOWER

UNIT 1E S

PLAN NORTH

- DOOR WIDTH X 48"
- DOOR WIDTH+18" LATCH SIDE X 60"
- DOOR WIDTH+24" LATCH SIDE X 48"
- 60" X 66" (TYPE A W.C. W/ LAV. OVERLAP EXCEPTION)
- 30" X 48" CLEAR FLOOR SPACE
- 30" X FULL LENGTH OF BATHTUB (60" MIM) BATHTUB CLEARANCE
- 60" X 56" (W.C.)

UNIT 1E T

UNIT 1E S A

UNIT 1C T

- 60" DIA. TURNING SPACE
- DOOR WIDTH+12" LATCH SIDE X 48"
- DOOR WIDTH+24" LATCH SIDE X 54"
- 36" X 48" SHOWER CLEARANCE
- 36" X FULL LENGTH OF ROLL-IN SHOWER

60" X 60" T-SHAPED TURNING SPACE

- 36" WIDE UN-OBSTRUCTED PATH OF EGRESS
- 30" CLEARANCE (AROUND BED)

REFRIGERATOR AND PANTRY/LINEN CABINET DOOR SWING

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Client:

Allies & Ross Management and Development Corporation (ARMDC) 200 Ross Street Pittsburgh, PA 15219

Project Location:
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Pittsburgh, PA 15214

drawing title

THIRD FLOOR ACCESSIBILITY **PLAN**

scale As Noted December 3rd, 2023

TS11 Project #2040

Sheet No.

3RD FLOOR ACCESSIBILITY PLAN

SCALE: 1/8" = 1'-0"

SOUTH STAIR TOWER 318

UNIT 1E S

UNIT 1E S

UNIT 2C S

UNIT 1E T

UNIT 1E T

- DOOR WIDTH X 48"
- DOOR WIDTH+18" LATCH SIDE X 60"
- DOOR WIDTH+24" LATCH SIDE X 48"
- 60" X 66" (TYPE A W.C. W/ LAV. OVERLAP EXCEPTION) 30" X 48" CLEAR FLOOR SPACE
- 30" X FULL LENGTH OF BATHTUB (60" MIM) BATHTUB CLEARANCE
- 60" X 56" (W.C.)
- 60" DIA. TURNING SPACE
- DOOR WIDTH+12" LATCH SIDE X 48"
- DOOR WIDTH+24" LATCH SIDE X 54"
- 36" X 48" SHOWER CLEARANCE
- 36" X FULL LENGTH OF ROLL-IN SHOWER
- 36" WIDE UN-OBSTRUCTED PATH OF EGRESS

60" X 60" T-SHAPED TURNING SPACE

- 30" CLEARANCE (AROUND BED)
- REFRIGERATOR AND PANTRY/LINEN CABINET DOOR SWING

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revisions

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Client:

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Project Location:
Northview Heights Midrise
246 Penfort Street
Pittsburgh, PA 15214

drawing title

FOURTH FLOOR ACCESSIBILITY **PLAN**

scale As Noted December 3rd, 2023

12 | 233 |

Sheet No.

TS12 Project #2040

1 4TH FLOOR ACCESSIBILITY PLAN
SCALE: 1/8" = 1'-0"

UNIT 1G S

SOUTH STAIR TOWER 418

COMMUNAL ROOF DECK

UNIT 1G T

UNIT 1G T

UNIT 1G S

UNIT 1G S

UNIT 1G T

UNIT 1G T A

PLAN NORTH

structures (or otherwise appropriate for homeownership by tenants as

determined by the Agency). Utility hookups for washers and dryers, including a dryer duct vented to a wall or roof cap, must be provided. In addition, all utilities

As the **DESIGN ARCHITECT**, landscape architect or civil engineer] I, the undersigned, hereby certify

that I have procured and reviewed the applicable Flood Insurance Rate Map published by the Federal

Emergency Management Agency for this development's site and have determined that the site is:

Flood Plain Certification

TAB_08_04 CERTIFICATION OF THRESHOLD CRITERIA

PENNSYLVANIA HOUSING FINANCE AGENCY (2024 UNDERWRITING APPLICATION) PENNSYLVANIA HOUSING FINANCE AGENCY (2024 UNDERWRITING APPLICATION) This preservation development will achieve certification under one of the green building standards Design Architect's/Applicant's Certification Of Selection Criteria _____ Enterprise Green Communities – 2020 Moderate Rehab The Agency has requested certain certifications from the architect and applicant in connection with _____ LEED v4 O+M – Multifamily – Certified ICC 700-2020 National Green Building Standard Under Section 305.2 – Whole Building Rating - Bronze The development referenced above includes the following physical characteristics, design ICC 700-2015 National Green Building Standard Under Section 305.4 - Functional amenities, and other provisions for ranking points consideration. (<u>Initial all that apply.</u>) Areas Rating – Compliant with Chapter 12 (must include kitchens and bathrooms) For developments certifying under a National Green Building Program, proof of Project registration/Pre-Build Certification will be required with the Development Submission drawing/specification package. As the DESIGN ARCHITECT, I hereby certify that I either have designed or will design the Energy Efficiency Goals (Only one of the following may be selected) referenced development to include the following energy conservation and sustainability measures. The development will exceed the energy efficiency requirements of Energy Star (Current Smart Site Selection - The development is located on, or is a(n): Version) by achieving a reduced HERS index as indicated below. Check the appropriate Brownfield (A former industrial or commercial property on which redevelopment or reuse is complicated by the presence of a hazardous substance, pollutant or contaminant. The Successful Applicants in this category will be required to submit a preliminary HERS presence of lead based paint, asbestos or an underground storage tank does not report with the Development Submission drawing/specification package. The preliminary constitute a Brownfield. The remediation of the environmental hazard must be within the report must include testing of a sampling of each Unit type in all areas within the Building(s) (i.e. Ground floor end & inner Units, Intermediate floor end & inner Units, Upper floor end & inner Units, etc.). KO Blight Remediation or Residential Infill (A vacant, but previously developed site or one containing a dilapidated structure that will be demolished, located in an existing A full HERS Report, certified by the HERS Rater, must be submitted upon construction developed residential neighborhood or a neighborhood consisting of mixed use completion. The full HERS Report must include testing of either a sampling of each Unit residential/commercial properties, where infrastructure for the development is in place or type in all areas within the Building(s) (i.e. Ground floor end & inner Units, Intermediate in close proximity. The infill shall be consistent with the type and scale of the floor end & inner Units, Upper floor end & inner Units, etc.) OR ALL Units within the neighborhood buildings. If the infill structure is only part of the total project, it must Building(s). A certificate for EACH Unit (100%) must be provided at construction represent at least 51% of the total square footage of the project to qualify for these completion and submitted with the Project Closeout documents. If the certificates are not points. Residential over commercial buildings may qualify for these points if this is provided by submission of the Placed-In-Service package, negative ranking points may be assessed. Adaptive Reuse (The rehabilitation of an existing vacant non-residential building into New Construction: residential or residential/commercial space. The residential portion of the rehabilitated building must represent at least 51% of the total residential area of the development.) For 100% electric dwellings/buildings*: HERS Index of 60 or less (without solar PV) ___ For dwellings/buildings utilizing gas: HERS Index of 50 or less (without solar PV) Substantial Rehabs: LEED v4 BD+C Homes & Multifamily Low-rise (1-3 stories) - Silver For 100% electric dwellings/buildings: HERS Index of 70 or less (without solar PV) For dwellings/buildings utilizing gas: HERS Index of 60 or less (without solar PV) LEED v4 BD+C New Construction & Major Renovation – Silver (4 stories or more) _____ ICC 700-2020 National Green Building Standard – Silver TAB_08_02 CERTIFICATION OF SELECTION CRITERIA PENNSYLVANIA HOUSING FINANCE AGENCY (2024 UNDERWRITING APPLICATION) PENNSYLVANIA HOUSING FINANCE AGENCY (2024 UNDERWRITING APPLICATION) **Unit Amenities Design Architect's/Applicant's Certification** As the **DESIGN ARCHITECT**, I certify that: Of Threshold Criteria The net area of all dwelling units must fall within the limits listed below. (Net area is measured from the interior finish surface of the unit perimeter walls, and shall include all rooms, corridors, interior walls, storage areas, and mechanical spaces.) The Agency has requested certain certifications from the architect and applicant in connection with Rehabilitation developments may vary from the maximums and minimums by 10%. Preservation developments shall strive, but are not required, to meet this requirement. Accessible units may vary from the maximums as required to provide an accessible route and accessible clearances. **MULTI-FLOOR UNITS** The development referenced above includes the following threshold criteria. (Initial all that apply) The 90 to 200 s.f. Applicant must request a waiver under Tab #29 for any threshold criteria that will not be provided 400 to 600 s.f The waiver request must describe the mitigating factors responsible for the inability to meet the 1 BR 650 to 950 s.f. 550 to 850 s.f 700 to 1.100 s.f 850 to 1,300 s.f. 3 BR 950 to 1,350 s.f. 1.000 to 1.550 s.f 1.100 to 1.550 s.f 1 200 to 1 750 s f 1,300 to 1,750 s.f. 1.400 to 2.000 s.f Air conditioning will be supplied to the living areas and all bedrooms of each unit. An on-site community room will be provided (not applicable to scattered site (Individual window units will not be considered as meeting this criterion except in properties). It shall be one room sized at 15 square feet per unit for developments with preservation developments.) up to 50 units or at least 750 square feet for developments with more than 50 units. (Applications that are a continuation of a phased development will provide a room to Refrigerators, ranges and ovens will be provided in all units except for developments meet the size requirements based on the aggregate of the number of units in all containing SRO units provided such properties have common cooking facilities phases.) A kitchen or kitchenette with a full-sized range and full-sized refrigerator, is to containing these appliances. be provided in or adjacent to this room in developments for the elderly. (The kitchen or kitchenette shall not be included in the required square footage.) (A long-term Window treatments in all residential units are required. Window treatments include agreement with an existing community facility within walking distance from the horizontal blinds, vertical blinds, or other opaque blinds. Commercial grade roller development may be considered, at the discretion of the Agency.) shades will be permitted on large window expanses. Common laundry facilities or the provision of washers and dryers in each dwelling unit will be provided. Common laundries will contain one washer and dryer for every 12 units in general occupancy developments or every 20 units in elderly developments with a minimum of two washers and dryers required in each laundry facility. A minimum As the **DESIGN ARCHITECT**, I certify that: of one front load washer and dryer will be provided in each laundry facility and in accessible units containing a washer and dryer in the unit. If the development is The following dwelling unit types shall meet the VisitAbility requirements: 100% of newly providing common laundry facilities and designed for home ownership, hook-ups for constructed single-family homes, townhouses, and units in elevator buildings; all ground washers and dryers must also be provided in each unit. All washing machines must be floor units in walk-up apartment buildings. Rehabilitation developments should strive for 100% compliance, but at least 33% shall meet the VisitAbility requirements. Properties An on-site management office will be provided. (Not applicable to scattered site unable to comply with this requirement due to physical constraints or building type may properties. Applications that are a continuation of a phased development will provide a apply for a waiver from this threshold requirement. To meet VisitAbility design features the building and units must have at least one zero-step entrance with a 36-inch wide door; all doorways and passages on the entry level floor should have a width of 36 All common areas (except for stair towers, mechanical rooms, storage rooms and inches; there should be a clear pathway to a bathroom or powder room; such bathroom similar spaces) will be air conditioned. (Includes Preservation) or powder room should include a minimum 24-inch grab bar beside the toilet on a reinforced wall, which can also serve as a towel bar; and there should be a clear pathway to the living room and dining area of the unit. The VisitAble powder room or bathroom must provide maneuverability clearances in accordance with the Fair Housing Act Design Manual. (Preservation developments are exempt from this requirement but are encouraged to provide VisitAble units where feasible.) TAB_08_04 CERTIFICATION OF THRESHOLD CRITERIA PENNSYLVANIA HOUSING FINANCE AGENCY (2024 UNDERWRITING APPLICATION) PENNSYLVANIA HOUSING FINANCE AGENCY (2024 UNDERWRITING APPLICATION) Sizing of Heating and Cooling Equipment (Applicable only to new heating and cooling ____ Outside of a flood way Control Courside any flood area _____ Inside a flood way Energy Star Appliances (Applicable only to new appliances) Inside a 500 year flood area Inside a 100 year flood area Healthier Material Selection (Applicable only to new paints, coatings and primers) Energy Rebate Analysis (ERA) Managing Moisture: Foundations (Applicable to new addition foundations) Managing Moisture: Roofing and Wall Systems (Applicable to new walls, windows and A preliminary/draft explanation of all energy rebates that may be available for the project with estimated rebate amounts must be submitted with the application. The estimated rebate amounts will Combustion Equipment (Carbon monoxide alarm requirements apply to all projects be considered a source and used to size tax credit awards, and must be included on the Certification with combustion equipment. Venting requirements are applicable to new combustion of Subsidies at Tab 20. The energy rebate is not basis eligible and will be removed from basis on a tax credit development. Prior to closing the developer will be required to submit an updated ER Integrated Pest Management (Applicable only if identified as a problem in the PCNA) Building Operations & Maintenance Manual and Plan (Follow Enterprise requirements) Emergency Management Manual (Follow Enterprise requirements) a) A list of eligible utility, local, regional, state, or federal rebate programs; b) Recommendations of applicable rebates to be included with estimated rebate amounts or estimated tax credit amounts; c) Calculations, energy models, or other technical data to support recommendations; The installation of broadband infrastructure is required in all projects, in compliance with d) Letters, program data information, or other documentation from utility providers to support noted Federal Register 81 FR 31181 "Narrowing the Digital Divide through Installation of programs, and Broadband Infrastructure." Infrastructure must be provided in each dwelling unit e) If renewable energy strategies are proposed, a cost/benefit analysis. neeting the Federal Communications Commissions (FCC's) definitions in effect at the time the pre-construction estimates are generated. Currently the FCC defines DESIGN ARCHITECT broadband speeds as 25 Mbps download and 3 Mbps upload. Print: Kento Ohmori Firm Fukui Architects At construction completion, a policy prohibiting the use of prohibited tobacco Acknowledged and Accepted by the APPLICANT(S) products in all living units and interior areas including but not limited to

TAB 08 04 CERTIFICATION OF THRESHOLD CRITERIA

Preservation (Moderate Rehab) * Fair Housing Final Audit Report

TAB_08_04 CERTIFICATION OF THRESHOLD CRITERIA PHFA Threshold Criteria - No Smoking - NVM (2021.8.30)r1 2021-09-03 2021-08-30 Jerome Frank (Jerome.Frank@Hacp.org) Signed Transaction ID: CBJCHBCAABAAxdcuogEp2oRx2NpNDWJV31m1Pqp51xYh "PHFA Threshold Criteria - No Smoking - NVM (2021.8.30)r1" Hi Document created by Jerome Frank (Jerome.Frank@Hacp.org) 2021-08-30 - 1:09:49 PM GMT- IP address: 65.199.18.195 Document emailed to JW Kim (jungwook.kim@hacp.org) for signature 2021-08-30 - 1:14:53 PM GMT Email viewed by JW Kim (jungwook.kim@hacp.org) 2021-08-30 - 2:58:13 PM GMT- IP address: 74.125.212.5 Document e-signed by JW Kim (jungwook.kim@hacp.org) Signature Date: 2021-08-30 - 2:58:51 PM GMT - Time Source: server- IP address: 65.199.18.195 Document emailed to Ashley Yourick (ashley.yourick@hacp.org) for signature Email viewed by Ashley Yourick (ashley.yourick@hacp.org) 2021-08-30 - 3:05:37 PM GMT- IP address: 74.125.212.5 Document e-signed by Ashley Yourick (ashley.yourick@hacp.org) Signature Date: 2021-08-30 - 3:08:51 PM GMT - Time Source: server- IP address: 65.199.18.195 Document emailed to Michelle Hoyle (michelle.hoyle@hacp.org) for signature 2021-08-30 - 3:08:54 PM GMT Email viewed by Michelle Hoyle (michelle.hoyle@hacp.org) 2021-08-30 - 6:45:49 PM GMT- IP address: 74.125.212.31 Document e-signed by Michelle Hoyle (michelle.hoyle@hacp.org) Signature Date: 2021-09-01 - 1:50:10 PM GMT - Time Source: server- IP address: 65.199.18.195 Adobe Sign

PENNSYLVANIA HOUSING FINANCE AGENCY (2024 UNDERWRITING APPLICATION) For 100% electric dwellings/buildings*: HERS Index of 80 or less (without solar PV) contact persons and contact information. ___ For dwellings/buildings utilizing gas: HERS Index of 75 or less (without solar PV) *Preservation developments whose scope of work exceeds that of Moderate Rehab must meet the requirements for Substantial Rehabilitation. Buildings that fall under the Energy Star® Multi-Family New Construction (MFNC) program must use the REMrate HERS rating program as verification for these points but must follow the Energy Rating Index (ERI) pathway to achieve the Energy Star® label. The ERI pathway must be used for any All HERS Indexes shall be uploaded to the RESNET Registry and the registry ID number shown on the HERS certificate provided at construction Institute U.S. (PHIUS); The development will increase energy efficiency by <u>achieving certification</u> under the U.S. Department of Energy's Zero Energy Ready Home Program Note: Successful Applicants in this category will be required to submit the applicable checklist(s)/Rater report with the Development Submission drawing/specification package. program. A copy of the energy model is included with the application. The Report must include the Zero Energy Ready Home certificate, showing the Unit was designed in conformance with U.S. Department of Energy guidelines and the project meets or exceeds the minimum criteria. drawing/specification package to PHFA. The development will meet Passive House certification requirements (nationally or

internationally) for energy efficiency as described below. (See www.phius.org or www.passiv.de/en for additional guidance.) Passive House Certification is required. • The applicant must contract with a qualified* Certified Passive House Consultant who will certify the proposal at the time of application to PHFA. This certification shall be based on a completed Passive House Planning Package (PHPP) or WUFI Passive (WP) energy model showing compliance with the Passive House Institute (PHI) or the Passive House Institute U.S. (PHIUS) standard and shall be based on schematic drawings and specifications, discussions, assumptions and cost estimates agreed to by the development team (developer, architect, engineer, contractor, energy rater, Passive House consultant). Submission of the PHPP or WP to a Passive House certifying agency is not required at the time of application submission to PHFA. The energy model shall be included in the application accompanied by a brief description of the assumptions made (wall/floor/roof construction, insulation levels, mechanical systems, windows, renewable energy systems, etc.). *Qualified is defined as having completed a minimum of two similar Passive House buildings or an inexperienced certified consultant working under the supervision of a qualified TAB 08 02 CERTIFICATION OF SELECTION CRITERIA

PENNSYLVANIA HOUSING FINANCE AGENCY (2024 UNDERWRITING APPLICATION)

As the **DESIGN ARCHITECT**, I certify that:

selections above

completion.

New construction and substantial rehabilitation developments are designed in conformance with the Fair Housing Act Design Standards Guide, as applicable. The subject development is substantial rehabilitation but is seeking a waiver as existing conditions prohibit 100% compliance with the Fair Housing Act Design Standards

Blocking for future grab bars shall be continuous behind the bar location and sized to accommodate the grab bars required by ANSI A117.1 (Edition currently adopted by PA

Energy Conservation & Green Building Criteria

As the **DESIGN ARCHITECT**, I hereby certify that I either have designed or will design the referenced

development to include the following energy conservation measures: All newly constructed multifamily buildings shall comply with the requirements of the 2020 Enterprise Green Communities program Criteria 5.1a. All HERS Indexes shall be uploaded to the RESNET Registry and the registry ID number shown on the HERS certificate provided at construction completion.

All substantially rehabilitated multifamily buildings shall comply with the requirements of the 2020 Enterprise Green Communities program Criteria 5.1b. All HERS Indexes shall be uploaded to the RESNET Registry and the registry ID number shown on the HERS certificate provided at construction completion In new construction and rehabilitation developments, the overall U-value of the exterior

building envelope must exceed the requirements of the International Energy Conservation Code (Edition currently adopted by PA UCC) Chapter 4 by 10% for buildings three stories or less in height as verified by a REScheck certificate. Buildings four or more stories in height must exceed the requirements of the International Energy Conservation Code (Edition currently adopted by PA UCC) Chapter 5 by 7%, as verified by a COMcheck certificate. Air sealing of the exterior building envelope and attic plane shall be included. Trade-offs available in the REScheck or COMcheck software for mechanical equipment will not be allowed. (Not applicable to preservation

Energy Conservation & Green Building Criteria - In new construction and rehabilitation developments, the overall U-value of the exterior building envelope must exceed the requirements of the International Energy Conservation Code (Edition currently adopted by PA UCC) Chapter 4 by 10% for buildings three stories or less in height as verified by a REScheck certificate. Buildings four or more stories in height must exceed the requirements of the International Energy Conservation Code (Edition currently adopted by PA UCC) Chapter 5 by 7%, as verified by a COMcheck certificate. Air sealing of the exterior building envelope and attic plane shall be included. Trade-offs available in the REScheck or COMcheck software for mechanical equipment will not be allowed. (Not applicable to preservation developments.)

PENNSYLVANIA HOUSING FINANCE AGENCY (2024 UNDERWRITING APPLICATION)

 The Passive House consultant shall provide a copy of their Passive House certification and a list of previous experience in Passive House projects, including

 After funding awards have been made, all successful applicants will be required to obtain a PHIUS Design Certification or PHI pre-certification under the normal time frame and procedures, and forward this to PHFA as part of the Development Submission drawing/specification package.

 During construction all requirements of the certifying Passive House agency shall be inspected by a rater/verifier who was not involved in the building design. At construction completion all tests, verifications and commissioning required by the certifying Passive House agency shall be performed by the rater/verifier. After each site visit by the rater, a report shall be submitted to PHFA.

As the Passive House consultant, I hereby certify that:

• I have contracted with the applicant to provide services necessary to assure that this development will meet standards of the Passive House Institute (PHI) or the Passive House

 Based on schematic drawings and specifications, discussions with, and assumptions made by the development team (comprised of myself, the developer, architect, engineer and contractor) I have completed a Passive House Planning Package (PHPP) or a WUFI Passive (WP) energy model that shows that the building(s) will meet the requirements of the Passive House

 If awarded an allocation of Low-Income Housing Tax Credits and/or Agency funding, a PHIUS Design Certification or PHI pre-certification will be included in the Development Submission

It is understood that final Passive House certification is required;

 A copy of my Passive House certificate has been submitted with this certification, along with a list of previous Passive House experience with contact information and PHIUS/PHI project numbers for each project. If less than two Passive House projects have been completed. I have partnered with a Passive House consultant with two or more completed projects. A copy of their Passive House certificate along with a list of their previous Passive House experience including contact information has been provided.

PENNSYLVANIA HOUSING FINANCE AGENCY (2024 UNDERWRITING APPLICATION)

A REScheck certificate must be provided with the Development Submission drawing/ specification package.

• Provide a REScheck certificate for each Unit type in all areas within the Building(s) (i.e. Ground floor end & inner Units, Intermediate floor end & inner Units, Upper floor end & inner Units, etc.) for envelope only

 Provide a REScheck certificate for each Unit type in all areas within the Building(s) (i.e. Ground floor end & inner Units, Intermediate floor end & inner Units, Upper floor end & inner Units, etc.) for UA envelope. UA reporting compares the actual Building UA with a "target"

 Provide a REScheck certificate for the entire Building, envelope only. Where multiple Buildings are proposed, a certificate for EACH Building is required.

TAB_08_02 CERTIFICATION OF SELECTION CRITERIA

In new construction and rehabilitation developments, all appliances, HVAC equipment with a capacity less than 60,000 btuh, gas fired water heaters, windows, ceiling fans, exhaust fans, range hoods and exit signs, shall be Energy Star® labeled, (Exceptions Programmable thermostats do not need to be provided and windows in buildings over three stories in height may comply instead with ASHRAE Standard 189.1-2009.) (Packaged Terminal Air Conditioners (PTACs) and Packaged Terminal Heat Pumps PTHPs) (Including vertical type configurations may only be used if it can be proven that they comply with the prescriptive requirements of Energy Star® version (current version) for air-source equipment, as tested and certified by Air Conditioning, Heating and Refrigeration Institute (AHRI) only). In addition, 100% of the permanent room light xtures in the dwelling units shall be equipped with LED bulbs or high efficiency fluorescent lamps with electronic ballast; and 100% of the community room and common area corridor and stair lighting shall be fluorescent with electronic ballasts or shall utilize LED bulbs.

All developments utilizing central system refrigerant flow type equipment shall meet or exceed Energy Star criteria specification for light commercial HVAC or have the Energy

In preservation developments, existing refrigerators more than 15 years old will be replaced with Energy Star® labeled type. Existing heat pumps, air conditioning condensing units, and through-wall air conditioners more than 20 years old will be replaced with Energy Star® labeled type, when such equipment exists. Existing furnaces and boilers more than 25 years old will be replaced with Energy Star® labeled type, when such equipment exists. (Programmable thermostats do not need to be provided.) In addition, existing community room, common area corridor and stair lighting more than 15 years old will be replaced with fluorescent fixtures with electronic ballasts or fixtures that utilize LED bulbs. Where windows are scheduled for replacement, they shall be Energy Star® qualified products, except in buildings over three stories in height, wherein window replacement may comply instead with ASHRAE Standard 189.1-2009.

TAB_08_04 CERTIFICATION OF THRESHOLD CRITERIA

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PENNSYLVANIA HOUSING FINANCE AGENCY (2024 UNDERWRITING APPLICATION)

Large Family Units

As the DESIGN ARCHITECT, I hereby certify that I either have designed or will design the referenced general occupancy development to include the following percentage of affordable units with three or more bedrooms:

*High rise developments and senior housing cannot qualify for this category.

Suburban/Rural Urban Percentage >15-20% <u>Percentage</u> >20-25% >15-20% >25%

State number of three or more bedroom affordable units to be developed: State percentage of three or more bedroom units to the total number of units in the development: _____

DESIGN ARCHITECT

TAB_08_02 CERTIFICATION OF SELECTION CRITERIA

plus the following:

As the **APPLICANT**, I certify that:

12/03/2023 Kento Ohmori Print: Fukui Architects Acknowledged and Accepted by the APPLICANT(S) _____ Date:

PENNSYLVANIA HOUSING FINANCE AGENCY (2024 UNDERWRITING APPLICATION)

As the **DESIGN ARCHITECT**, I certify that for new construction and substantial rehab developments:

The referenced development will promote energy efficiency and conservation,

PHFA Green Building Criteria for new construction and substantial rehabilitation

the referenced development to include the following green building features

As the <u>DESIGN ARCHITECT</u>, I hereby certify that I either have designed or will design

be used. (Not applicable to existing buildings.)

As the **DESIGN ARCHITECT**, I certify that for preservation developments:

following mandatory 2020 Green Communities criteria, as amended:

TAB_08_04 CERTIFICATION OF THRESHOLD CRITERIA

Energy Star® labeled equipment, when such equipment exists

When existing equipment and appliances are replaced, they will be replaced with

operational savings and sustainable building practices by meeting the mandatory

measures outlined in the 2020 Enterprise Green Communities Criteria. (Not applicable

1. No piping shall be located outside of the interior finish of the insulated building

2. All domestic water pipes except for cold water PEX piping shall be insulated. (Not

3. Termite shields or borate based wood treatment shall be provided with low VOC

caulking at all floor joints and penetrations to prevent insect infestation. Borate

treatment shall be applied to all wood framing and sheathing to a height of 24"

above the "at grade" floor level. Chemical soil treatment or bait stations shall not

The referenced development will promote energy efficiency and conservation,

operational savings and sustainable building practices by meeting the mandatory measures

of the 2020 Enterprise Green Communities Criteria, as amended below. (Not applicable if

Preservation developments are not required to follow the mandatory 2020 Enterprise Green

Communities criteria for "moderate rehab" projects. Instead, they shall comply with only the

Ecosystem Services/Landscaping (applicable only to new landscaping)

Environmental Remediation (Follow Enterprise and PHFA Tab 17 & 34 requirements)

Minimization of Disturbance during staging and construction. (Applicable only to new

seeking certification under a National Green Building program in Selection Criteria)

Enterprise Green Communities Criteria for Preservation Developments

Water-Conserving Fixtures (Applicable only to new fixtures)

envelope. (Not applicable to existing piping in preservation developments.)

applicable to existing concealed piping in preservation developments.)

if seeking certification under a National Green Building program in Selection Criteria)

For <u>ALL</u> new construction, rehabilitation and preservation applications:

Fukui Architects Pc

Pittsburgh, Pennsylvania 15219

ph 412.281.6001 fx 412.281.6002

205 Ross Street

©2023 Fukui Architects, Pc

general notes Any conflicts in the drawings or between new and

existing construction shall be referred to the Architect.

2. Contractor shall verify all dimensions and existing conditions in the field and shall advise Fukui Architects. **Pc** of any discrepancies between, additions to, deletions from, or alterations to any and all conditions prior to

proceeding with any phase of work. Do not scale drawings. **3.** All work shall be installed in accordance with applicable codes and regulations.

4. Contractor shall be responsible for the patching, repairing, and preparations of all existing floor, wall, and ceiling surfaces as required to receive scheduled finishes.

5. All items shown on drawings are finished construction assemblies. Contractor shall provide and install all

material required for finished assemblies. **6.** All reports, plans, specifications, computer files, field

data, notices, and other documents and instruments prepared by the Architect as instruments of service shall remain the property of the Architect. The Architect shall retain all common law statutory, and other reserved rights, including the copyright thereto.

revisions

project title

Owner:

HACP 200 Ross Street Pittsburgh,PA,15219

Client:

Allies & Ross Management and Development Corporation (ARMDC) 200 Ross Street Pittsburgh, PA 15219

Project Location:

Northview Heights Midrise 246 Penfort Street Pittsburgh, PA 15214

drawing title

PHFA DOCUMENTS

As Noted December 3rd, 2023

Sheet No.

TS13

2.02 DEVELOPMENT SUBMISSION CHECKLIST

Development Name: Northview Heights Midrise	PHFA No.: 2023-XXX (fka 2021-156)
The undersigned certifies that all items have been provided with the requ	ired submission.

Design Architect (Print or type): Kento Ohmori Design Architect (Signature):

Date: 12/03/2023 If insufficient documentation is submitted, PHFA Staff will notify the Development Officer indicating the deficiencies. A review will only be performed when all documentation is received by PHFA. PDF files are not an acceptable form of review. Hard copies must be submitted. When submitting the below information, ensure items 4 - 5, 7 - 9, 11 - 12 & 14 – 16 are submitted in loose form. The Development Submission must include the following:

For all Developments:

- ☑ 1. (2) Sets of bound drawings.
- 2. (2) Sets of bound specifications. ☑ 3. (2) Copies of the Development Requirements Checklist (Section 2.04-New Construction/
- Substantial Rehab OR Section 3.02-Preservation ✓ 4. (1) Copy of the Development Tabular Schedule (Also include on the drawings).
- ☑ 5. (2) Copies of the Proof of compliance with all certifications submitted as part of the loan
- application (Selection Criteria and Threshold Criteria Also include on the drawings).
- ☑ 6. (1) Copy of the full Phase I Environmental Site Assessment and Supplemental Environmental Reports (i.e. Phase II, Asbestos, LBP, lead in water, radon testing and etc.) on CD.
- ▼ 7. (1) Copy of the REScheck/COMcheck certification. ☑ 8. (1) Copy of the preliminary Home Energy Rating System (HERS) report by a certified HERS rater
- and proof of project registration/prebuild certification. 9. (2) Copies of the applicable National Green Building Checklist, as certified to in the application.
- ☑ 10. (1) Copy of the ALTA Land Title Survey, HUD Surveyor's Report and Legal Description (not) required for Tax Credit Only Developments)
- ☑ 11. (1) Copy of the completed Development Submission Construction Cost Estimate. Allowances in the construction budget are not permitted.
- ☑ 12. (1) Copy of the Development Security and Maintenance Requirements Checklist for Urban
- 13. (1) Copy of the Mechanical Requirements Checklist.
- 14. (1) Copy of the Electrical Requirements Checklist.
- 15. (1) Copy of the Estimated Utility Costs

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- For all Developments receiving PennHOMES/Agency 1st Mortgage: \square 16. (1) Copy of the Structural Engineer's Report by a registered Structural Engineer, if required
- ☑ 17. (1) Copy of the Subsoil Investigation Report with design recommendations by a qualified

Geotechnical Firm (for new construction and new additions - include in the Specification Manual).

C. A⊠ NA□ Consideration should be given to the installation of electronic high temperature

powder-based stovetop fire suppression canisters above electric or gas ranges. D. A☑ NA□ Kitchen cabinets must meet PHFA standards (refer to PHFA Kitchen Cabinet Minimum Standards, Section 1.25). Cabinets in accessible units must have loop type

limiting devices on the stoyetop elements of electric ranges, or the installation of

- hardware throughout. **E. A**⊠ **NA**□ A minimum of (1) 15" wide drawer base must be provided in all kitchens.
- F. A⊠ NA□ Refrigerators must be provided with all units except SROs with common cooking facilities. All refrigerators must be frost-free and must have 2 doors (separate doors for freezers and refrigerator compartments). Minimum sizes: Eff-10.0 cu. ft., 1 BR - 13.0 cu. ft., 2 BR - 15 cu. Ft., 3 BR - 15.0 c. ft. and 4BR - 17.0 cu. ft.
- **G. A**⊠ **NA**□ In general occupancy units with 2 or more bedrooms, double sinks are required unless dishwashers are provided.
- H. A⊠ NA□ Where dishwashers are supplied, they must be 24" wide, full size, under counter type. Note: No open shelving or cabinets will be permitted.
- 12. Flooring: Where carpet, sheet vinyl, VCT or laminate flooring is used, the floor/ceiling assembly must comply with sound rating requirements found in this Section.
- **A. A**⊠ **NA**□ Carpet must meet the acceptance criterion of Federal Standard DOCFF1-70 for flammability or Class II, 0.22watts/cm² per the International Building Code, whichever is greater. Carpeting in units must be a minimum of 24 oz. goods and in public spaces, a minimum of 28 oz. goods. Parquet, hardwood, tile, or equal quality flooring may be substituted where sound transmission is not a factor.
- **B.** A⊠ NA□ Where provided, carpet padding must be a minimum of Class 2, 8.5 lb./cu. ft. (32 oz./sq. yd.) density goods meeting HUD UM-72 requirements.
- **C. A** ☑ **NA** ☐ Where carpet is provided in accessible Units, direct glued down carpet must be used. $\textbf{D.} \quad \textbf{A} \boxtimes \quad \textbf{NA} \ \square \quad \text{Carpeting is recommended throughout the apartments with the exception of utility}$ closets, laundry areas, bathrooms, kitchens, and entrance foyers where entry is directly from the outside (e.g. as in townhouses). Hard surface flooring may be substituted for carpet if documentation, which verifies that sound transmission
- ratings and impact isolation ratings will be met, is provided. **E** A□ NA□ Sheet vinyl must be full spread adhesive installation, using maximum width possible to avoid seams.
- F. A□ NA⊠ Bathroom floor finish must be ceramic tile or sheet vinyl. Vinyl composition tile
- (VCT) is not acceptable **G.** A ■ NA□ Luxury Vinyl Tile (LVT) is permitted in bathrooms, only if the manufacturer's documentation specifically indicates the product is permitted in bathrooms and is

provided in the specifications 13. Furnishing

- A. A⊠ NA□ All windows, half-lite (minimum) entrance doors, sliding glass door and patio doors within habitable spaces must be equipped with blocking for a curtain rod and horizontal blinds, vertical blinds, or other opaque blinds. (High quality commercial grade roller shades are permitted at large expanses of glass).
- B. A⊠ NA□ Community spaces must be furnished with blocking for a curtain rod and horizontal blinds, vertical blinds, or other opaque blinds. (High quality commercial grade roller shades are permitted at large expanses of glass).

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2.04 DEVELOPMENT SUBMISSION REQUIREMENTS CHECKLIST

2.03 DEVELOPMENT TABULAR SCHEDULE (New Construction and Substantial Rehabilitation-ALL FUNDING TYPES) **Development Name:** Northview Heights Midrise PHFA No.: 2023-XXX (fka 2021-156) Development Name: Northview Heights Midrise Design Architect (Signature): PHFA No.: 2023-XXX (fka 2021-156) **Date:** 12/03/2023 1. Number of Buildings: 1 The undersigned certifies that all items have been provided in the drawings and/or the specifications. 2. Building Height (Stories): 55 feet **Design Architect (Print or type):** Kento Ohmori 3. Building Code: IBC ⊠ IRC □ Construction Type: 5A Design Architect (Signature): 4. Structural System: Wood fram, Masonry Date: 12/03/2023 5. Exterior Finish: Brick, Cementitious Siding, Vinyl Siding 6. Gross Building Area*: 48,134

Check the appropriate box if the development conforms to the requirement. Check \underline{A} if it is applicable or NA if it is not applicable. The Architect must submit a written request to PHFA for any waiver of the PHFA Design Requirements or for any items that are neither checked nor indicated as not applicable. Percentage of Gross Building Area: 9.35%

1. Minimum Unit Size Requirements

The following matrix established the minimum and maximum allowable **net** square footage area for units funded by PHFA. Net square footage shall be measured from the inside face of the exterior walls to the inside face of interior demising walls. The net area does not include unfinished outdoor storage space, spaces for heating and cooling equipment located outside the unit, garages, or porches, patios, and balconies. Rehabilitation developments may vary from the minimums and maximums by 10% if acceptable furnishing plans are provided. Accessible units may vary from the maximums as required to provide an accessible route and accessibility maneuvering clearances. An Efficiency Dwelling Unit is defined as having a single habitable room without demising walls/doors separating the Living, Dining, Kitchen and Sleeping areas. Refer to Section 1 for additional requirements and Section 1 "Definitions" for SRO and Efficiency Unit designations.

Deminions	101 5110 0	and Emerciney offic designations.	
		<u>Flats</u>	Multi-Floor Units
$A\square$ NA \boxtimes	SRO	90 to 200	
A□ NA⊠	EFF	400 to 600	
A⊠ NA□	1 BR	550 to 850	650 to 950
A⊠ NA□	2 BR	700 to 1,100	850 to 1,300
A□ NA⊠	3 BR	950 to 1,350	1,000 to 1,550
$A\square$ NA \boxtimes	4 BR	1,100 to 1,550	1,200 to 1,750
$A\square$ NA \square	5 BR	1,300 to 1,750	1,400 to 2,000

2. Minimum Room Size Requirements All bedrooms must have a demising wall with a door between it and other spaces within the dwelling unit, there must be a closet and an operable window to provide natural light and ventilation. Minimum room sizes do not include unusable alcove space at doors. Accessible rooms may require additional space. (Waivers may be granted for room sizes in rehabilitation developments only, based on acceptable furnishability plans).

A⊠ **NA**□ Primary bedroom – 120 SF (least dimension 10′-0″).

A \boxtimes **NA** \square Additional bedroom(s) – 90 SF (least dimension 9'-0").

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16. **Blocking:** Provide concealed 1½" thick wood blocking at the following locations:

A. A I NA O All wall mounted accessories (curtains, blinds, towel bars, toilet accessories). **B.** A⊠ NA□ Grab bars – Blocking for installed or future grab bars shall be continuous behind the bar location. Where small grab bars are installed for Visitability or Fair Housing Act conformance, the blocking shall be sized to accommodate the grab bars required by ANSI A117.1-2009 (or edition currently adopted by PA UCC).

17. Laundry Facilities: Single unit, combination washers/dryers are not acceptable in any unit. Stackable washers and dryers will not be allowed in accessible units. In developments with shared facilities, the laundry shall be located in a separate room and not be shared with a Community Room or other common area.

A. A. NA Central laundry facilities must be provided unless individual washers and dryers are provided in each unit. For developments consisting of numerous buildings, several small facilities may be provided in lieu of one facility.

B. A NA If central facilities are provided, at least one washer and one dryer must be provided for every 12 units in general occupancy developments or every 20 units in elderly developments, with a minimum of 2 washers and 2 dryers required in each facility.

C. A NA NA A minimum of 1 front loading washer and dryer must be provided in each common laundry facility and in accessible units with laundry facilities. **D.** A□ NA⊠ If central facilities are provided in developments that will convert to homeownership, washer and dryer hookups must be provided within the dwelling

E. A□ NA⊠ Washer and dryer areas located within a unit must be concealed unless located in a basement.

F. A NA Stackable washers and dryers may be used in units with 2 or less bedrooms. Large capacity side by side washers and dryers must be provided in units with 3 or more

G. A NA A built in sorting counter, hanging rod or space for a table and portable hanger must be provided as well as space for chairs in all laundry facilities.

H. A⊠ **NA**□ The equipment may be coin operated type leased from a concessionaire.

18. Development Facilities and Maintenance:

 $A.~~A\boxtimes~~NA\square~~$ A minimum of 120 SF of maintenance space for storage of building and ground maintenance equipment, tools and supplies, and a workshop must be provided. Note that where hazardous materials such as gasoline are stored, special precautions must be taken.

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- **A. A NA** Must be provided in all living rooms and bedrooms. Skylights are not acceptable as the only source of light and ventilation in a room.
- **B. A** ⊠ **NA** □ At least one window per room must be ventilating type window with a full screen

* Calculation of storage space shall be floor area only and not calculated by individual shelves or

separate 9 SF of storage space inside or outside of the unit in a basement or other

7. Gross Commercial Area (SF): 4,500

10. Applicable Accessibility Regulations:

Unit/Room Type

SRO

EFF

2 BR

3 BR

Community Room

Circulation,(hallways,

Other

Unit Total

stairs & etc.)

8. Number of On-Site Parking Spaces: 37

9. Required Variances: Use Variance, Height Variance

Section 504⊠ UFAS⊠ PAUCC⊠ FHAA⊠ ADA⊠

Accessible Units

Units

1000

1125

6765

975

6053

ADA | H/V | ADA | H/V |

6 2 37 37

Gross Building Area (SF) is all improved areas including commercial space measured from the outside of

the exterior wall. Mechanical Rooms, Electrical Rooms, Storage Rooms, and similar spaces that are

conditioned to the same degree as a living space and are finished should be calculated at 100%.

Basements, Garages, and similar spaces that may be finished (or unfinished), but not conditioned to the

same degree as a living space, must be calculated at 50% of the actual size. The upper portion(s) of

multistory spaces shall be excluded from the square foot calculation. Include only the lowest floor area.

** Net Area (SF) is measured from the interior face of the unit separation and/or exterior walls. Show the

A. A NA A building or development identification sign must be provided in a highly visible

B. A□ NA⊠ All dwelling units with exterior entrances shall have street address/unit number

C. A □ **NA** □ All permanent interior signage, including individual apartment identification, must

D. A \Sigma NA \Boxeta A floor identification sign shall be provided outside the elevator doors on each floor.

E A ■ NA ■ Room identification signs must be provided for all community, management,

15. Closets and Storage: The space (SF) created by closets deeper than 24" but less than 48" will not count

towards the required minimum square feet if the closet has full height hanging space or shelves.

B. A⊠ NA□ Closet door widths shall be sized to offer maximum access to the closet interior. The

C. A ▼ NA □ All closet shelves and rods 4'-0" or longer must be provided with center supports.

D. A ■ NA Pantry storage must be provided and must be concealed (2 lineal feet minimum x

E. A \boxtimes NA \sqcup Linen storage must be provided and must be concealed (2 lineal feet minimum x 18

F. A⊠ **NA**□ An entry closet must be provided (2 lineal feet minimum x 24" minimum depth).

H. A☑ NA□ A minimum of 5 lineal feet of full height hanging space must be provided in each

J. A NA A minimum of 3' lineal feet of full height hanging space must be provided in each

K. A□ NA⊠ General occupancy (family) units with 2 or more bedrooms must have an additional,

Note: Stackable type storage, located in common storage facilities, is not permitted in Elderly (55+ or

L A□ **NA**⊠ SRO's must provide adequate closet or wardrobe cabinet for clothes storage.

G. A⊠ **NA**□ All units must have a minimum of 3′ lineal of miscellaneous storage space.*

A. A NA NA All closets must have doors that fully conceal the contents of the closet.

reach range in accordance with the ADA Guidelines.

width linen cabinet is acceptable).

primary bedroom within a unit

additional bedroom within a unit.

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opportunity logo, and the accessible housing logo.

identification, 3" minimum in height.

maintenance, and public spaces

location (may be freestanding or attached to the building). The sign must contain the

development name, development phone number, TTY number, the equal

comply with ADA, UFAS and ANSI A117.1-2009 (or edition currently adopted by PA

closet interior shall not extend more than 12" on each side of the door opening.

Closets in accessible units must have shelves and rods mounted within the accessible

18" minimum depth closet or an 18" minimum width pantry cabinet is acceptable).

minimum depth closet, separate from a bedroom or coat closet or an 18" minimum

Porches, patios, and balconies shall not be included in the gross building area.

average if there is more than one size in each type.

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19. Natural Light and Ventilation

for the operable portion of the window.

F. A□ NA☑ In municipalities without a zoning ordinance or parking regulations, a minimum of 1 parking space per dwelling unit plus 1 space per employee and 2 accessible guest G. A⊠ NA□ Pedestrian sidewalks must be cast in place concrete, minimum 4" thick over 4"

minimum clean 2B stone base. Bituminous sidewalks are not permitted. **H. A**⊠ **NA**□ Accessible parking spaces and sidewalks that are part of the accessible route shall

have their slope noted in percent.

22. Outdoor Recreational Facilities: Should be considered if none exists in close proximity to the development site. List the recreation equipment planned for the development below:

B. Barbeque

c. Raised bed gardening planters

23. <u>Materials for Outdoor Furnishings, Equipment and Recreational Structures:</u> A. Benches, tables, chairs and play equipment and structures must be of the following materials or combinations thereof:

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A ■ NA Living Room – 150 SF (least dimension 11'-0").

A⊠ **NA**□ Living/Dining Room – 200 SF min. (least dimension 11'-0"). A minimum of 40" from the

The dining area must be in addition to the living room space and must be appropriately sized. An eat-in

kitchen may be substituted for a dining room as long as the kitchen and dining area are appropriately

sized. Island/bar seating is not permitted as the only dining area in General Occupancy developments,

Note: A minimum of 40" from the table edge to a wall or another piece of furniture must be provided.

3. A NA NA Accessibility (Facilities, Apartments and Parking) – All applicable Local, State and

4. A ■ **NA** □ **Community Room Space** – All developments, except scattered sites, should be

5. A⊠ NA□ Management Office – An onsite management office must be provided for all

6. A ■ **NA** □ **VisitAbilitycm*** – In new construction and new additions, all units are expected to be

C. A□ NA⊠ Below grade units must have windowsill heights at a maximum of 4'-6" above floor

A. A⊠ NA□ A semi-gloss, egg shell or equivalent high quality washable latex paint must be

B. A⊠ NA□ Semi-gloss or high-gloss enamel must be specified for laundry, maintenance,

A. A NA NA The parking ratio must be in conformance with the local zoning ordinance unless a

B. A ■ NA □ A minimum of 5% of the total number of parking spaces must meet the latest

C. A ■ **NA** ■ A minimum of 1 accessible parking space must be provided for visitors and must be

D. A ⊠ **NA** □ A minimum of (1) accessible parking space must be provided near the Community

Building/Management Office and must be able to accommodate a van.

storage, and utility rooms in common areas.

C. A⊠ **NA**□ A level 4 minimum drywall finish must be installed.

provided at the same ratio.

able to accommodate a van.

E. A⊠ **NA**□ All driveways, streets and parking lots must be paved.

wells are permitted only in Rehab Developments with PHFA approval.

Federal regulations and PHFA requirements must be met. Please refer to Section 1.02,

designed with adequate community space to accommodate functions and services

offered at the facility. Developments should provide a public restroom. Community

rooms must be a single room sized to provide at least 15 SF per unit, for developments

with up to 50 units. Community rooms in developments with more than 50 units shall

be a minimum of 750 SF in size. Community rooms should not include unusable alcove

space as part of the minimum requirement. A kitchen or kitchenette must be provided

in or adjacent to the community room in Elderly developments and shall not be included

in the required square footage. The kitchen shall include a sink, full height refrigerator

developments, except scattered site developments. Applications which are a

continuation of a phased development that do not include a management office in the

current Application will be required to provide evidence of a management office in one

visitable, unless a waiver was granted during the loan application review. In

level. Grade level cannot be higher than 4'-0" above floor level. Area wells/window

specified for all kitchens and bathrooms in dwelling units and all restrooms, stairs,

corridors, and vestibules in public or common areas, unless a protective wall

accessibility standards. If parking spaces are provided for each unit, accessible

spaces must be provided for each accessible unit. If parking spaces are provided at

a ratio of less than one space per unit, accessible spaces at a minimum shall be

table edge to a wall or another piece of furniture must be provided.

with 2 or more bedrooms. All dining areas should accommodate the following:

Living Room/Dining Room Combination:

A⊠ **NA**□ *EFF*/1 BR Units – Table w/ 2 chairs.

 $A \square NA \square 4$ or more BR Units – Table w/8 chairs.

Efficiency Unit - Living Room/Sleeping Combination:

of the prior phases.

covering is provided.

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21. Parking and Sidewalks:

A□ **NA**⊠ Living/Sleeping – 200 SF min. (least dimension 11'-0").

A ■ NA □ Dwelling unit corridors and stairs – 36" min. width.

Accessibility Requirements, included in this Guide.

A ■ NA □ 2 BR Units – Table w/4 chairs.

A□ **NA**図 3 BR Units – Table w/6 chairs.

Other Unit Space:

rehabilitation developments, PHFA has adopted the goal of providing visitability to as many as possible for the purpose of allowing persons with disabilities the ability to visit

neighbors and friends. Please refer to our VisitAbilitycm Guidelines, Section 1.08.

7. AX NA Air Conditioning – Refer to Section 2.06 Mechanical Requirements Checklist

8. Building Security: A. A. NA All developments with shared entrances must be equipped with an

intercom/security system or equivalent to control access to the building. The system shall not rely on a connection to the telephone service. **B. A**⊠ **NA**□ All dwelling unit entrance doors must be equipped with dead bolt lockset, a passage

latch set and a door knocker or doorbell with viewer. **C. A** ■ **NA** □ All dwelling units must be equipped with an identification number.

9. A NA Below-Grade Units – The maximum distance a floor level in any dwelling unit may be below finish grade elevation outside the unit is 4'-0". Finish grade must slope away from the building. Area wells/window wells are permitted in Rehabilitation Developments with PHFA approval

10. Bathrooms:

A. A NA 1½ baths must be provided for 3 bedroom units and 2 bathrooms must be provided for 4 or more bedroom units (one may include a shower).

B. A NA Vanity bases must be provided for all bathrooms. Vanity bases are recommended in powder rooms unless an additional storage cabinet or closet is provided. Removable fronts are suggested for handicapped adaptable units

C. A ■ NA ■ All bathrooms must have a minimum of (2) 24" towel bars, a toilet paper holder, a shower rod in the tub/shower unit or shower unit, a medicine cabinet with a mirror and a light fixture located over the mirror. Towel bars in bathrooms must be able to accommodate full size towels. Towel bars should be mounted not less than 28" AFF and no higher than 56" AFF. A 24" double towel bar is acceptable if the space does not allow for (2) – 24" towel bars to be installed. Powder rooms must have a minimum of (1) 12" towel bar or towel ring, toilet paper holder and a mirror with a light fixture located over the mirror.

A. A. NA Ranges must be provided in all units, except SROs with common cooking facilities, and in community room kitchens and kitchenettes in Elderly (55+/62+) developments. All units must be equipped with 30" ranges (self-cleaning type required in common areas and all dwelling units). Ranges must not be located abutting partitions. A protective shield must be provided on the section of wall directly behind all ranges. The protection must extend from the top of the range to the underside of the hood or cabinet above for the width of the range or more. Protective shields must be high pressure plastic laminate, enameled steel, or stainless steel.

B. A □ NA □ Ducted range hoods with fans and lights must be provided above all ranges (Recirculating range hoods are allowed in buildings if an intake grille is located near the

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1. A⊠ **NA**□ Wood must be decay resistant species, pressure treated (labeled in accordance with the applicable AWPB Standard), vacuum and non-pressured treated (conforming to NWMA-IS-A and bearing the NWMA Seal of Approval) or a minimum of 2 coats of high quality exterior grade sealer, stain or paint must be applied on all sides, edges and be free of objectionable splinters, checks, shakes,

warping, loose knots, decay, and stains. 2. A NA Concrete must be precast reinforced concrete, sealed with a minimum of 2 coats of acrylic sealer. If color is specified, it must be cast integrally. **3. A** NA Metals must be anodized aluminum or galvanized steel.

4. A ■ **NA** ■ Fiberglass must be "super strength" fiberglass. Lightweight fiberglass is not permitted.

24. <u>Iawn Seeding</u>: Loose seed shall only be permitted to patch small utility excavation, etc. All other seeding shall be one of the following:

A. A⊠ **NA**□ Hydro seed – Contractor shall be responsible for watering, feeding, and mowing until mature growth is established.

B. A□ NA☑ Sod – Contractor shall be responsible for watering and feeding for 3 months after

25. Waste Disposal: (Check applicable systems)

A. AX NA Garbage disposals are recommended where wet garbage presents sanitation problems. Disposals are required in mid- or high-rise buildings if trash chutes and

durable water-resistant floor finish.

C. A⊠ NA□ Trash compactor.

B. A⊠ **NA**□ Trash room(s) – All trash rooms must contain a hose bib and floor drain and have a

D. A□ NA⊠ Dumpster(s). Outdoor collection areas must have concrete pads and be visually

screened, (e.g. evergreen hedges or shrubs, masonry, pressure treated wood or vinyl fence enclosures). The type of collection service must be determined in advance of design in order to establish the correct size and number of areas and the required service vehicle access and clearance. A minimum 6" thick, reinforced structural concrete pad (approximately 10' x width of dumpster enclosure) must be provided in front of the collection area to prevent pavement damage by the garbage trucks for dumpster type collection.

E. A □ NA 🗷 Outdoor trash collection areas, with multiple resident unit trash containers, must have concrete pads, be visually screened (masonry, pressure treated wood or vinyl fence enclosures) from public view and have concrete sidewalk access from the collection area to each dwelling unit and/or public collection area (street).

F. A⊠ NA□ Recycling provisions – The size, number and design of collection area(s) must

conform to the requirements of the Local recycling ordinance. **26. A** NA NA Fire Extinguishers – Provide a minimum of one 5-pound, 2A-10B-C rated fire extinguisher

in all units with a range or cook top. Other fire extinguishers must be provided for the development as required by code. Fire extinguishers cannot be mounted under the sink in accessible units or under the sink in the community room kitchen. If mounted in a closet, it

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Fukui Architects Pc

205 Ross Street Pittsburgh, Pennsylvania 15219 ph 412.281.6001 fx 412.281.6002

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general notes

Any conflicts in the drawings or between new and existing construction shall be referred to the Architect.

2. Contractor shall verify all dimensions and existing conditions in the field and shall advise Fukui Architects. **Pc** of any discrepancies between, additions to, deletions from, or alterations to any and all conditions prior to proceeding with any phase of work. Do not scale

3. All work shall be installed in accordance with applicable codes and regulations.

4. Contractor shall be responsible for the patching, repairing, and preparations of all existing floor, wall, and ceiling surfaces as required to receive scheduled finishes.

5. All items shown on drawings are finished construction assemblies. Contractor shall provide and install all material required for finished assemblies. **6.** All reports, plans, specifications, computer files, field

data, notices, and other documents and instruments prepared by the Architect as instruments of service shall remain the property of the Architect. The Architect shall retain all common law statutory, and other reserved rights, including the copyright thereto. revisions

project title

Owner:

HACP 200 Ross Street Pittsburgh,PA,15219

Client:

Allies & Ross Management and Development Corporation (ARMDC) 200 Ross Street Pittsburgh, PA 15219

Project Location:

Northview Heights Midrise 246 Penfort Street Pittsburgh, PA 15214

PHFA TAB 02 CHECKLISTS

As Noted December 3rd, 2023

TS14

Sheet No.

drawing title

must be located so that the closet contents cannot obstruct the view of or access to the **27.** A NA Basements – Must have 4" concrete floors with vapor barriers over 4" clean stone base. 28. A NA NA Termite Infestation – Measures must be taken to protect the building from termite infestation. Termite shields or borate-based wood treatment shall be provided with low VOC caulking at all floor joints and penetrations to prevent insect infestation. Borate treatment shall be applied to all wood framing and sheathing to a height of 24" above the "at grade" floor level. Chemical soil treatment or bait stations shall not be used. (Not applicable to existing buildings). 29. A NA NA Environmental Remediation Requirements – The Architect must indicate in the Contract Documents any environmental remediation work to be performed on the site. This must be shown as part of the Scope of work described in the Contract Documents. This is required to identify that remediation work needs to be done, so the proper officials will be made aware of the need to certify the work was properly performed. In the case where the environmental remediation work is not part of the Scope of Work, it must be clearly noted in order to place the responsibility on the party responsible for the **A**⊠ **NA**□ Flooring/Ceiling 50(55)*** 50(55)*** * Impact Isolation Class for floor/ceiling assemblies separating living units from other living units and from public spaces and service areas with moderate noise levels. ** Sound Transmission Class for partitions separating living units from other living units and from public spaces and service areas with moderate noise levels. *** (55) represents the IIC and STC Class for separations between living units and high noise areas (e.g. mechanical, emergency generator and trash compactor rooms, elevator, trash chases and chutes, laundry, and maintenance areas, etc.). **31. A** NA Substrates – Ceramic tile or EIFS (Dryvit) interior or exterior finished shall only be installed over cementitious or masonry substrates. Moisture-resistant gypsum board is NOT allowed. **32. A** ⊠ **NA** □ **Ice Dam Protection** – A self-adhesive membrane underlayment shall be installed at all roof eaves and valleys. At eaves, membrane shall extend up roof for a horizontal distance of 24" from interior face of outside wall. **33. A** ⊠ **NA** □ **Drainage Barrier** – A drainage barrier is required behind all siding and masonry veneer in wood framed construction **34.** A□ NA⊠ **Reroofing** – All reroofing applications must include the removal of the existing roofing system down to the roof deck. 35. Elderly (55+/62+) Facilities Amenities: Required physical and design accommodation features and A. A□ NA⊠ Handrails on both sides of common area corridors. Handrail ends must return to the SUBMISSION GUIDE FOR ARCHITECTS, 2024 EDITION **B.** A ✓ NA ☐ Trash rooms. C. A ✓ NA ☐ Laundry rooms. D. A ✓ NA ☐ Mechanical and Electrical rooms. E. A ✓ NA □ Corridors. 7. Air Conditioning Requirements (Mechanical Cooling): A. AV NA The living areas and bedrooms of all dwelling units in new construction, substantial rehabilitation and Preservation developments must be air conditioned. Window air conditioners will not be considered as meeting this criterion, except in Preservation developments (unless Code does not permit this arrangement). **B.** A☑ NA□ In new construction, substantial rehabilitation and Preservation developments, all common areas must be air conditioned, except for stair towers, mechanical and **8.** A ✓ NA ☐ Compressor Warranty – A minimum 5 year compressor and refrigeration circuit warranty is required on all developments for all refrigeration (mechanical cooling) units. This includes through-the-wall equipment, split systems, and central systems **9.** A NA Chemical Feeders – A one shot type, 2 quart minimum capacity chemical feeder must be installed on all developments utilizing central hot and/or chilled water piping systems. 10. A ✓ NA ☐ Utility Metering – To discourage the waste of energy and to encourage conservation. PHFA suggests individual gas metering whenever possible. Gas bulk metering may be provided if the rate schedule justifies its use. Water metering may be bulk and/or individual metering as required by the Local utility company. **11. A** ✓ **NA** ☐ **Clothes Dryers** — Exhaust ductwork must be rigid duct with accessible cleanouts to vacuum clean entire duct system. 12. A ☑ NA ☐ Water Coolers — If provided, water coolers must be dual height type with standard and accessible height spouts. **13. A** ■ **NA** □ **Accessible Units** – Insulate or otherwise protect the hot, cold and drain piping exposed below the kitchen sink and bathroom lavatories. must be heated.

14. A ✓ **NA** ☐ **Sprinkler System** – All group R-2 buildings and townhouses must be provided with an automatic fire suppression system throughout all buildings and structures in accordance with the PA UCC and the International Building Code as applies. All sprinkler/water rooms **15. A** ✓ **NA** ☐ **Pipe and Duct Locations** – All water piping and heating/cooling ductwork must be located within the conditioned space, (i.e., on dwelling unit side of the air barrier on the interior

of the exterior wall and roof/ceiling assemblies). **16.** A□ NA☑ Water Heaters – All water heaters must have a drip pan connected through a trap to a waste line. Minimum capacity water heaters must be provided as follows:

3 BR units and above – 50 gal. 2 BR units – 40 gal.

> 1 BR units - 30 gal. Efficiency units - 30 gal. Elderly units - 30 gal.

17. A☑ NA□ Central Domestic Hot Water Systems – All central hot water piping systems shall include a pumped return to prevent bio-hazard growth.

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36. PHFA Supplemental Accessibility Requirements:

1. Common Areas Designed for Mobility Impairments A. A NA A full width kick plate must be provided on both sides of all exterior doors, all accessible unit entrance doors and all common area doors that permit tenant

B. A ■ NA ■ Wall corner guards (textured vinyl 1-1/2" x 1-1/2" minimum) must be provided at all outside wall corners in all common areas.

C. A⊠ **NA**□ Ranges in common Kitchens or Kitchenettes must be self-cleaning type. **D.** A ■ NA ■ All developments must be designed with a minimum of 5% accessible units and

an additional minimum of 2% hearing/vision impaired units. 2. Accessible Dwelling Units - All accessible units shall conform to the requirements for ICC/ANSI A117.1-2009 (or edition currently adopted by PA UCC) "Type A Units". For developments with federal funding and subject to the Uniform Federal Accessibility Standards (UFAS), note that HUD

allows conformance with the 2010 ADA in lieu of UFAS, with a few limitations. In addition, the following PHFA provisions are required: A. A NA A A full width kick plate must be provided on both sides of all accessible Unit

entrance doors, interior doors that permit passage and on one side of all other

B. A ⋈ NA Wall corner guards (textured, vinyl 1½" x 1½" minimum) must be provided at all outside wall corners within accessible units.

C. A \boxtimes **NA** \square Grab bars must be installed at all required locations.

D. A NA A minimum of 50% of the accessible units shall include a bathroom with an accessible shower (not applicable to dwelling units in general occupancy developments with only one bathing fixture). The remaining accessible units shall have an accessible tub/shower. Accessible showers shall have a curb height of ½". The shower shall include a built-in folding seat, shower controls and an adjustable height hand-held shower head within reach of the seat and a collapsible dam at the shower entrance. All bathrooms with $\frac{1}{2}$ " curbed showers shall have a floor drain provided in the bathroom floor outside of the shower. Trench drains will not be permitted. A removable seat shall be provided in all accessible tub/showers. Elderly developments are encouraged to provide accessible showers in 100% of the Units.

E. A NA Shower heads and mirrors in accessible units shall be mounted to permit use by those with mobility impairments and those without.

F. A NA Due to the requirement for knee space beneath the sink and work counter in accessible kitchens and the lavatory in accessible baths and the minimal accessibility of wall cabinets, pantry and linen cabinets or closets must be provided in accessible units.

G. A NA Removable kitchen and bath base cabinets may be installed at the areas requiring knee space. These cabinets must be removable without disconnection of any plumbing lines. The walls, floor and sides of adjacent cabinets must be finished, and wall base installed during the initial construction. **H. A** ⋈ **NA** □ Refrigerators should be located to allow doors to open 180°.

I. A ■ NA □ Ranges must be self-cleaning type. J. A☑ NA□ A 30" work surface with knee space (or removable cabinet) beneath must be

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provided beside the oven in all accessible kitchens

18. A ☑ NA ☐ Domestic Water Plumbing Systems Using PEX or Other Cross-linked Polyethylene Piping - Shall be installed with manifolds in each individual dwelling unit. The manifolds shall be accessible by means of an access panel or door. All piping from the manifold block to each plumbing fixture shall be a single length of continuous polyethylene cross-linked pipe (no joints are allowed).

19. A ✓ **NA** ☐ **Pipe Insulation** – All hot and cold-water piping, except for cold water PEX piping, shall be

• Insulation on hot or cold PEX piping is not required within an apartment unit, unless it is required to obtain certifications under the various Green Building or Energy Programs. Provide additional PEX insulation if required by local code.

• PEX piping only (Unitized tank water heater systems): Insulate hot water lines from the water heater, including valving, to the manifolds. The insulation will stop at the manifold.

 PEX piping only (Central systems): Insulate from the apartment shut-off valve, including the <u>valve</u> and/or to the manifold, whichever occurs last in the stream, and any re-circulating piping and/or check-valve.

20. Grilles, Registers and Diffusers, Single Point Exhaust Fans **A.** A□ NA☑ **Return Register** – In multi-level units, a return grille is required on each level, as prescribed in the 2006/2009 IRC through ACCA Manual D. This shall also apply to all PHFA multi-level units constructed under the IBC. The return air duct may be a plenum type as permitted by code and all applicable fire codes must be satisfied.

B. A☑ NA□ All wall or ceiling mounted Grilles, Registers, and Diffusers must be secured to separate metal frame / flange or other hard blocking and NOT solely to the gypsum wall board. or similar finish material. A detail will be shown on the drawings for this installation. Inclusive will be all necessary air sealing of the frame /flange to the outlet duct.

C. A☑ NA□ Single point exhaust fans, e.g., bathroom fans or similar, [housings] will be secured to the building structure and not to the wallboard or similar finish material. Fan exhaust grilles will fit flush to the finish surface without the use of non-manufacturer supplied gaskets or sealants.

21. Air Conditioning Requirements (Mechanical Cooling): **A. A** ■ **NA** □ **Sealing** – All duct joints and seams shall be sealed with mastic or similar product as

listed in SMACNA Manual N.

B. A ✓ NA ☐ **Hangers** – Duct hangars shall not include fasteners that penetrate the duct. C. A☑ NA□ Equipment Servicing – In mechanical rooms or closets containing multiple pieces of equipment, it must be possible to service and replace each piece of equipment without

D. A□ NA☑ <u>Electric Resistance Heat</u> – An HVAC system utilizing electric resistance heating as the primary heat source shall not be allowed in PHFA developments.

E. A ✓ NA ☐ Exposed Plumbing – All plumbing lines must be concealed except in mechanical rooms and unfinished basements only. F. A ☑ NA ☐ Shut-off Valves - Shut-off valves must be installed at the main water line(s) where

they enter the unit and on each line at all plumbing fixtures, including the water heater. **G.** A□ NA☑ If central facilities are provided in developments that will convert to homeownership, washer and dryer hookups must be provided within the dwelling Unit.

Note: Abandoned equipment in existing buildings will not be permitted and must be removed from the

Note: All utilities must be individually metered in units designated for conversion to homeownership

accessible kitchen sinks and lavatories, even if removable cabinets are installed. L A⊠ NA□ An accessible route must be provided to all spaces and elements in an accessible unit, in accordance with ANSI A117.1-2009 (or edition currently adopted by PA UCC). Section 1003.3. Accessible bedrooms must have a minimum 30" access aisle on both sides and at the foot of the bed. The primary bedroom must accommodate a gueen size bed. All other bedrooms must accommodate a twin

K A⊠ NA□Knee and leg protection must be provided at all exposed plumbing beneath

M. A⊠ **NA**□ At the exterior entrance to an accessible, adaptable, or Visitable unit, minimum 30" overhang or porch roof is required to protect the entrance door from rain and N. A NA□ The accessible dwelling units must be distributed throughout the building(s) and

site in a sufficient range of sizes and amenities to allow a choice of living arrangements for persons with disabilities, generally comparable to that of other **37. A** \(\brace{\text{NA}} \) **Broadband Infrastructure** — Refer to Tab 8 Threshold Criteria and as amended by

Tab 8 Selection Criteria. 38. Energy Efficiency: **A. A**∑ **NA**□ All roof trusses with insulation located along the bottom chord shall be "energy" or "faised heel" trusses which allow for full depth (uncompressed) insulation to

extend to the exterior face of the insulation. **B.** A⊠ NA□ Interior wall insulation at all below grade walls shall be foil-faced rigid foam insulation board rated for an exposed installation (in storage or mechanical rooms) or rigid foam insulation board covered with a code approved material (in all finished areas). All joints in the insulation board shall be air sealed. Fiberglass or cellulose insulation will not be allowed.

C. A ■ NA ■ Rim joists that are not insulated on the exterior shall be air sealed and insulated with unfaced rigid foam insulation with edges sealed with closed cell spray foam insulation or entirely with closed cell spray foam insulation.

D. A \(\bigcap NA \(\superaction \) The foundation insulation at all slab-on-grade construction shall begin at the top of the slab and extend the code required depth below grade. The top of the insulation may be beveled at 45 degree angle per the International Energy Conservation Code.

A **⋈** NA □ Sub-slab depressurization system. **A** ■ NA □ Common house (non-tenant) power source in close proximity to vents for installation

of fans (if required). A ☑ NA ☐ An Indicator, signifying the fan is in operation, must be visible in a common area.

40. A NA NA The Architect has reviewed the Design Architect's Certifications for Threshold and **Selection Criteria** submitted in the loan application and hereby confirms that he/she has incorporated all certified amenities into the Contract Documents and that the checklists have been included on the drawings.

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2.07 ELECTRICAL REQUIREMENTS CHECKLIST

Development Name: Northview Heights Midrise The undersigned certifies that all items have been provided in the drawings and/or the specifications.

Design Architect (Print or type): Kento Ohmori Design Architect (Signature):

39.Radon-Refer to Section 1.21

Check the appropriate box if the development conforms to the requirement. Check \underline{A} if it is applicable or <u>NA</u> if it is not applicable. A waiver request must be submitted for any items that are neither checked

The Design Development requirements for Preservation Developments will be reviewed on an individual development basis, but the below listed requirements will apply to the greatest extent

1. A ✓ NA ☐ Electrical Systems and Equipment – Must be designed and constructed in accordance with the International Residential Code or NFPA 70 National Electrical Code as applies.

A. A ✓ NA ☐ Lighting fixtures must be shatter resistant and tamperproof. Lamps must be high efficiency design, low energy type (e.g. L.E.D. or other low energy source. Provide .5

B. A ☑ NA ☐ Provide for day/night on-off control via timers and/or photo-control. Local luminaire control is acceptable.

C. A☑ NA□ Site lighting and its ancillary install requirements must be inclusive in the within the 3. A NA NA Utility Metering – To discourage the waste of energy and to encourage conservation,

PHFA suggests individual electrical metering whenever possible. Electric bulk metering may be provided if the rate schedule justifies its use. 4. Smoke Detectors – Must be furnished and installed in the following areas: **A. A** ✓ **NA** ☐ In the areas adjacent to the sleeping area, one in each bedroom and a minimum of one

detector on each floor including the basement in multistory dwellings. Detectors must be 120 volt AC type with battery backup. Detectors are required whether the dwelling units are sprinklered or not.

B. A ✓ NA — Hearing/vision impaired units must have strobe/horn type visual signaling devices wired to the unit's smoke detectors and the building fire alarm system (if provided) and must be visible in all rooms of the dwelling unit including the bathroom(s).

C. A ✓ **NA** ☐ **Public areas** – In all public areas sprinklered or not. **D.** A ✓ NA ☐ **Storage room(s)** – In all unsprinklered storage rooms; in all storage rooms in excess of 100 SF, sprinklered or not.

E. A☑ NA□ **Mechanical and electrical rooms** – All mechanical and electrical rooms must have a smoke or heat detector, sprinklered or not. Mechanical closets in individual units are not required to have detectors unless required by code.

F. A ✓ NA ☐ Stair towers – At the top of each stair tower. **G.** A ✓ NA ☐ **Trash room** – In the trash collecting room and at the top of the trash chute.

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2.05 DEVELOPMENT SECURITY AND MAINTENANCE REQUIREMENTS CHECKLIST FOR URBAN LOCATIONS

Development Name: Northview Heights Midrise **PHFA No.:** 2023-XXX (fka 2021-156)

The undersigned certifies that all items have been provided in the drawings and/or the specifications.

Design Architect (Print or type): Kento Ohmori Design Architect (Signature):

Check the appropriate box if the development conforms to the requirement. Check \underline{A} if it is applicable or <u>NA</u> if it is not applicable. A waiver request must be submitted for any items that are neither checked nor indicated as not applicable.

1. A MA NA All developments with shared entrances (low, mid, and high rise and garden apartments) must be equipped with an apartment intercom system or equivalent security system at the main entrance(s) used by tenants and the public on a regular basis. The intercom system must not rely on a connection to the telephone service. Hearing and vision impaired units must have facilities for residents to identify and allow visitors to enter the

building without having to leave their units. 2. A NA All dwelling unit entrance doors must be equipped with a passage latch set, dead bolt lockset, knocker, viewer, and an apartment/unit identification number. 3. A NA As much as possible, the building(s) must be oriented on the site so that all parts of the site can be observed from the building(s) and from the surrounding streets. Avoid blind

corners and courtvards unless they can be secured. **4. A** ☑ **NA** ☐ Place all meters so that they are protected from vandalism and can be read from outside **5.** $A \square VA \square$ For family type developments, fence in recreational and landscaped areas with decorative

security fencing with factory applied color finish of appropriate height to prevent trespassing and vandalism. Cyclone or equal fencing with a factory applied color finish of appropriate height may be used at selective secondary areas only with PHFA approval.

6. A ☑ **NA** □ Provide "Door Ajar" alarms or, where approved by code, electromagnetic release devices for secondary or fire exit doors. **7. A** □ **NA** ☑ Where practicable, provide decorative code approved security grilles or screens for

basement and first floor windows with sills less than 60" above exterior finished grade. **8. A** ✓ **NA** ☐ Avoid through wall penetrations, (e.g., removable AC units, exhaust grilles, etc.), unless small enough to prevent entry and placed a minimum of 60" above exterior finished

9. A ☑ **NA** ☐ Masonry or equal exteriors are recommended. At a minimum, the first 8' above grade

should be masonry or equivalent strength material with "Anti-Graffiti" coating. **10. A** ₩ **NA** Minimize front and side yard setbacks facing public rights-of-way as much as possible and

to the extent allowable by code and zoning. **11. A** ✓ **NA** ☐ Provide hard surfaces for all areas where landscaping is unlikely to survive, (e.g., brick or other decorative paving for building setbacks and walks or stepping stones in areas subject to foot traffic).

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H. A ✓ NA ☐ Corridors — At the ends of each corridor leading into stair towers or dead ended. Corridor coverage shall comply with the latest edition of the International Building Code or NFPA 72, The National Fire Alarm Code.

I. A☑ NA□ Heat Detectors – Developments located in the City of Philadelphia may have additional requirements. Check with the City Code Administrator for details.

5. $A \square VA \square Elevators – Where an elevator is provided, PHFA recommends but does not require, that$ at least one be connected to an auxiliary/emergency generator power system. **6. A** ✓ **NA** ☐ **Electrical Panel Boxes** – In accessible and adaptable units, tenant electrical panels shall

be mounted with the top breaker within the accessible reach range. 7. A NA NA Accessibility Requirements – The electrical design must include the necessary features discussed in Section 1.02.

8. A☑ NA□ Telephone & TV Cable Service – Every building and every unit shall be pre-wired for telephone and TV cable service.

9. A NA Electric Resistance Heat – Electrical resistance heating shall not be allowed as the primary heat source in PHFA developments. **10. A** ☑ **NA** ☐ **Carbon Monoxide Detectors** — A carbon monoxide detector or central detector/alarm system must be installed in all dwelling units and multifamily buildings with fossil fuel

fired equipment as required by the PA Uniform Construction Code, the National Electric Code, The Pennsylvania Carbon Monoxide Alarm Standards Act of 2013 and the City of Philadelphia Carbon Monoxide Alarm Law of 2008.

11. A ✓ NA ☐ Broadband Infrastructure – Refer to Tab 8 Threshold Criteria and as amended by TAB 8 Selection Criteria. 12. A☑ NA□ Hearing and Vision Impaired Dwelling Units

> All Accessible dwelling Units must include audible and visual signaling devices for hearing/vision impaired. a hearing or vision impairment. These units shall $\underline{\mathsf{not}}$ be equipped for persons with mobility impairments, but must include the following at a minimum:

 Strobic visual signal wired to the dwelling unit smoke detectors, visible in all rooms of the dwelling unit including the bathroom. Strobic visual signal wired to the central fire alarm system (if one is required by code), visible in all rooms of the dwelling unit including the bathroom. This signal

must be distinguishable from that in paragraph "A" above. A doorbell at the dwelling exterior or corridor entrance door with a visual signaling device.

• TTY capable telephone to be provided by tenant. • In buildings with a common entrance, a means for a hearing-impaired individual to identify visitors without leaving his/her dwelling unit.

A ☑ NA ☐ Common house (non-tenant) power source in close proximity to vents for installation of

 $A \square NA \square$ An Indicator, signifying the fan is in operation, must be visible in a common area.

Note: All utilities must be individually metered in units designated for conversion to homeownership

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2.06 MECHANICAL REQUIREMENTS CHECKLIST

Check the appropriate box if the development conforms to the requirement. Check \underline{A} if it is applicable

or \underline{NA} if it is not applicable. A waiver request must be submitted for any items that are neither checked

The Design Development requirements for Preservation Developments will be reviewed on an

individual development basis, but the below listed requirements will apply to the greatest extent

Contract Documents must be complete and enforceable by the Architect/Engineer and the Agency's

1. A MA NA Shower/Tub Combinations – Every bathtub must be furnished with shower fittings. All

2. A ✓ NA Water Usage – Plumbing fixtures in dwelling units and common areas shall meet the

3. A☑ NA□ Exposed Piping and Conduit – Exposed refrigerant, power, and control wiring from

4. A ✓ NA ☐ Kitchen Exhaust — Must be provided with a combination fan and light range hood and

utilizing an ERV or HRV system with an exhaust grille in the kitchen).

6. Ventilation – Requirements of the International Building Code shall be followed for ventilation of the

covered with PVC split insulation jacket with cemented joints.

taped gypsum wallboard to eliminate air infiltration.

Program or any Energy Efficiency Program:

5. A □ **NA** ☑ **Gas Furnaces** – All gas furnaces shall be Energy Star labeled.

Toilets - 1.28 gpf

Urinals - 0.5 gpf

following areas: **A. A**□ **NA** Elevator machine rooms.

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Showerheads – 2.0 gpm

Kitchen faucets - 2.0 gpm

Lavatory faucets – 1.5 gpm

tubs and showers must have an anti-scald valve. Baths with accessible showers must

include a drain in the bathroom floor in addition to the shower. Single piece tub/shower

units must not be installed directly to studs on exterior walls but must be installed over

following water usage rates or as amended by the selection of any Green Building

building to the remote condensing unit must be protected. Piping must be bundled and

must be controlled by a separate switch and be ducted to the exterior (recirculating type

range hoods may remain in preservation developments and may be used in developments

Design Architect (Print or type): Kento Ohmori

Design Architect (Signature):

nor indicated as not applicable.

Date: 12/03/2023

Field Representative.

Development Name: Northview Heights Midrise **PHFA No.:** 2023-XXX (fka 2021-156)

205 Ross Street The undersigned certifies that all items have been provided in the drawings and/or the specifications. Pittsburgh, Pennsylvania 15219

ph 412.281.6001 fx 412.281.6002

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Fukui Architects Pc

general notes

Any conflicts in the drawings or between new and existing construction shall be referred to the Architect.

2. Contractor shall verify all dimensions and existing conditions in the field and shall advise Fukui Architects. **Pc** of any discrepancies between, additions to, deletions from, or alterations to any and all conditions prior to proceeding with any phase of work. Do not scale

3. All work shall be installed in accordance with applicable codes and regulations.

4. Contractor shall be responsible for the patching, repairing, and preparations of all existing floor, wall, and ceiling surfaces as required to receive scheduled finishes.

5. All items shown on drawings are finished construction assemblies. Contractor shall provide and install all material required for finished assemblies.

6. All reports, plans, specifications, computer files, field data, notices, and other documents and instruments prepared by the Architect as instruments of service shall remain the property of the Architect. The Architect shall retain all common law statutory, and other reserved rights, including the copyright thereto.

revisions

project title

Owner:

HACP 200 Ross Street Pittsburgh, PA, 15219

Client:

Allies & Ross Management and Development Corporation (ARMDC) 200 Ross Street Pittsburgh, PA 15219

Project Location:

Northview Heights Midrise 246 Penfort Street Pittsburgh, PA 15214


PHFA TAB 02 CHECKLISTS

As Noted December 3rd, 2023


Sheet No.

TS15


drawing title

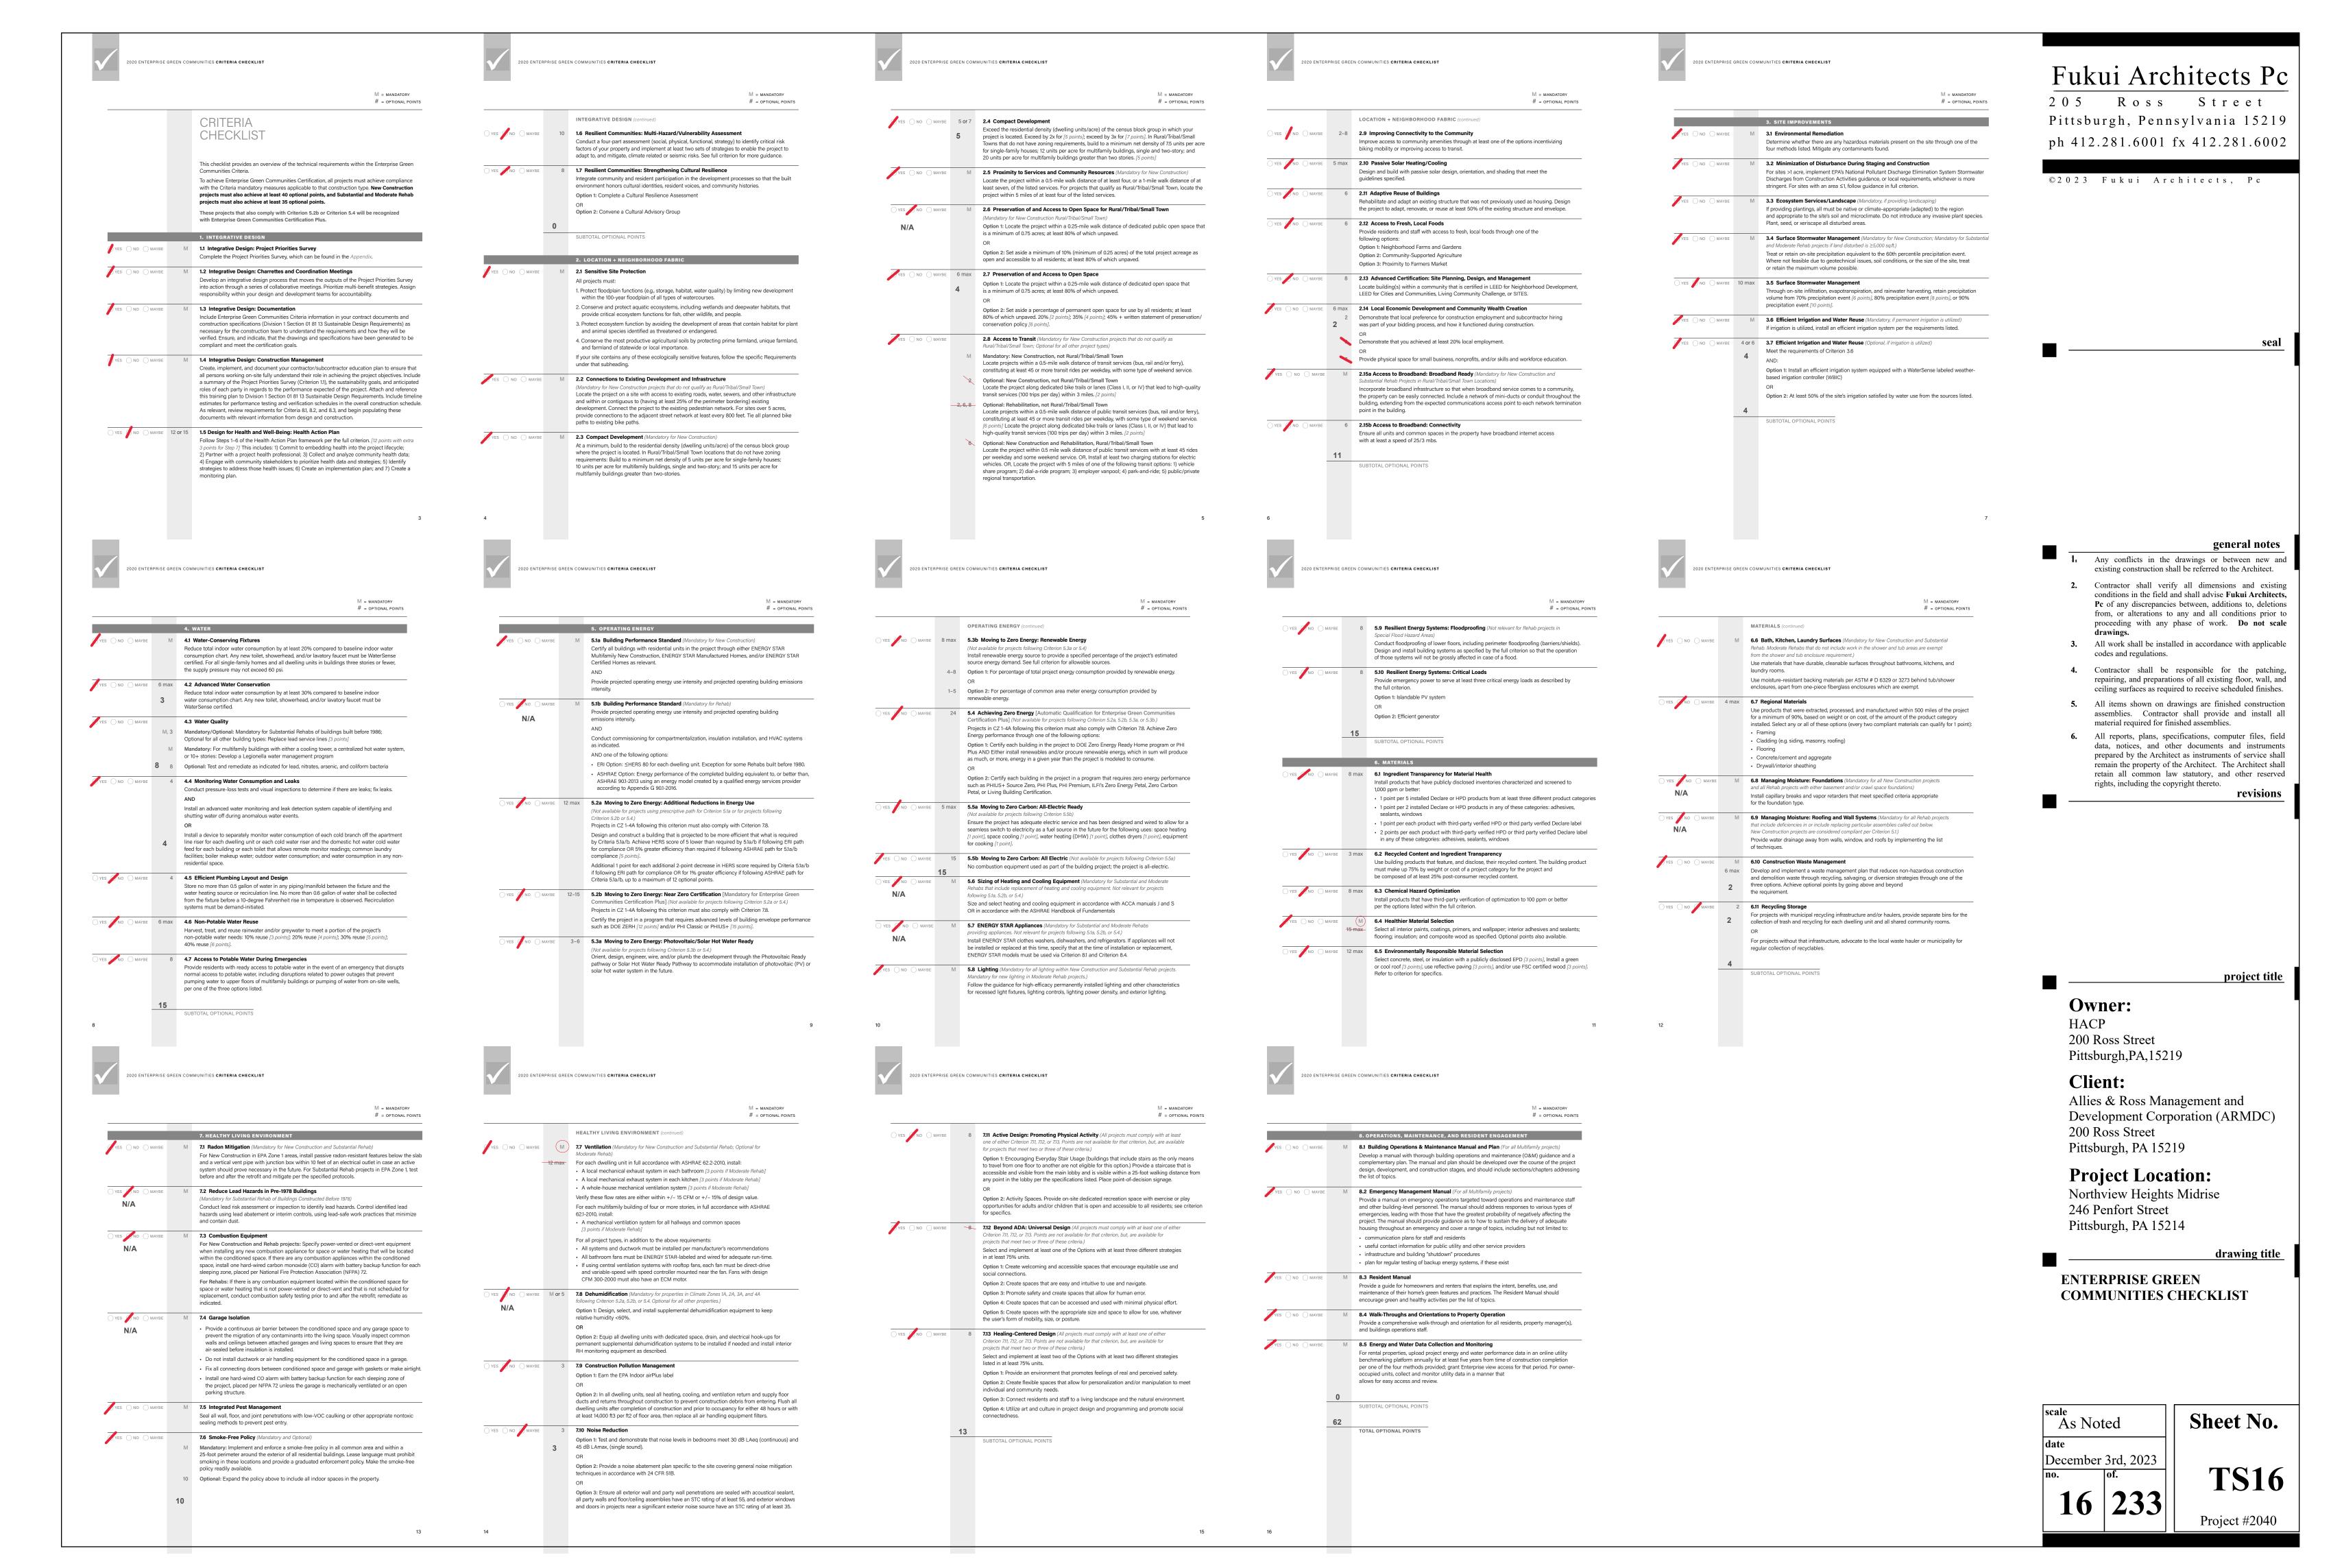

FUKUI ARCHITECTS NORTHVIEW HEIGHTS MIDRISE

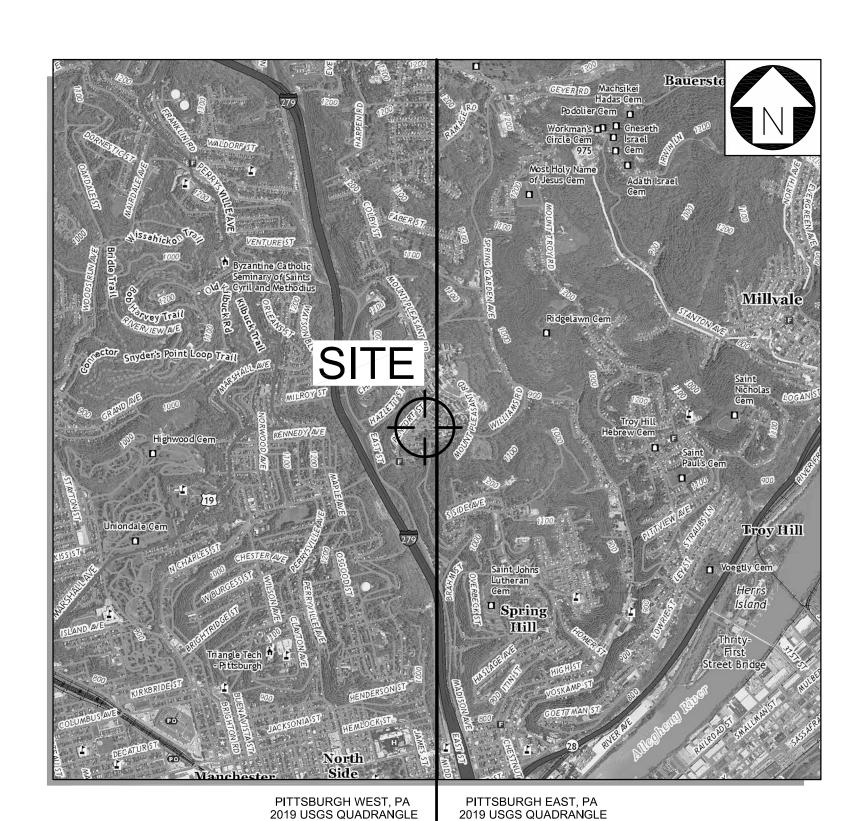

USGS VICINITY MAP SCALE: 1"=2000'

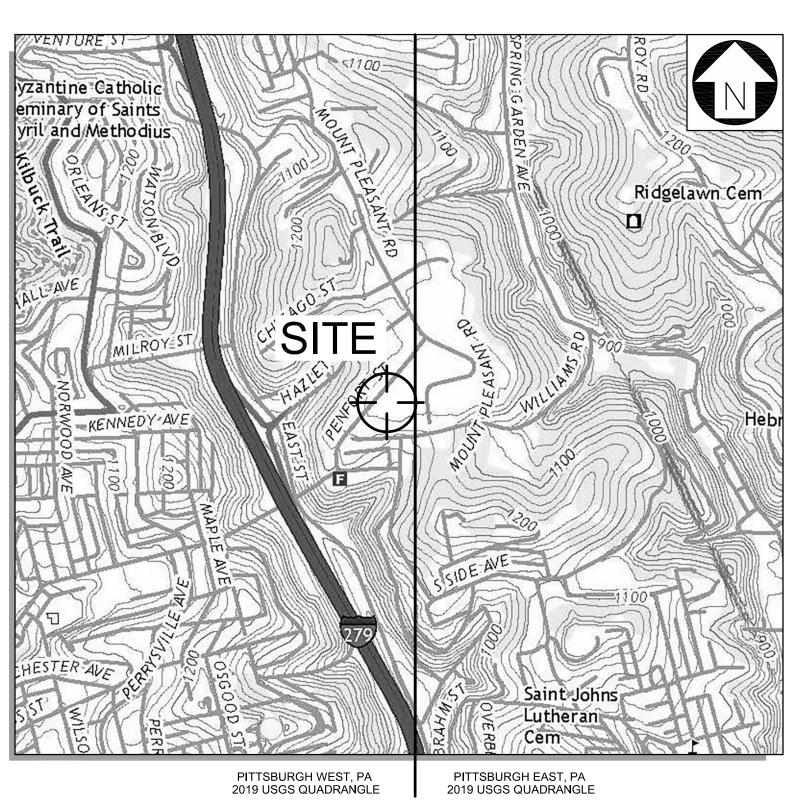

LOCAL MAP SCALE: 1"=1000'

INDEX OF SHEETS	REV.	DATE
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GENERAL NOTES	0	12/3/2023
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DEMOLITION PLAN	0	12/3/2023
SITE PLAN	0	12/3/2023
ADA ENLARGEMENT PLAN (SHEET 1 OF 2)	0	12/3/2023
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POST CONSTRUCTION STORMWATER MANAGEMENT PLAN	0	12/3/2023
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STORMWATER MANAGEMENT DETAILS (SHEET 3 OF 7)	0	12/3/2023
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STORMWATER MANAGEMENT DETAILS AND PROFILES (SHEET 5 OF 7)	0	12/3/2023
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UTILITY PLAN	0	12/3/2023
UTILITY DETAILS	0	12/3/2023
SANITARY PROFILES	0	12/3/2023
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PWSA DETAILS (SHEET 2 OF 2)	0	12/3/2023
WATER SERVICE ENLARGEMENT PLAN	0	12/3/2023
EROSION AND SEDIMENTATION CONTROL PLAN	0	12/3/2023
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LIGHTING PLAN	0	12/3/2023
LIGHTING DETAILS	0	12/3/2023

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- Any conflicts in the drawings or between new and existing construction shall be referred to the Architect.
- 2. Contractor shall verify all dimensions and existing conditions in the field and shall advise Fukui Architects, Pc of any discrepancies between, additions to, deletions from, or alterations to any and all conditions prior to proceeding with any phase of work. Do not scale
- 3. All work shall be installed in accordance with applicable codes and regulations.
- 4. Contractor shall be responsible for the patching, repairing and preparations of all existing floor, wall, and ceiling surfaces as required to receive scheduled finishes.
- 5. All items shown on drawings are finished construction assemblies. Contractor shall provide and install all material required for finished assemblies.
- 6. All reports, plans, specifications, computer files, field data, notices, and other documents and instruments prepared by the Architect as instruments of service shall remain the property of the Architect. The Architect shall retain all common law statutory, and other reserved rights, including the copyright thereto.

project title

Owner:

HACP 200 Ross Street Pittsburgh,PA,15219

Client:

Allies & Ross Management and Development Corporation (ARMDC) 200 Ross Street Pittsburgh, PA 15219

Project Location:

Northview Heights Midrise 246 Penfort Street Pittsburgh, PA 15214

drawing title

TITLE SHEET

HOUSING AUTHORITY CITY OF PITTSBURGH 200 ROSS STREET

LAND OWNER/DEVELOPER

9TH FLOOR PITTSBURGH, PA 15219 PHONE: (412) 456-5020 CONTACT: JEROME FRANK, AIA PROJECT ENGINEER

RED SWING CONSULTING SERVICES, LLC 4314 OLD WILLIAM PENN HWY, SUITE 101 MONROEVILLE, PA 15146 PHONE: (724) 325–1215 CONTACT: MATTHEW SMITH, P.E.

ARCHITECT FUKUI ARCHITECTS PC 205 ROSS STREET PITTSBURGH, PA 15219 PHONE: (412) 281-9607 CONTACT: KENTO OHMORI, AIA

SURVEYOR SCI-TEK CONSULTANTS, INC. 665 RODI ROAD PITTSBURGH, PA 15235 PHONE: (412) 371-4460

CONTACT: JEREMY R. GATTEN

NUMBER

C100 C101

C103

C200

C201

C202

C203

C204

C250

C300

C301

C400

C450

C451

C452

C453

C454

C500

C551 C552 C553 C554 C600 C650 C651 C652 C701 C750

GENERAL NOTE

THESE DRAWINGS MAY NOT SHOW ALL UNDERGROUND PIPING AND UTILITIES. THE CONTRACTOR SHALL EXERCISE EXTREME CARE DURING ALL EXCAVATION AND OTHER CONSTRUCTION ACTIVITIES.

REVIEW / PRELIMINARY

CONSTRUCTION

APPROVALS / PERMITTING

DO NOT SCALE DRAWINGS

CONTRACTOR SHALL VERIFY ALL PLANS, EXISTING DIMENSIONS. CONDITIONS ON THE JOB SITE & SHALL IMMEDIATELY NOTIFY THE ENGINEER IN WRITING OF ANY DISCREPANCIES BEFORE PROCEEDING WITH THE WORK OR BE RESPONSIBLE FOR SAME

As Noted December 3rd, 2023

C100 Project #2040



STANDARD GENERAL NOTES:

- 1. THE CONTRACTOR AGREES THAT IN ACCORDANCE WITH GENERALLY ACCEPTED CONSTRUCTION PRACTICES, THE CONTRACTOR SHALL BE REQUIRED TO ASSUME SOLE RESPONSIBILITY FOR JOB SAFETY OF PERSONS AND PROPERTY.
- 2. IT IS THE RESPONSIBILITY OF THE CONTRACTOR TO OBTAIN PERMITS NECESSARY TO PERFORM THE WORK SHOWN IN THESE PLANS FROM THE APPROPRIATE AGENCIES.
- 3. CONTRACTOR IS REQUIRED TO COMPLY WITH APPLICABLE CODES, ORDINANCES, RESOLUTIONS, POLICIES, AND PROCEDURES. IN GENERAL.
- 4. CONTRACTOR SHALL COMPLY WITH OSHA REGULATIONS.
- 5. CONTRACTOR SHALL PROVIDE LIGHTS, SIGNS, BARRICADES, FLAGGERS OR OTHER DEVICES NECESSARY TO PROVIDE SAFETY.
- 6. THE CONTRACTOR SHALL RESTORE PUBLIC OR PRIVATE PROPERTY DAMAGED OR REMOVED TO IT'S ORIGINAL CONDITION, AS DETERMINED BY THE OWNER OR OWNER'S REPRESENTATIVE.
- 7. THE CONTRACTOR SHALL REMOVE SUBSURFACE OBSTRUCTIONS OR ABANDONED UTILITY LINES WITHIN THE DEMOLITION AREA AS PART OF THIS PROJECT.
- 8. <u>WARNING</u>: THE PLANS SHOW SOME KNOWN SUBSURFACE STRUCTURES, ABOVE GROUND STRUCTURES AND/OR UTILITIES BELIEVED TO EXIST IN THE LOCATIONS INDICATED. THE CONTRACTOR IS RESPONSIBLE TO VERIFY THE EXACT LOCATIONS OF SUCH PIPELINES, SUBSURFACE STRUCTURES AND/OR UTILITIES, AND TO PROCEED WITH GREAT CARE IN EXECUTING WORK. 72 HOURS BEFORE YOU DIG, DRILL OR BLAST, CALL 1-800-242-1776.
- 9. THE CONTRACTOR IS RESPONSIBLE FOR MAINTAINING A NEAT AND ORDERLY SITE, YARD AND GROUNDS. REMOVE AND PROPERLY DISPOSE, OFF SITE, RUBBISH, WASTE MATERIALS, LITTER, AND OTHER FOREIGN SUBSTANCES. REMOVE PETROCHEMICAL SPILLS, STAINS AND OTHER FOREIGN DEPOSITS. RAKE GROUNDS TO A SMOOTH EVEN—TEXTURED SURFACE.
- 10. IT IS THE CONTRACTOR'S RESPONSIBILITY TO EXAMINE PLAN SHEETS AND SPECIFICATIONS AND COORDINATE HIS WORK WITH OTHER CONTRACTORS TO ENSURE THAT WORK PROGRESSION IS NOT INTERRUPTED.
- 11. THE CONTRACTOR IS INSTRUCTED TO COOPERATE WITH OTHER CONTRACTORS PERFORMING WORK ON THE JOB SITE DURING THE PERFORMANCE OF THIS CONTRACT.
- 12. THE CONTRACTOR IS REQUIRED TO HAVE COPIES OF PERMITS AND PLANS ON SITE DURING CONSTRUCTION.
- 13. CONTRACTOR SHALL VERIFY PLANS & EXISTING DIMENSIONS & CONDITIONS ON THE JOB SITE & SHALL IMMEDIATELY NOTIFY THE ENGINEER IN WRITING OF DISCREPANCIES BEFORE PROCEEDING WITH THE WORK OR BE RESPONSIBLE FOR SAME.
- 14. THE OWNER OR THE OWNER'S REPRESENTATIVE SHALL BE NOTIFIED IN WRITING OF CONDITIONS THAT VARY FROM THOSE SHOWN ON THE PLANS. THE CONTRACTORS WORK SHALL NOT VARY FROM THE PLANS WITHOUT THE EXPRESSED WRITTEN APPROVAL OF THE OWNER OR THE OWNER'S REPRESENTATIVE.
- 15. THE CONTRACTOR SHALL PROTECT EXISTING PROPERTY LINE MONUMENTATION. ANY MONUMENTATION DISTURBED OR DESTROYED, AS JUDGED BY THE OWNER OR THE OWNER'S REPRESENTATIVE, SHALL BE REPLACED AT THE CONTRACTORS EXPENSE UNDER THE SUPERVISION OF A LICENSED LAND SURVEYOR.
- 16. THE CONTRACTOR SHALL BE RESPONSIBLE FOR DEWATERING AND THE MAINTENANCE OF SURFACE DRAINAGE DURING THE COURSE OF WORK.
- 17. THE CONTRACTOR SHALL TAKE EFFECTIVE ACTION TO PREVENT THE FORMATION OF AN AIRBORNE DUST NUISANCE AND SHALL BE RESPONSIBLE FOR ANY DAMAGE RESULTING FROM FAILURE TO DO SO.
- 18. EXCAVATIONS SHALL BE ADEQUATELY SHORED, BRACED, AND SHEETED SO THAT THE EARTH WILL NOT SLIDE OR SETTLE AND SO THAT EXISTING IMPROVEMENTS WILL BE PROTECTED FROM DAMAGE. WHERE THE EXCAVATION FOR A CONDUIT TRENCH AND/OR STRUCTURE IS FOUR FEET OR MORE IN DEPTH, ADEQUATE METHODS FOR PROTECTION OF WORKERS IS REQUIRED.
- 19. STATIONING HEREIN IS ALONG STREET CENTERLINE UNLESS OTHERWISE SHOWN OR INDICATED.
- 20. RETURN RADII AND CURB DATA ARE MEASURED TO BACK OF WEDGE CURB, AND TO THE FRONT FACE OF CONCRETE CURB UNLESS OTHERWISE NOTED.
- 21. UTILITY WORK INVOLVING CONNECTIONS TO EXISTING SYSTEMS SHALL BE COORDINATED WITH THE OWNER OR THE OWNER'S REPRESENTATIVE AND THE UTILITY OWNER. NOTIFY THE OWNER OR THE OWNER'S REPRESENTATIVE AND THE UTILITY OWNER BEFORE EACH AND EVERY CONNECTION TO THE EXISTING SYSTEM IS MADE.
- 22. EXISTING UTILITIES AND IMPROVEMENTS THAT BECOME DAMAGED DURING CONSTRUCTION SHALL BE COMPLETELY RESTORED TO THE SATISFACTION OF THE LOCAL ENGINEER, AT THE CONTRACTOR'S SOLE EXPENSE.
- 23. LENGTHS AND PERCENT SLOPE OF SANITARY SEWERS AND STORM DRAINS, AS WELL AS POTENTIAL CONFLICTS MUST BE VERIFIED BY THE CONTRACTOR PRIOR TO CONSTRUCTING SUCH ENTITIES.
- 24. IF ARCHEOLOGICAL MATERIALS ARE UNCOVERED DURING GRADING, TRENCHING OR OTHER EXCAVATION, EARTHWORK SHALL BE STOPPED UNTIL A PROFESSIONAL ARCHEOLOGIST HAS HAD AN OPPORTUNITY TO EVALUATE THE SIGNIFICANCE OF THE FIND AND SUGGEST APPROPRIATE MITIGATION MEASURES, IF THEY ARE DEEMED NECESSARY.
- 25. CONTRACTOR SHALL PROVIDE TRAFFIC MAINTENANCE AND PROTECTION AS PER PADOT PUBLICATION 203.

GENERAL NOTES:

- A. IF TOPOGRAPHIC BOUNDARY SURVEY, INCLUDING PROPERTY LINES, LEGAL DESCRIPTION, EXISTING UTILITIES, SITE TOPOGRAPHY WITH SPOT ELEVATIONS, OUTSTANDING PHYSICAL FEATURES AND EXISTING STRUCTURE LOCATIONS WAS COMPLETED BY OTHERS. RED SWING CONSULTING SERVICES, LLC WILL NOT BE HELD RESPONSIBLE FOR THE ACCURACY OF THE SURVEY OR FOR DESIGN ERRORS OR OMISSIONS RESULTING FROM SURVEY INACCURACIES.
- B. PHASES OF SITE WORK FOR THIS PROJECT SHALL MEET OR EXCEED THE OWNER/DEVELOPER SITE WORK SPECIFICATIONS.
- C. CONTRACTOR SHALL BE RESPONSIBLE FOR RAZING AND REMOVAL OF THE EXISTING STRUCTURES, RELATED UTILITIES, PAVING, UNDERGROUND STORAGE TANKS AND OTHER EXISTING IMPROVEMENTS AS NOTED.
- D. CONTRACTOR IS TO REMOVE AND DISPOSE OF DEBRIS, RUBBISH AND OTHER MATERIALS RESULTING FROM PREVIOUS AND CURRENT DEMOLITION OPERATIONS. DISPOSAL WILL BE IN ACCORDANCE WITH LOCAL, STATE AND/OR FEDERAL REGULATIONS GOVERNING SUCH OPERATIONS.
- E. THE GENERAL CONTRACTOR WILL BE HELD SOLELY RESPONSIBLE FOR AND SHALL TAKE ALL PRECAUTIONS NECESSARY TO AVOID PROPERTY DAMAGE TO ADJACENT PROPERTIES DURING THE CONSTRUCTION PHASES OF THIS PROJECT.
- F. SAFETY NOTICE TO CONTRACTOR: IN ACCORDANCE WITH GENERALLY ACCEPTED CONSTRUCTION PRACTICES, THE CONTRACTOR SHALL BE SOLELY AND COMPLETELY RESPONSIBLE FOR CONDITIONS OF THE JOB SITE, INCLUDING SAFETY OF PERSONS AND PROPERTY DURING PERFORMANCE OF THE WORK. THIS REQUIREMENT WILL APPLY CONTINUOUSLY AND NOT BE LIMITED TO NORMAL WORKING HOURS. CONSTRUCTION OBSERVATION BY THE ENGINEER OF THE CONTRACTOR'S PERFORMANCE IS NOT INTENDED TO INCLUDE REVIEW OF THE ADEQUACY OF THE CONTRACTOR'S SAFETY MEASURES, IN, ON OR NEAR THE CONSTRUCTION SITE.
- G. CONSTRUCTION IN STATE HIGHWAY DEPARTMENT RIGHT—OF—WAY SHALL BE COORDINATED WITH THE PENNSYLVANIA D.O.T. OFFICE.

MANAGEMENT OF FILL DUE DILIGENCE DEP DOC.# 258-2182-773

ENVIRONMENTAL DUE DILIGENCE — INVESTIGATIVE TECHNIQUES, INCLUDING, BUT NOT LIMITED TO, VISUAL PROPERTY INSPECTIONS, ELECTRONIC DATA BASE SEARCHES, REVIEW OF OWNERSHIP AND USE HISTORY OF PROPERTY, SANBORN MAPS, ENVIRONMENTAL QUESTIONNAIRES, TRANSACTION SCREENS, ANALYTICAL TESTING, ENVIRONMENTAL ASSESSMENTS OR AUDITS.

CLEAN FILL — UNCONTAMINATED, NONWATER—SOLUBLE, NONDECOMPOSIBLE INERT SOLID MATERIAL. THE TERM INCLUDES SOIL, ROCK, STONE, DREDGED MATERIAL, USED ASPHALT, AND BRICK, BLOCK OR CONCRETE FROM CONSTRUCTION AND DEMOLITION ACTIVITIES THAT IS SEPARATE FROM OTHER WASTE AND RECOGNIZABLE AS SUCH. (25 PA. CODE §§ 271.101 AND 287.101) THE TERM DOES NOT INCLUDE MATERIALS PLACED IN OR ON THE WATERS OF THE COMMONWEALTH UNLESS OTHERWISE AUTHORIZED.

SITE CONTRACTOR IS RESPONSIBLE FOR FOLLOWING THE TECHNICAL GUIDANCE AS PUT FORTH IN THE MANAGEMENT OF FILL DOCUMENT #258-2182-773 (LATEST REV.), IN ORDER TO DETERMINE IF THE FILL TO BE USED CLASSIFIES AS CLEAN OR REGULATED FILL AND HOW THAT FILL CAN BE USED.

GENERAL UTILITY NOTES:

- 1. LENGTHS AND PERCENT SLOPE OF SANITARY SEWERS AND STORM DRAINS, AS WELL AS POTENTIAL CONFLICTS MUST BE VERIFIED BY THE CONTRACTOR PRIOR TO CONSTRUCTING SUCH ENTITIES.
- 2. UTILITIES SHALL BE INSTALLED, DISCONNECTED, AND/OR RELOCATED IN ACCORDANCE WITH THE CODES AND SPECIFICATIONS OF THAT UTILITY AUTHORITY.
- 3. CONTRACTOR SHALL BE RESPONSIBLE FOR FEES ASSOCIATED WITH INSTALLATION AND INSPECTION OF UTILITY UNLESS OTHER ARRANGEMENTS ARE MADE WITH OWNER.
- 4. CONTRACTOR SHALL COORDINATE WITH APPROPRIATE UTILITY COMPANIES PRIOR TO LOCATION, RELOCATION, REMOVAL AND/OR INSTALLATION OF SITE UTILITIES.
- 5. PLUMBING CONTRACTOR SHALL CONTACT LOCAL HEALTH DEPARTMENT CONCERNING FILING OF UTILITY PLAN, AND PAYMENT OF FEES RELATED TO WATER AND SANITARY SEWER LINE CONSTRUCTION.
- 6. CONTRACTOR SHALL ADJUST FRAMES AND GRATES FOR EXISTING INLETS, MANHOLES, AND VALVES TO REMAIN.
- 7. UTILITY LINES REQUIRING TESTING SHALL BE TESTED IN ACCORDANCE WITH THE UTILITY COMPANY CODES AND SPECIFICATIONS.
- 8. CONTRACTOR SHALL REFER TO OTHER PLANS WITHIN THIS CONSTRUCTION SET FOR OTHER PERTINENT INFORMATION.
- 9. UTILITY WORK INVOLVING CONNECTIONS TO EXISTING SYSTEMS SHALL BE COORDINATED WITH THE OWNER OR THE OWNER'S REPRESENTATIVE AND THE UTILITY OWNER. NOTIFY THE OWNER OR THE OWNER'S REPRESENTATIVE AND THE UTILITY OWNER BEFORE EACH AND EVERY CONNECTION TO THE EXISTING SYSTEM IS MADE.
- 10. EXISTING UTILITIES AND IMPROVEMENTS THAT BECOME DAMAGED DURING CONSTRUCTION SHALL BE COMPLETELY RESTORED TO THE SATISFACTION OF THE UTILITY COMPANY, AT THE CONTRACTOR'S SOLE EXPENSE.

CONTACT LIST:

PROJECT ENGINEER

RED SWING CONSULTING SERVICES, LLC 4314 OLD WILLIAM PENN HWY, SUITE 101 MONROEVILLE, PA 15146 PHONE: (724) 325–1215 CONTACT: MATTHEW SMITH, P.E.

SURVEYOR

SCI-TEK CONSULTANTS, INC.
665 RODI ROAD
PITTSBURGH, PA 15235
PHONE: (412) 371-4460
CONTACT: JEREMY R. GATTEN

LAND OWNER/DEVELOPER

HOUSING AUTHORITY CITY OF PITTSBURGH 200 ROSS STREET 9TH FLOOR PITTSBURGH, PA 15219 PHONE: (412) 456-5020 CONTACT: JEROME FRANK, AIA

<u>ARCHITECT</u>

FUKUI ARCHITECTS PC 205 ROSS STREET PITTSBURGH, PA 15219 PHONE: (412) 281–9607 CONTACT: KENTO OHMORI, AIA

Fukui Architects Pc

205 Ross Street
Pittsburgh, Pennsylvania 15219
ph 412.281.6001 fx 412.281.6002

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P POFE S S IN THE

general notes

- Any conflicts in the drawings or between new and existing construction shall be referred to the Architect.
- 2. Contractor shall verify all dimensions and existing conditions in the field and shall advise Fukui Architects, Pc of any discrepancies between, additions to, deletions from, or alterations to any and all conditions prior to proceeding with any phase of work. Do not scale
- **3.** All work shall be installed in accordance with applicable codes and regulations.
- 4. Contractor shall be responsible for the patching, repairing, and preparations of all existing floor, wall, and ceiling surfaces as required to receive scheduled finishes.
- 5. All items shown on drawings are finished construction assemblies. Contractor shall provide and install all material required for finished assemblies.
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revisions

project title

Owner:

HACP 200 Ross Street Pittsburgh,PA,15219

Client:

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Project Location:

Northview Heights Midrise 246 Penfort Street Pittsburgh, PA 15214

drawing title

GENERAL NOTES

As Noted


date


December 3rd, 2023

December 3rd, 2023

no. of. 18 233

C101Project #2040

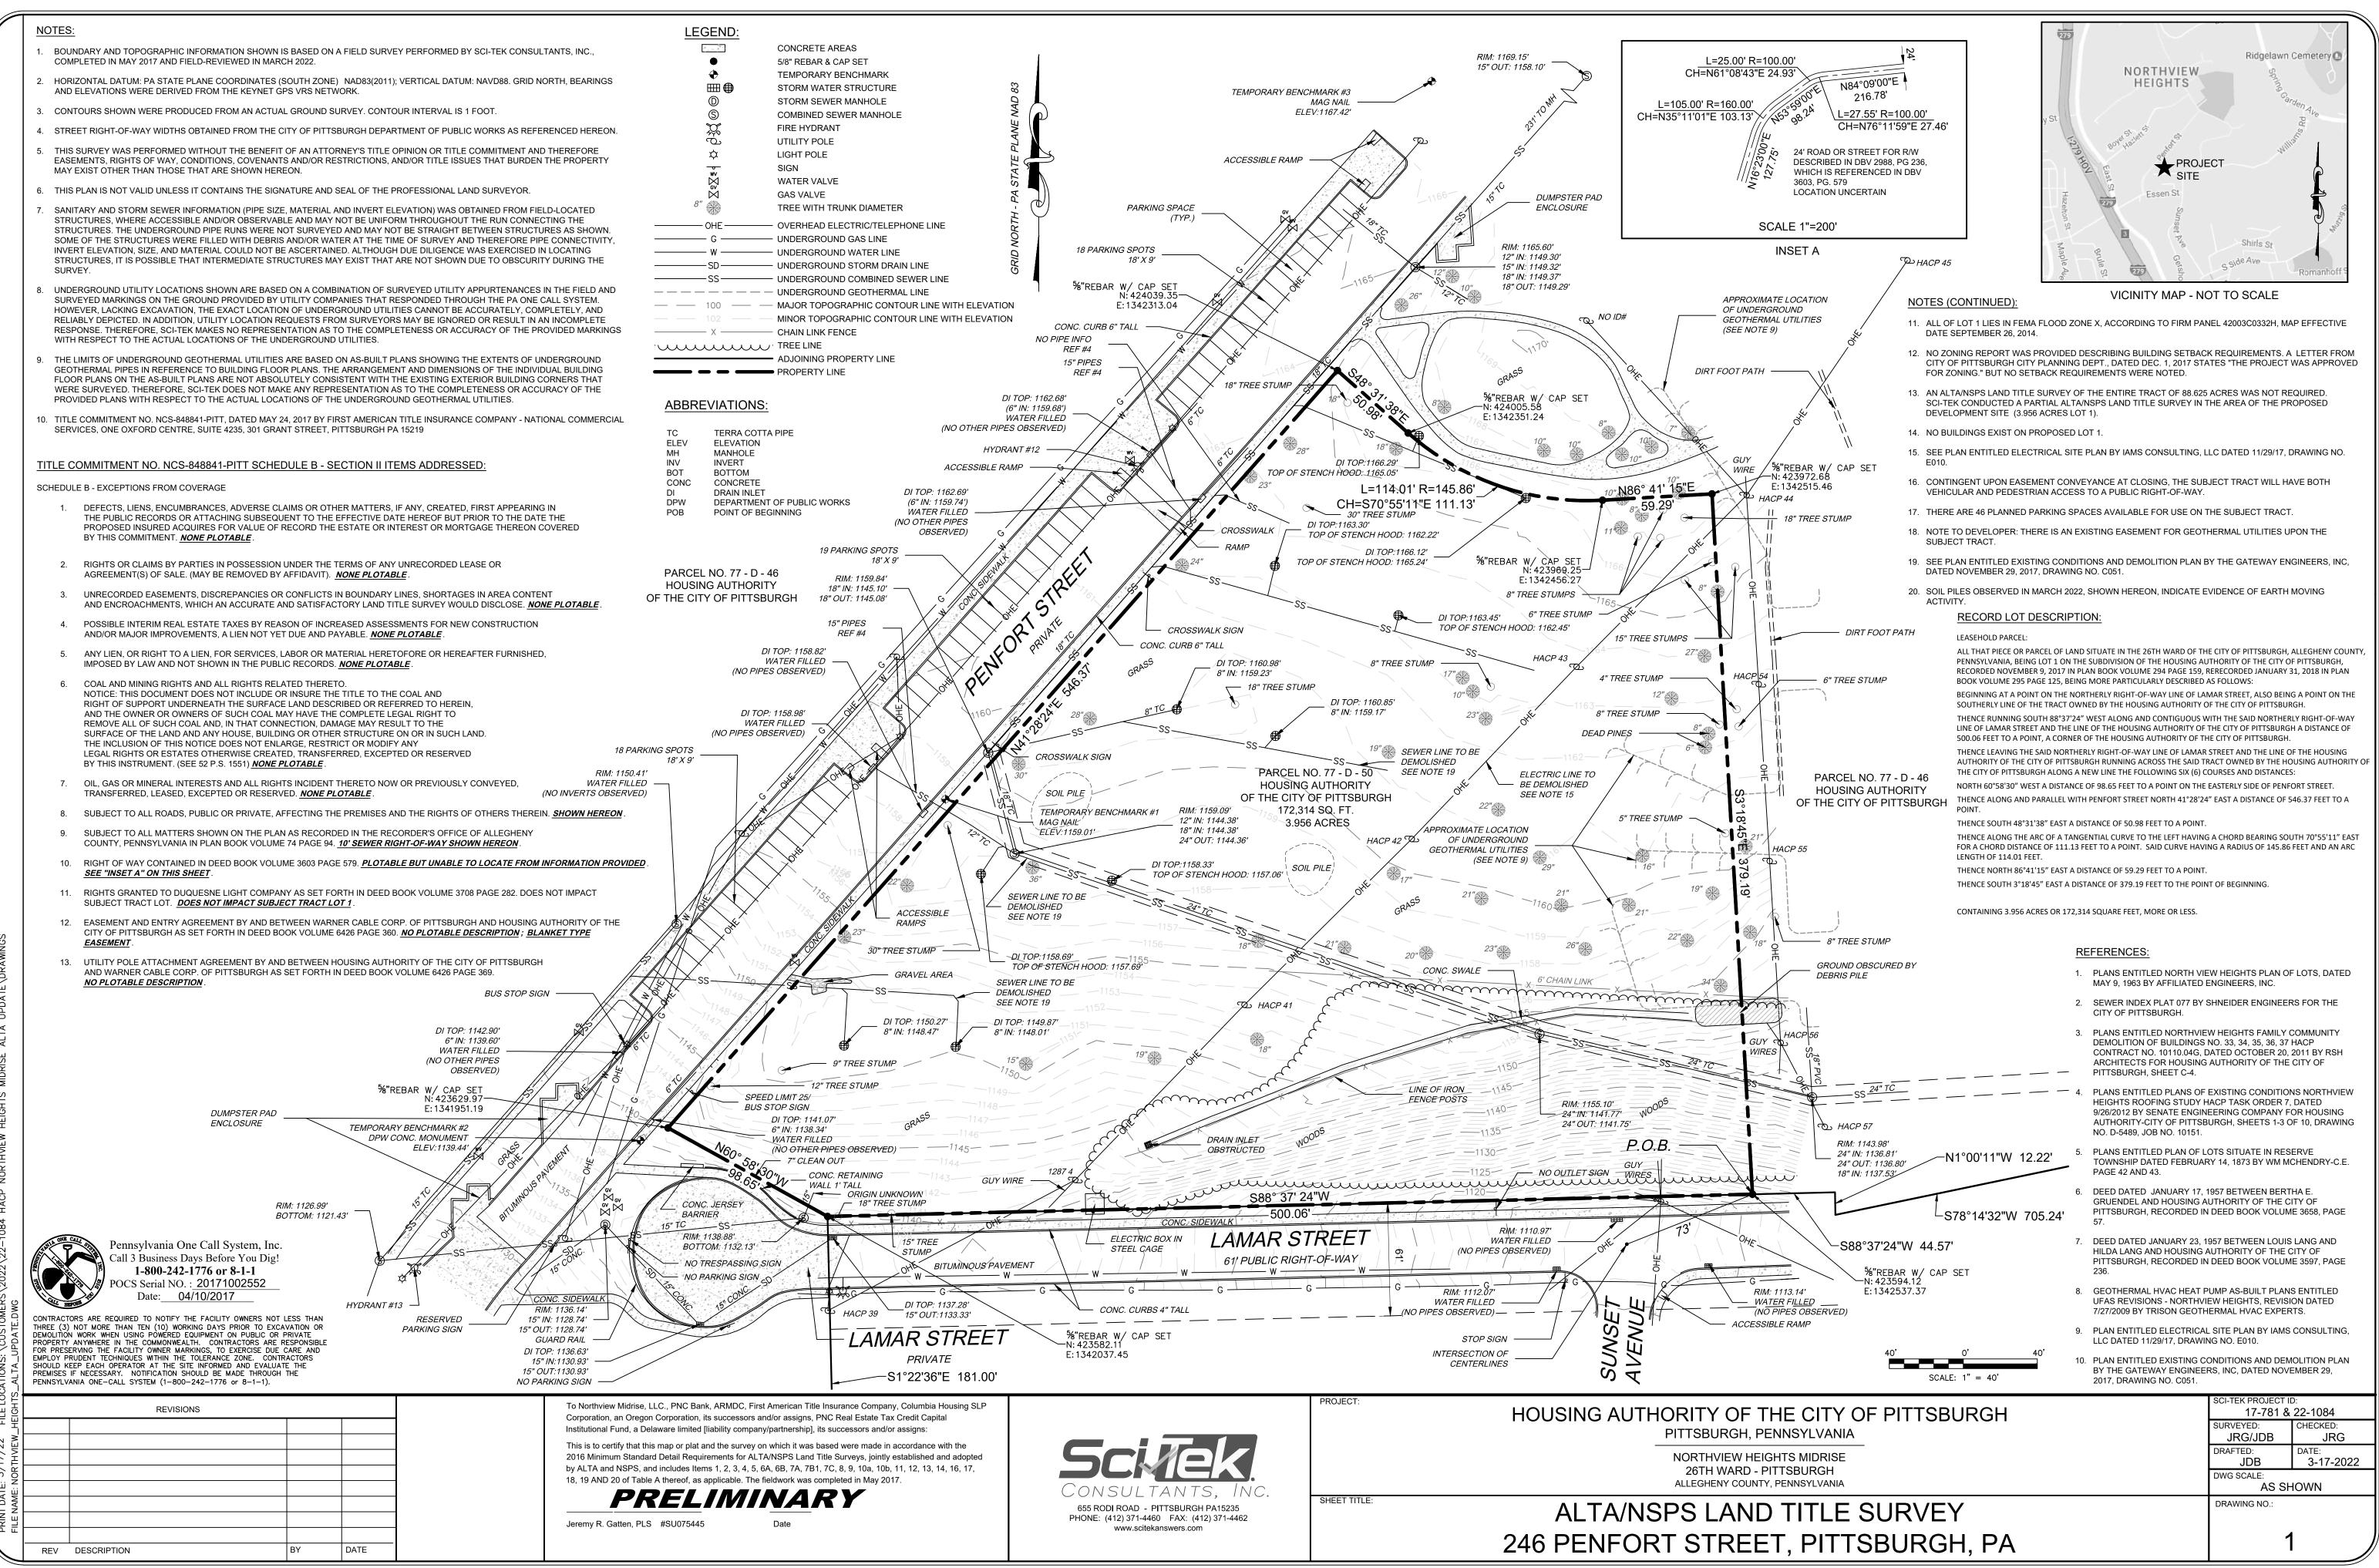

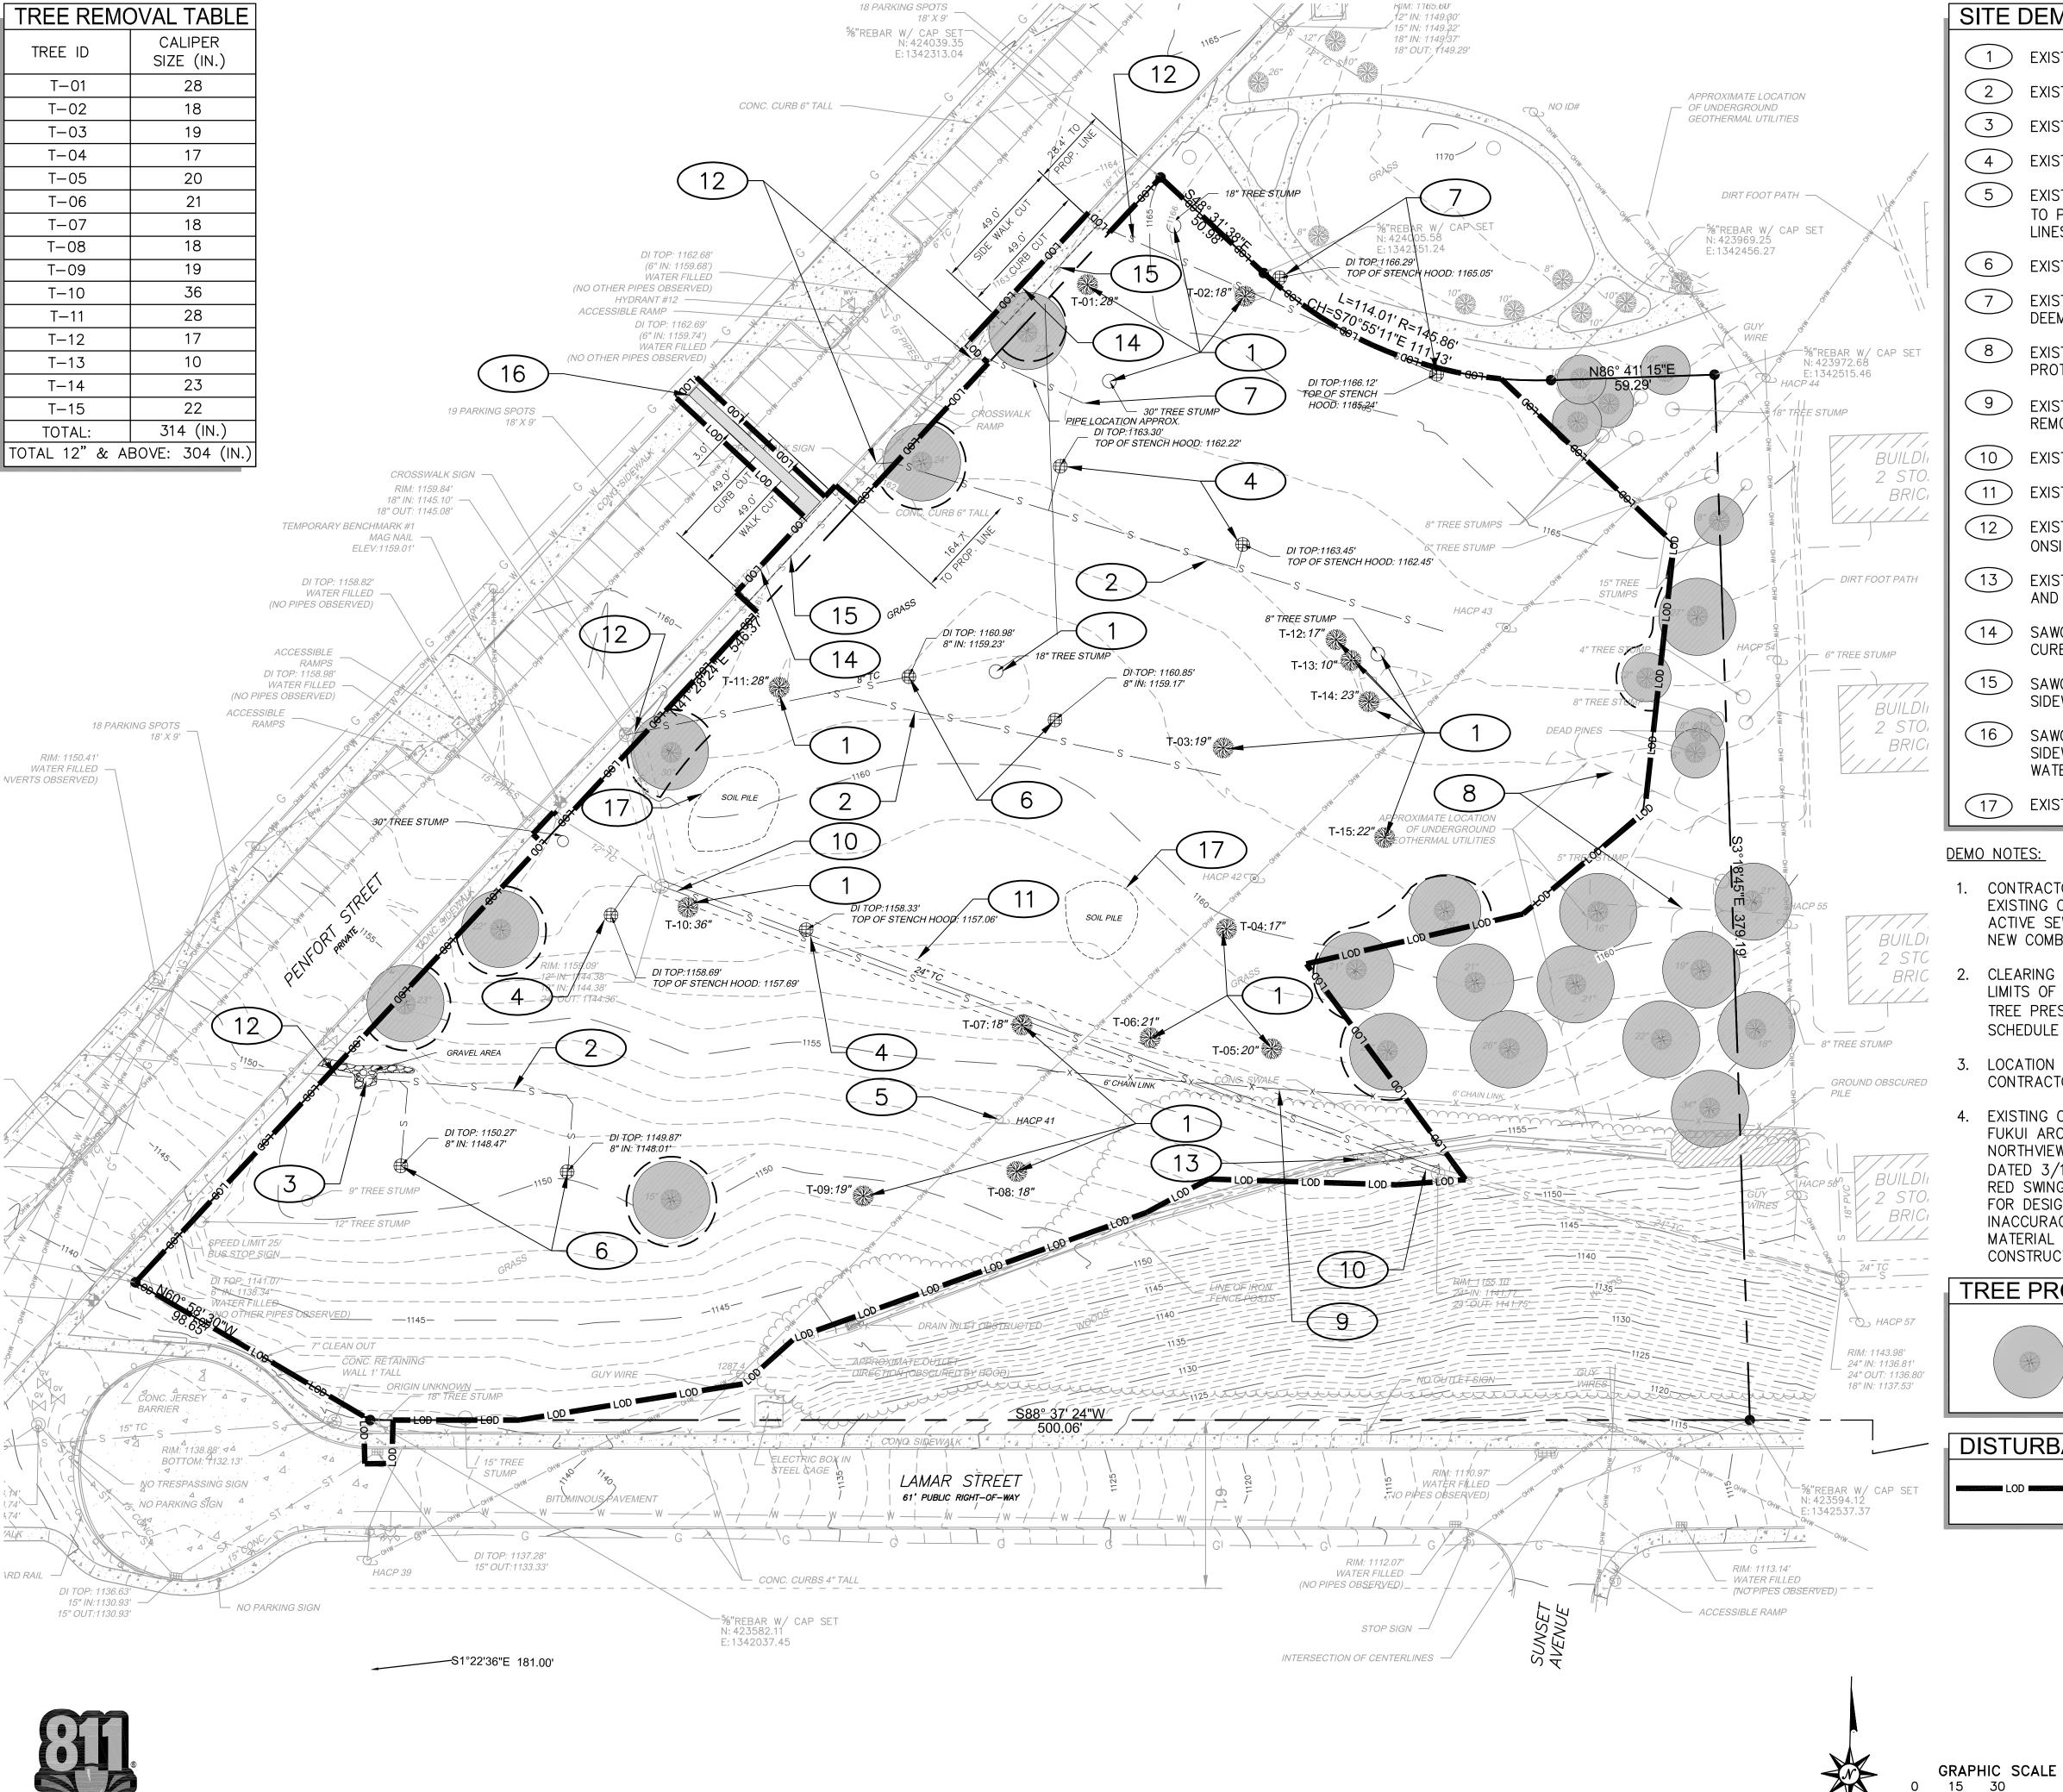

SITE DEMOLITION NOTES

- EXISTING TREE AND OR STUMP TO BE REMOVED. (TYP.)
- EXISTING SEWER LINE TO BE REMOVED.
- EXISTING GRAVEL AREA TO BE REMOVED.
- EXISTING STENCH HOOD TO BE REMOVED.
- EXISTING UTILITY POLE TO BE EXTENDED OR REPLACED TO PROVIDE 15' CLEARANCE UNDERNEATH OVERHEAD
- EXISTING SANITARY STRUCTURE TO BE REMOVED.
- EXISTING UNREFERENCED PIPE TO BE REMOVED IF DEEMED NECESSARY BY CONTRACTOR.
- EXISTING UNDERGROUND GEOTHERMAL UTILITIES TO BE PROTECTED.
- EXISTING FENCE AND POST/FOUNDATIONS TO BE
- EXISTING SANITARY LINE TO BE RE-ROUTED.
- EXISTING EASEMENT TO BE REVISED.
- EXISTING SANITARY LINE TO BE GROUTED AND CAPPED ONSITE (BEFORE R.O.W)
- EXISTING LIMITS OF CONCRETE SWALE TO BE SAWCUT AND REPLACED TO MATCH.
- SAWCUT AND REMOVE PORTION OF EXISTING CONCRETE
- SAWCUT AND REMOVE PORTION OF EXISTING CONCRETE SIDEWALK.
- SAWCUT AND REMOVE PORTION OF EXISTING CONCRETE SIDEWALK, CURB AND EXISTING STREET PAVEMENT FOR WATER LINE TRENCH.
 - EXISTING DEBRIS PILE TO BE REMOVED.

- CONTRACTOR TO INSTALL NEW COMBINATION SEWER FROM EXISTING CB1 TO EXISTING CB2 PRIOR TO REMOVING EXISTING ACTIVE SEWER LINES. SEE UTILITY PLANS SHEET C500 FOR NEW COMBINATION SEWER ROUTING.
- 2. CLEARING AND GRUBBING SHALL ONLY OCCUR WITHIN OF THE LIMITS OF DISTURBANCE. REFER TO LANDSCAPE PLANS FOR TREE PRESERVATION (SHEET LO.01) AND TREE REPLACEMENT SCHEDULE (SHEET 5.00)
- 3. LOCATION OF EXISTING UTILITIES PROVIDED BY OTHERS. CONTRACTOR TO VERIFY ALL UTILITY LOCATION AND SIZES.
- 4. EXISTING CONDITIONS SHOWN HEREIN WERE OBTAINED FROM FUKUI ARCHITECTS AS PROVIDED IN DWG FILE TITLED NORTHVIEW_HEIGHTS_ALTA_UPDATE-DRAFT 2022-3-17 AND DATED 3/17/2022 BASED ON SURVEY PERFORMED BY SCI-TEK. RED SWING CONSULTING SERVICES, LLC IS NOT RESPONSIBLE FOR DESIGN ERRORS OR OMISSIONS RESULTING FROM SURVEY INACCURACIES. CONTRACTOR TO VERIFY ALL QUANTITIES, MATERIAL TYPES AND SIZES AS NECESSARY FOR BIDDING AND CONSTRUCTION.

TREE PROTECTION LEGEND



EXISTING TREES TO BE PROTECTED (TYP.)

DISTURBANCE LEGEND

(IN FEET)

1 inch = 30 ft.


LIMITS OF DISTURBANCE

Fukui Architects Pc


205 Ross Street

Pittsburgh, Pennsylvania 15219

ph 412.281.6001 fx 412.281.6002

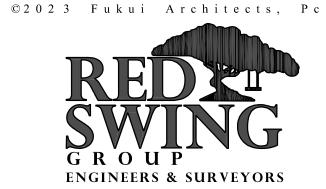

4314 OLD WILLIAM PENN HWY SUITE 101 MONROEVILLE, PA 15146 OFFICE: 724.325.1215

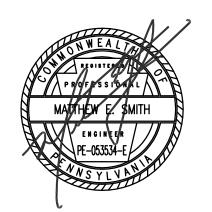

general notes

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- 3. All work shall be installed in accordance with applicable codes and regulations.
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DEMOLITION PLAN


CALL BEFORE YOU DIG! PENNSYLVANIA LAW REQUIRES 3 WORKING DAYS NOTICE FOR CONSTRUCTION PHASE AND 10 WORKING DAYS NOTICE IN DESIGN STAGE.

Sheet No. As Noted December 3rd, 2023

C103 Project #2040

20 | 233 STOP CALL PENNSYLVANIA ONE CALL SYSTEM, INC. 1-800-242-1776

Know what's below. Call before you dig. PA ONE CALL SERIAL No. 20212440672 AS PER CALL

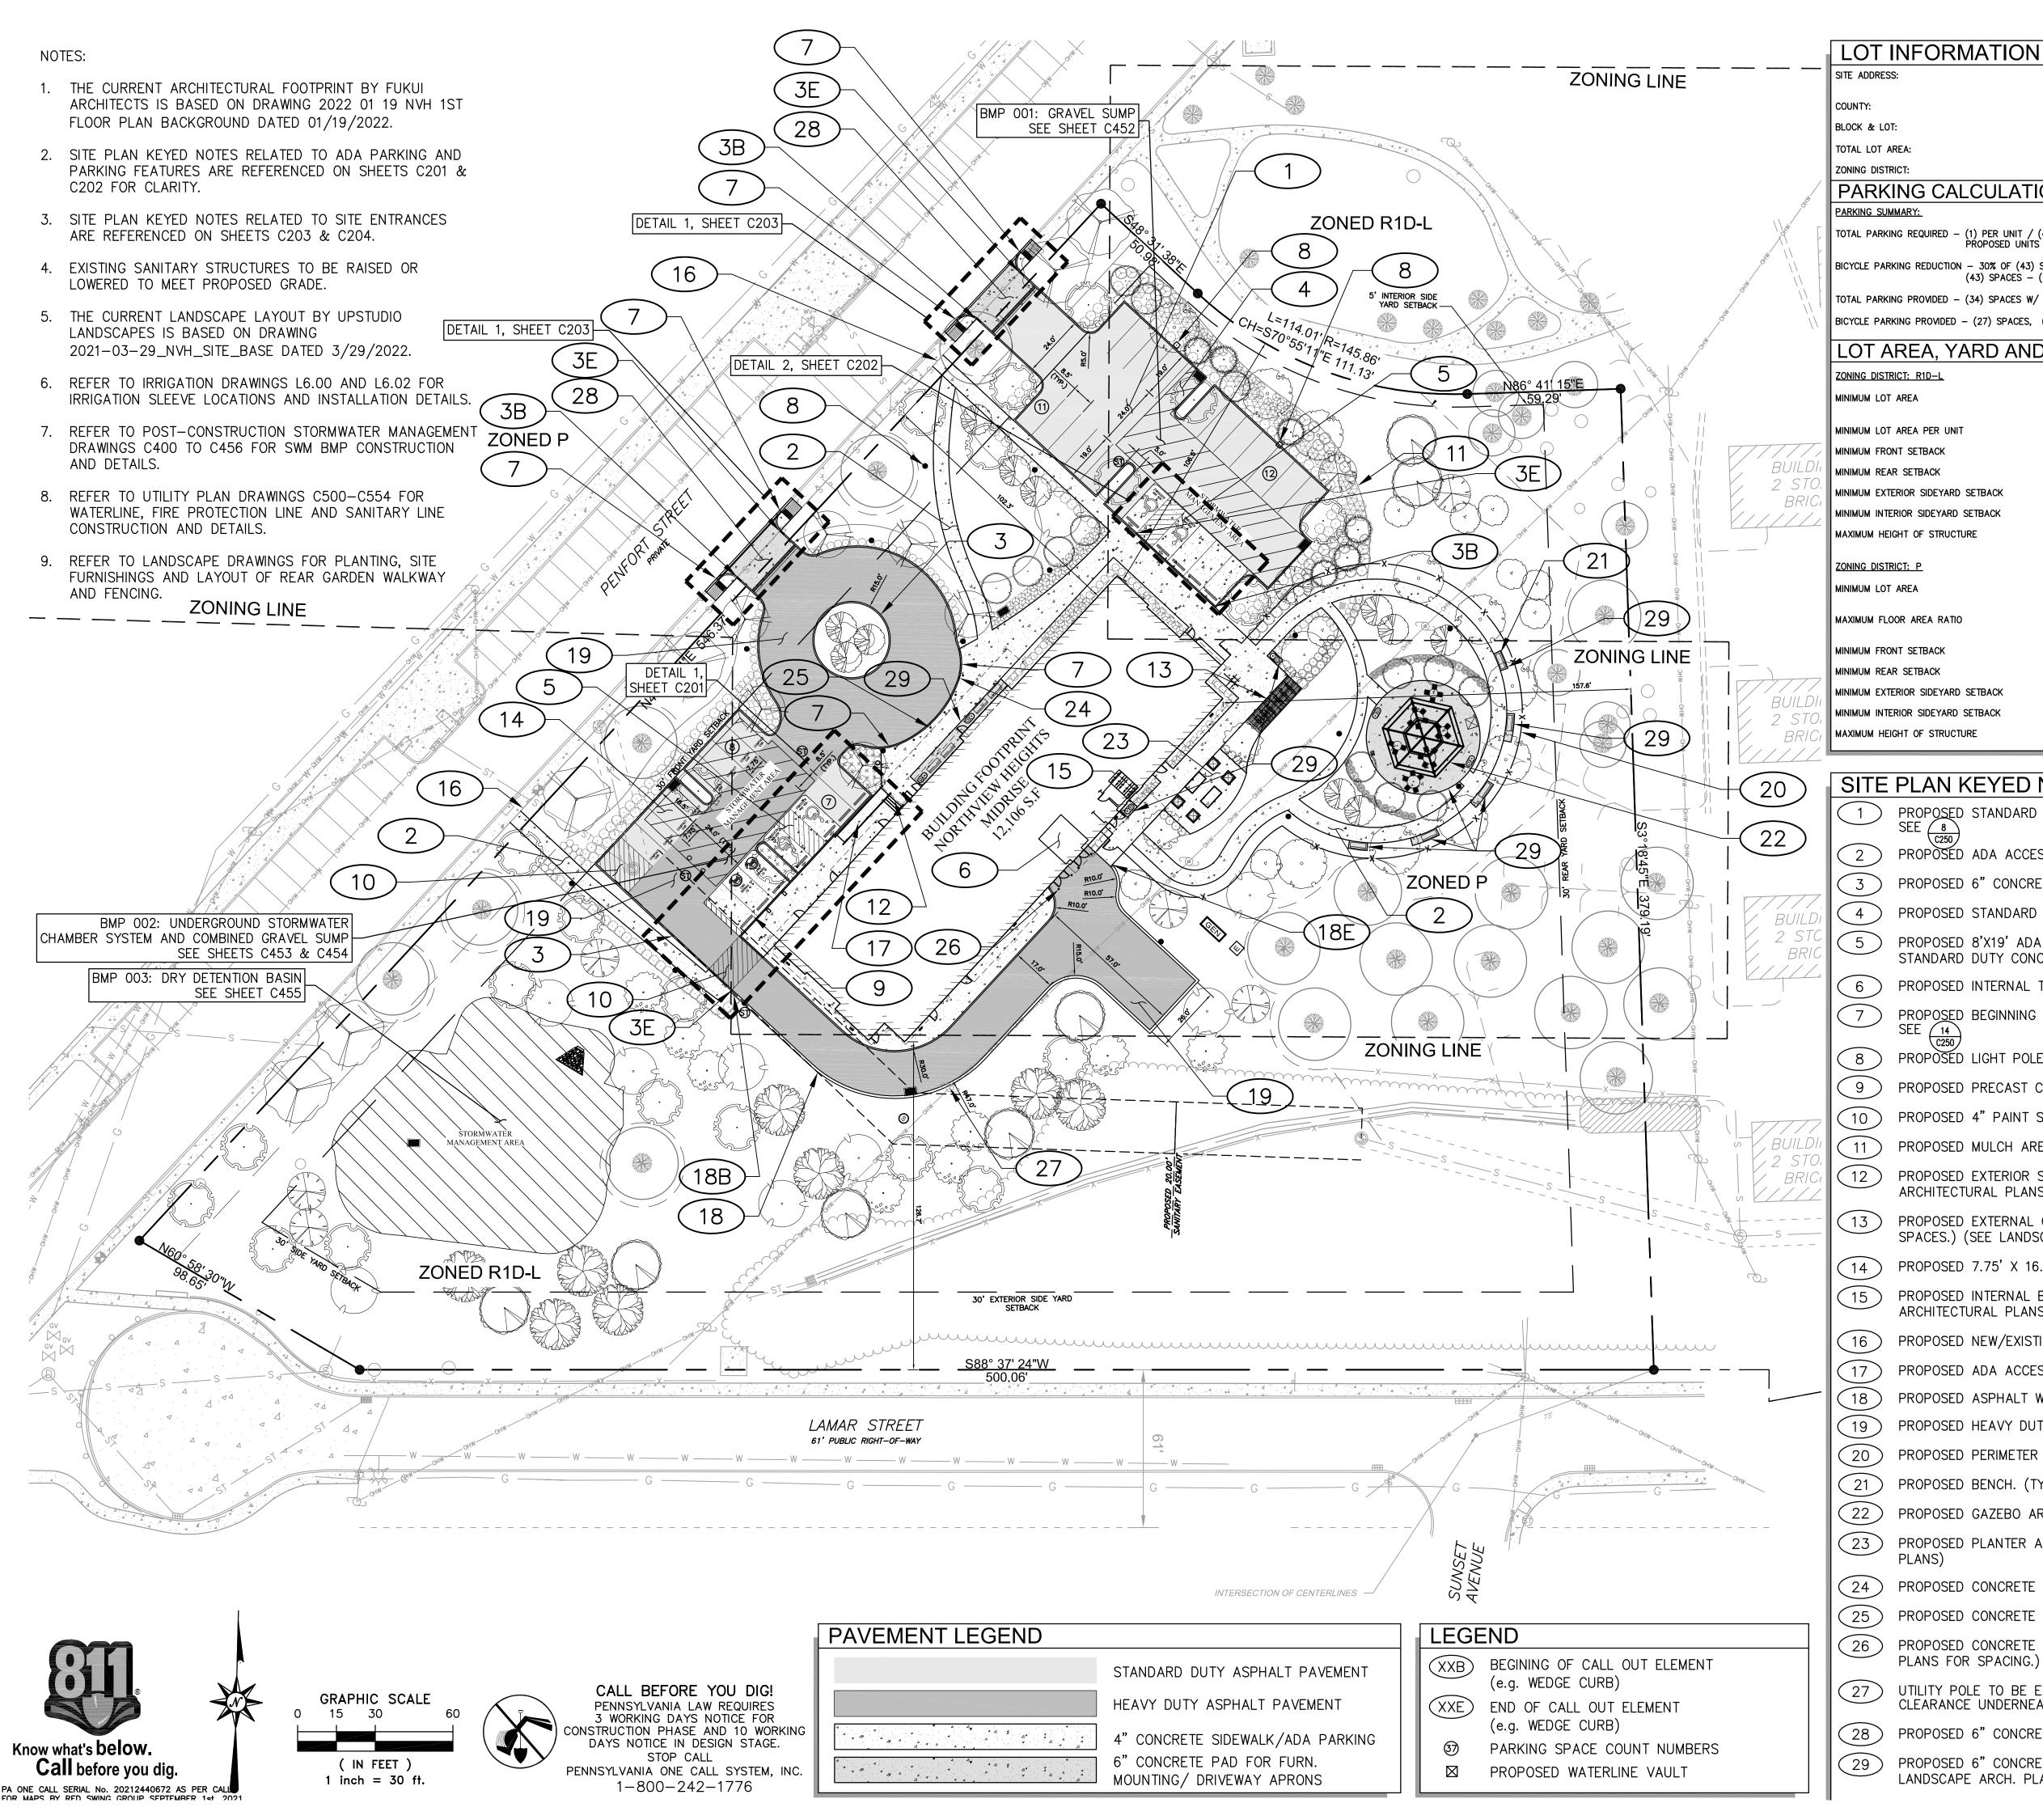

LOT INFORMATION

250 PENFORT ST PITTSBURGH, PA 15219 ALLEGHENY COUNTY 77-D & 50 172,314 FT² OR 3.96 Acs.

R1D-L, P PARKING CALCULATIONS

TOTAL PARKING REQUIRED - (1) PER UNIT / (43) PROPOSED UNITS = (43) SPACES REQUIRED PROPOSED UNITS - 43 x 1 = 43 SPACES REQUIRED

BICYCLE PARKING REDUCTION -30% OF (43) SPACES = (13) SPACES.

(43) SPACES - (13) SPACES = (30) SPACES REQUIRED W/ BICYCLE REDUCTION TOTAL PARKING PROVIDED - (34) SPACES W/ (4) ADA ACCESSIBLE PARKING SPACES*, (38 TOTAL)

BICYCLE PARKING PROVIDED - (27) SPACES, (5) INTERNAL *SEE SHEET C202 FOR OPTION OF (2) ADDITIONAL ADA SPACES.

LOT AREA, YARD AND HEIGHT REQUIREMENTS

	MINIMUM LOT AREA	REQUIRED 5,000 FT ²	<u>PROVIDED</u> 172,314 FT ² OR 3.96 Acs.
1	MINIMUM LOT AREA PER UNIT	3,000 FT ²	11,815 FT²
	MINIMUM FRONT SETBACK	30 FT	102.3 FT
/	MINIMUM REAR SETBACK	30 FT	157.6 FT
', ',	MINIMUM EXTERIOR SIDEYARD SETBACK	30 FT	106.5 FT
	MINIMUM INTERIOR SIDEYARD SETBACK	5 FT	5 FT
	MAXIMUM HEIGHT OF STRUCTURE	40 FT (NOT TO EXCEED 3 STORIES)	4 STORIES - 55 FT ZBA CASE DCP-2021-1102
	ZONING DISTRICT: P MINIMUM LOT AREA	REQUIRED 3,200 FT ²	<u>PROVIDED</u> 172,314 FT ² OR 3.96 Acs.
ı	MAXIMUM FLOOR AREA RATIO	1:1	SEE ARCHITECTURAL PLANS
1	MINIMUM FRONT SETBACK	30 FT	102.0 FT
,	MINIMUM REAR SETBACK	20 FT	157.2X FT
	MINIMUM EXTERIOR SIDEYARD SETBACK	20 FT	106.1 FT
,	MINIMUM INTERIOR SIDEYARD SETBACK	5 FT	5 FT
1	MAXIMUM HEIGHT OF STRUCTURE	40 FT	4 STORIES - 55 FT ZBA CASE DCP-2021-1102

SITE PLAN KEYED NOTES

- PROPOSED STANDARD DUTY ASPHALT PARKING AREA. (TYP.)
- PROPOSED ADA ACCESSIBLE SIDEWALK. SEE $\frac{2}{10050}$
- PROPOSED 6" CONCRETE CURB. (TYP.) SEE (5)
- PROPOSED STANDARD 8.5'X19' PARKING SPACES. (TYP.)
- PROPOSED 8'X19' ADA ACCESSIBLE PARKING SPACES ON
- STANDARD DUTY CONCRETE. (TYP.) SEE 11 & 1 C250 PROPOSED INTERNAL TRASH COLLECTION AREA.
- PROPOSED BEGINNING OF FLUSH CURB TO 6" CURB TRANSITION.
- PROPOSED LIGHT POLE. (TYP.) (SEE SHEET C701).
- PROPOSED PRECAST CONCRETE WHEEL STOP. (TYP.) SEE $\frac{9}{C250}$
- PROPOSED 4" PAINT STRIPING.
- PROPOSED MULCH AREA. (TYP.) SEE LANDSCAPING PLANS.
- PROPOSED EXTERIOR STAIRS WITH HANDRAIL. (SEE ARCHITECTURAL PLANS)
- PROPOSED EXTERNAL COVERED BIKE RACK (TYP. OF 25 SPACES.) (SEE LANDSCAPE ARCHITECTURE PLANS)
- PROPOSED 7.75' X 16.5' COMPACT PARKING SPACE (TYP.)
- PROPOSED INTERNAL BIKE RACK (TYP. OF 5 SPACES.) (SEE ARCHITECTURAL PLANS)
- PROPOSED NEW/EXISTING SIDEWALK JOINT.
- PROPOSED ADA ACCESSIBILITY RAMP. (SEE SHEET C201)
- PROPOSED ASPHALT WEDGE CURB. SEE $\frac{7}{c250}$
- PROPOSED HEAVY DUTY ASPHALT PAVEMENT. SEE $\frac{8}{(250)}$
- PROPOSED PERIMETER FENCE. (SEE LANDSCAPE ARCH. PLANS)
- PROPOSED BENCH. (TYP.) (SEE LANDSCAPE ARCH. PLANS)
- PROPOSED GAZEBO AREA. (SEE LANDSCAPE ARCH. PLANS)
- PROPOSED PLANTER AND PATIO. (TYP.) (SEE LANDSCAPE ARCH.
- PROPOSED CONCRETE FLUSH CURB. SEE $\frac{6}{c250}$
- PROPOSED CONCRETE BOLLARD. (TYP. OF 6 @ 8' O.C.) SEE $\frac{10}{C250}$
- PROPOSED CONCRETE BOLLARDS FOR TRASH AREA. (SEE ARCH
- UTILITY POLE TO BE EXTENDED OR REPLACED TO PROVIDE 15' CLEARANCE UNDERNEATH OVERHEAD LINES.
- PROPOSED 6" CONCRETE DRIVEWAY APRON.
- PROPOSED 6" CONCRETE FOR FURNITURE MOUNTING. (SEE LANDSCAPE ARCH. PLANS)

Fukui Architects Pc

205 Ross Street


Pittsburgh, Pennsylvania 15219

ph 412.281.6001 fx 412.281.6002



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ENGINEERS & SURVEYORS 4314 OLD WILLIAM PENN HWY MONROEVILLE, PA 15146 OFFICE: 724.325.1215

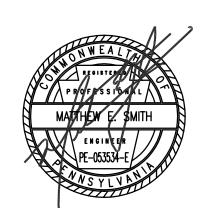

general notes

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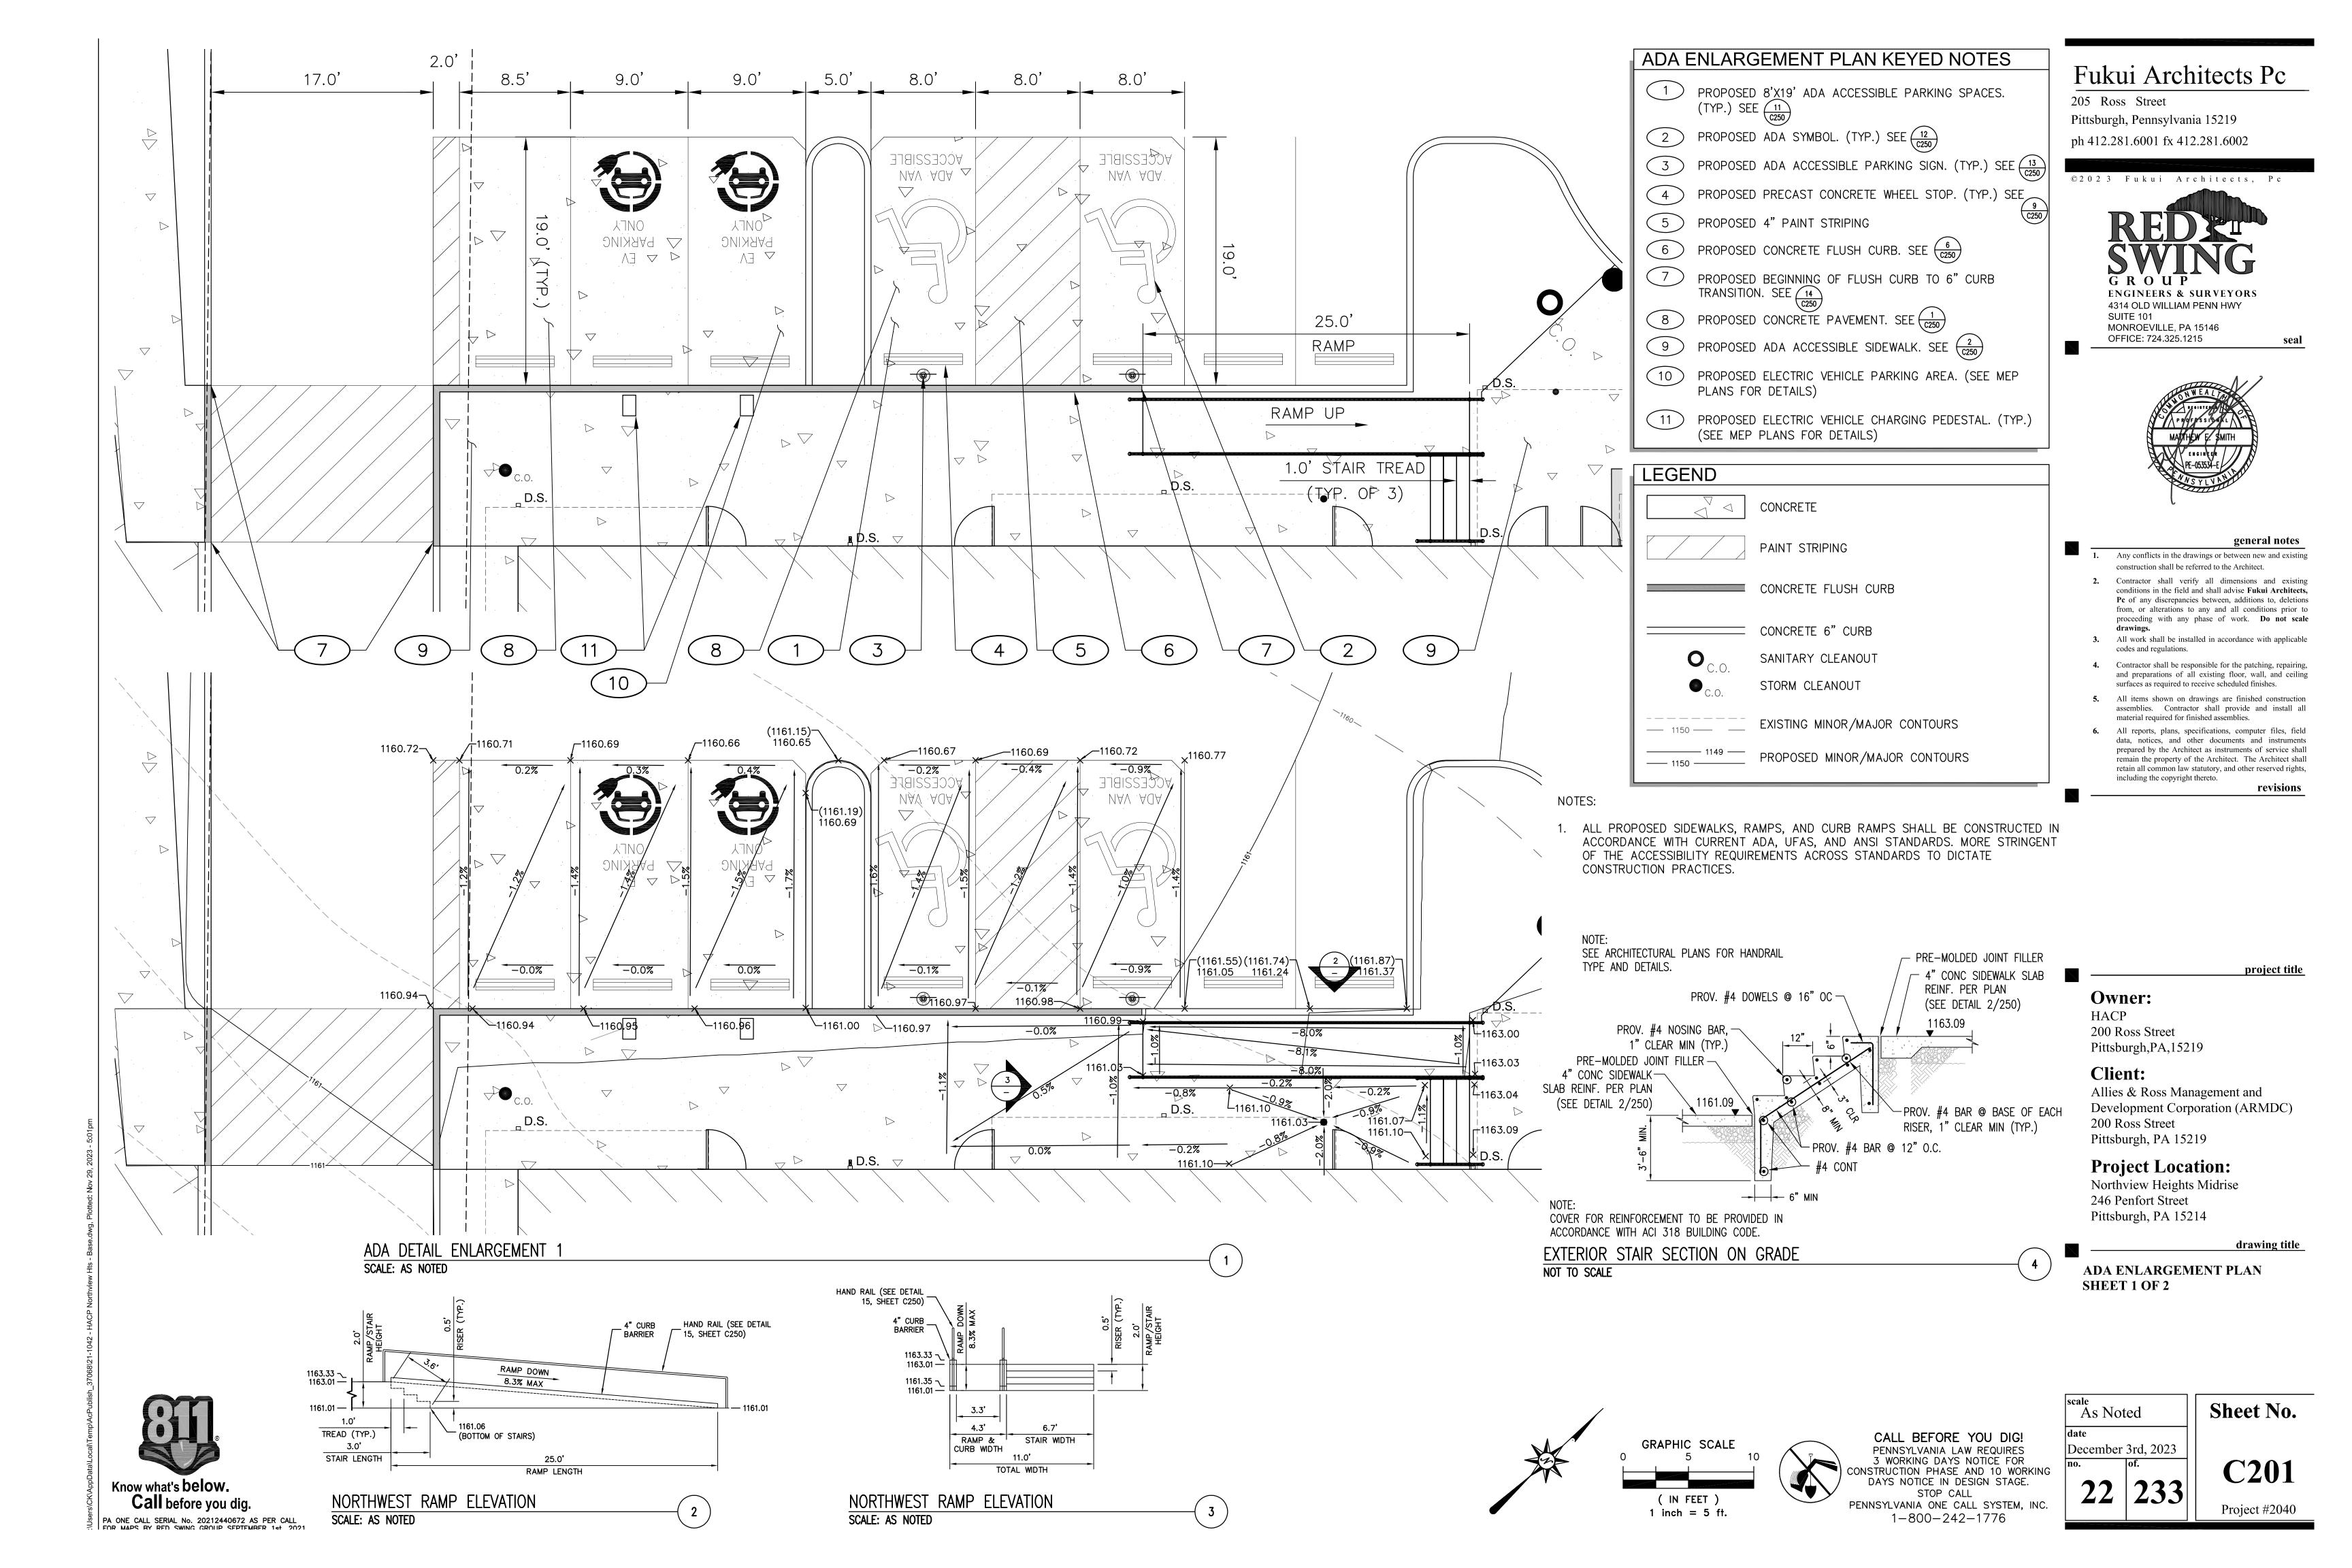
Northview Heights Midrise 246 Penfort Street Pittsburgh, PA 15214

drawing title

SITE PLAN

Sheet No. As Noted December 3rd, 2023

C200



LEGEND CONCRETE PAINT STRIPING CONCRETE FLUSH CURB CONCRETE 6" CURB SANITARY CLEANOUT STORM CLEANOUT EXISTING MINOR/MAJOR CONTOURS PROPOSED MINOR/MAJOR CONTOURS

ADA ENLARGEMENT PLAN KEYED NOTES PROPOSED 8'X19' ADA ACCESSIBLE PARKING SPACES. (TYP.) SEE $\frac{11}{C250}$ PROPOSED ADA SYMBOL. (TYP.) SEE $\frac{12}{(2250)}$ PROPOSED ADA ACCESSIBLE PARKING SIGN. (TYP.) SEE 13 C250 PROPOSED PRECAST CONCRETE WHEEL STOP. (TYP.) SEE
PROPOSED 4" PAINT STRIPING PROPOSED 4" PAINT STRIPING. PROPOSED CONCRETE FLUSH CURB. SEE $\binom{6}{C250}$ PROPOSED BEGINNING OF FLUSH CURB TO 6" CURB TRANSITION. SEE (10) PROPOSED CONCRETE PAVEMENT. SEE $\frac{1}{(2250)}$ PROPOSED ADA ACCESSIBLE SIDEWALK. SEE $\frac{2}{(c250)}$

Fukui Architects Pc

205 Ross Street Pittsburgh, Pennsylvania 15219 ph 412.281.6001 fx 412.281.6002

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4314 OLD WILLIAM PENN HWY SUITE 101 MONROEVILLE, PA 15146 OFFICE: 724.325.1215

general notes

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revisions

project title

Owner:

Pittsburgh,PA,15219

HACP 200 Ross Street

Client:

Allies & Ross Management and Development Corporation (ARMDC) 200 Ross Street Pittsburgh, PA 15219

Project Location:


Northview Heights Midrise 246 Penfort Street Pittsburgh, PA 15214

drawing title

ADA ENLARGEMENT PLAN SHEET 2 OF 2

NOTES:

1. ALL PROPOSED SIDEWALKS, RAMPS, AND CURB RAMPS SHALL BE CONSTRUCTED IN ACCORDANCE WITH CURRENT ADA, UFAS, AND ANSI STANDARDS. MORE STRINGENT OF THE ACCESSIBILITY REQUIREMENTS ACROSS STANDARDS TO DICTATE CONSTRUCTION PRACTICES.

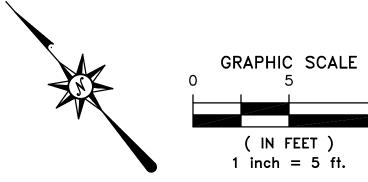



CALL BEFORE YOU DIG! PENNSYLVANIA LAW REQUIRES
3 WORKING DAYS NOTICE FOR
CONSTRUCTION PHASE AND 10 WORKING
DAYS NOTICE IN DESIGN STAGE. STOP CALL PENNSYLVANIA ONE CALL SYSTEM, INC.

1-800-242-1776

December 3rd, 2023 233

As Noted

C202 Project #2040

Sheet No.



8


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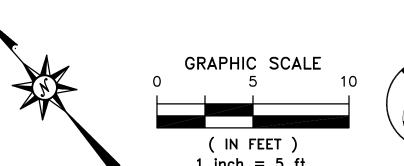
8.0'


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SCALE: AS NOTED

ADA DETAIL ENLARGEMENT 2





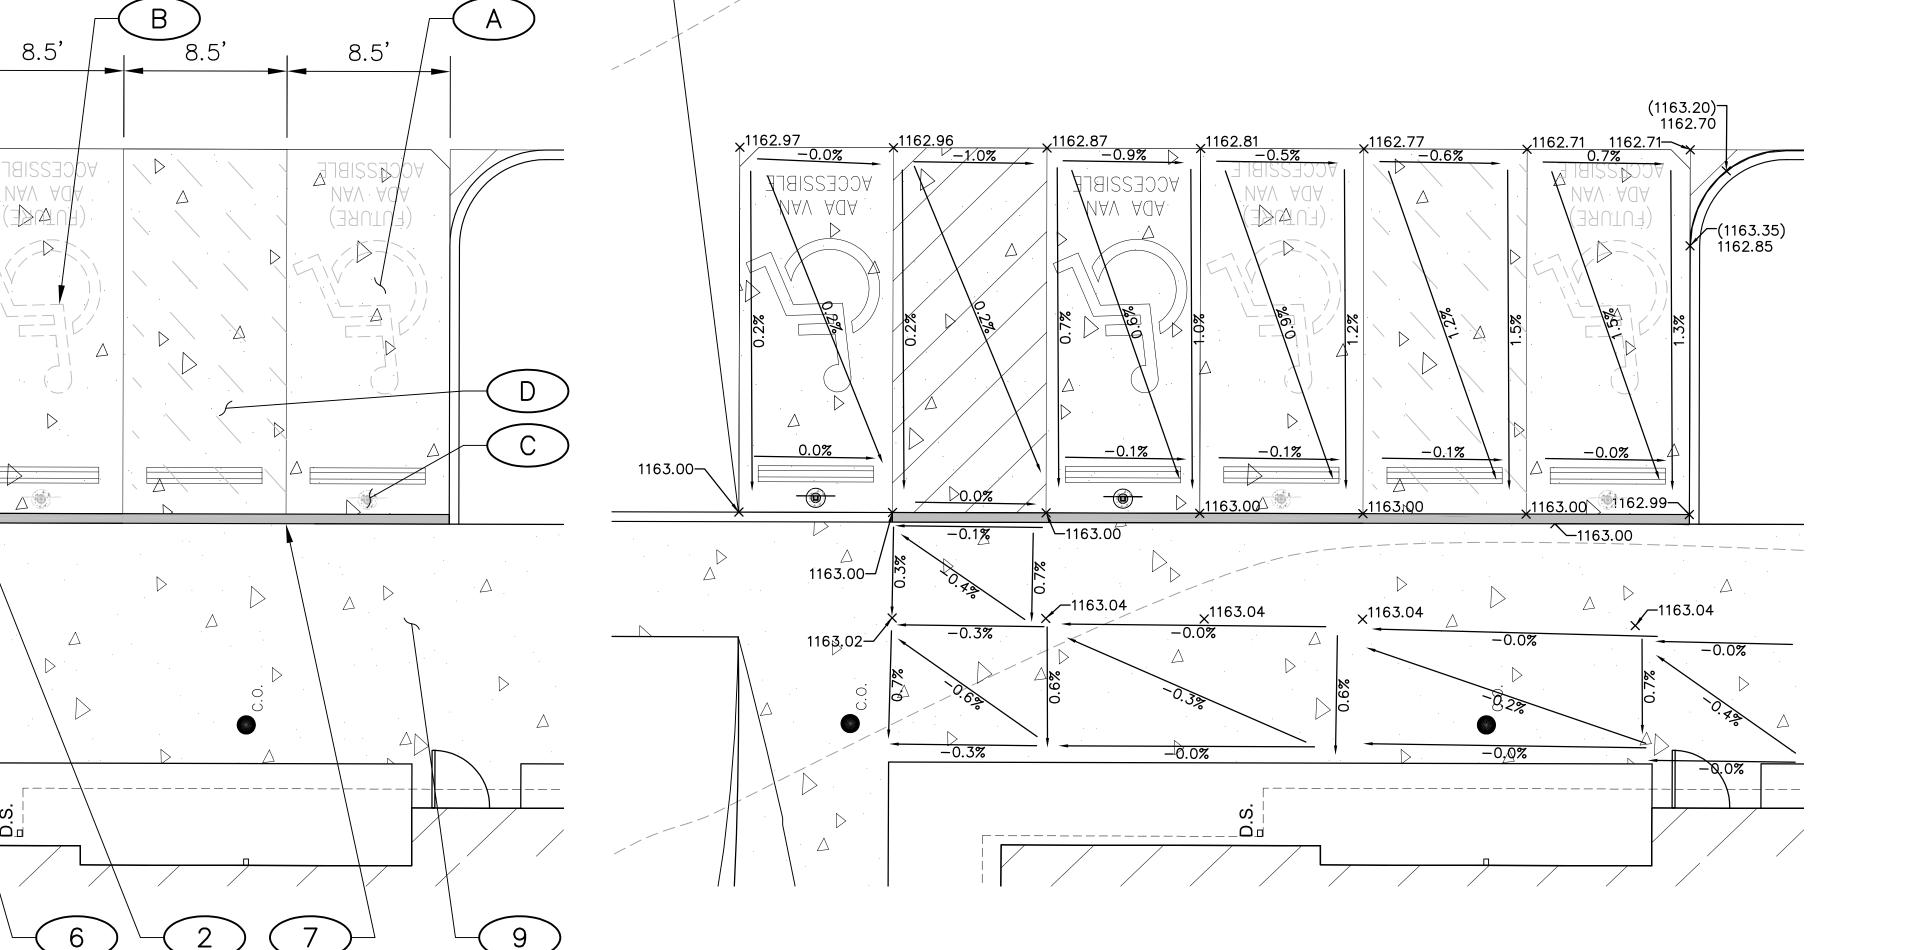

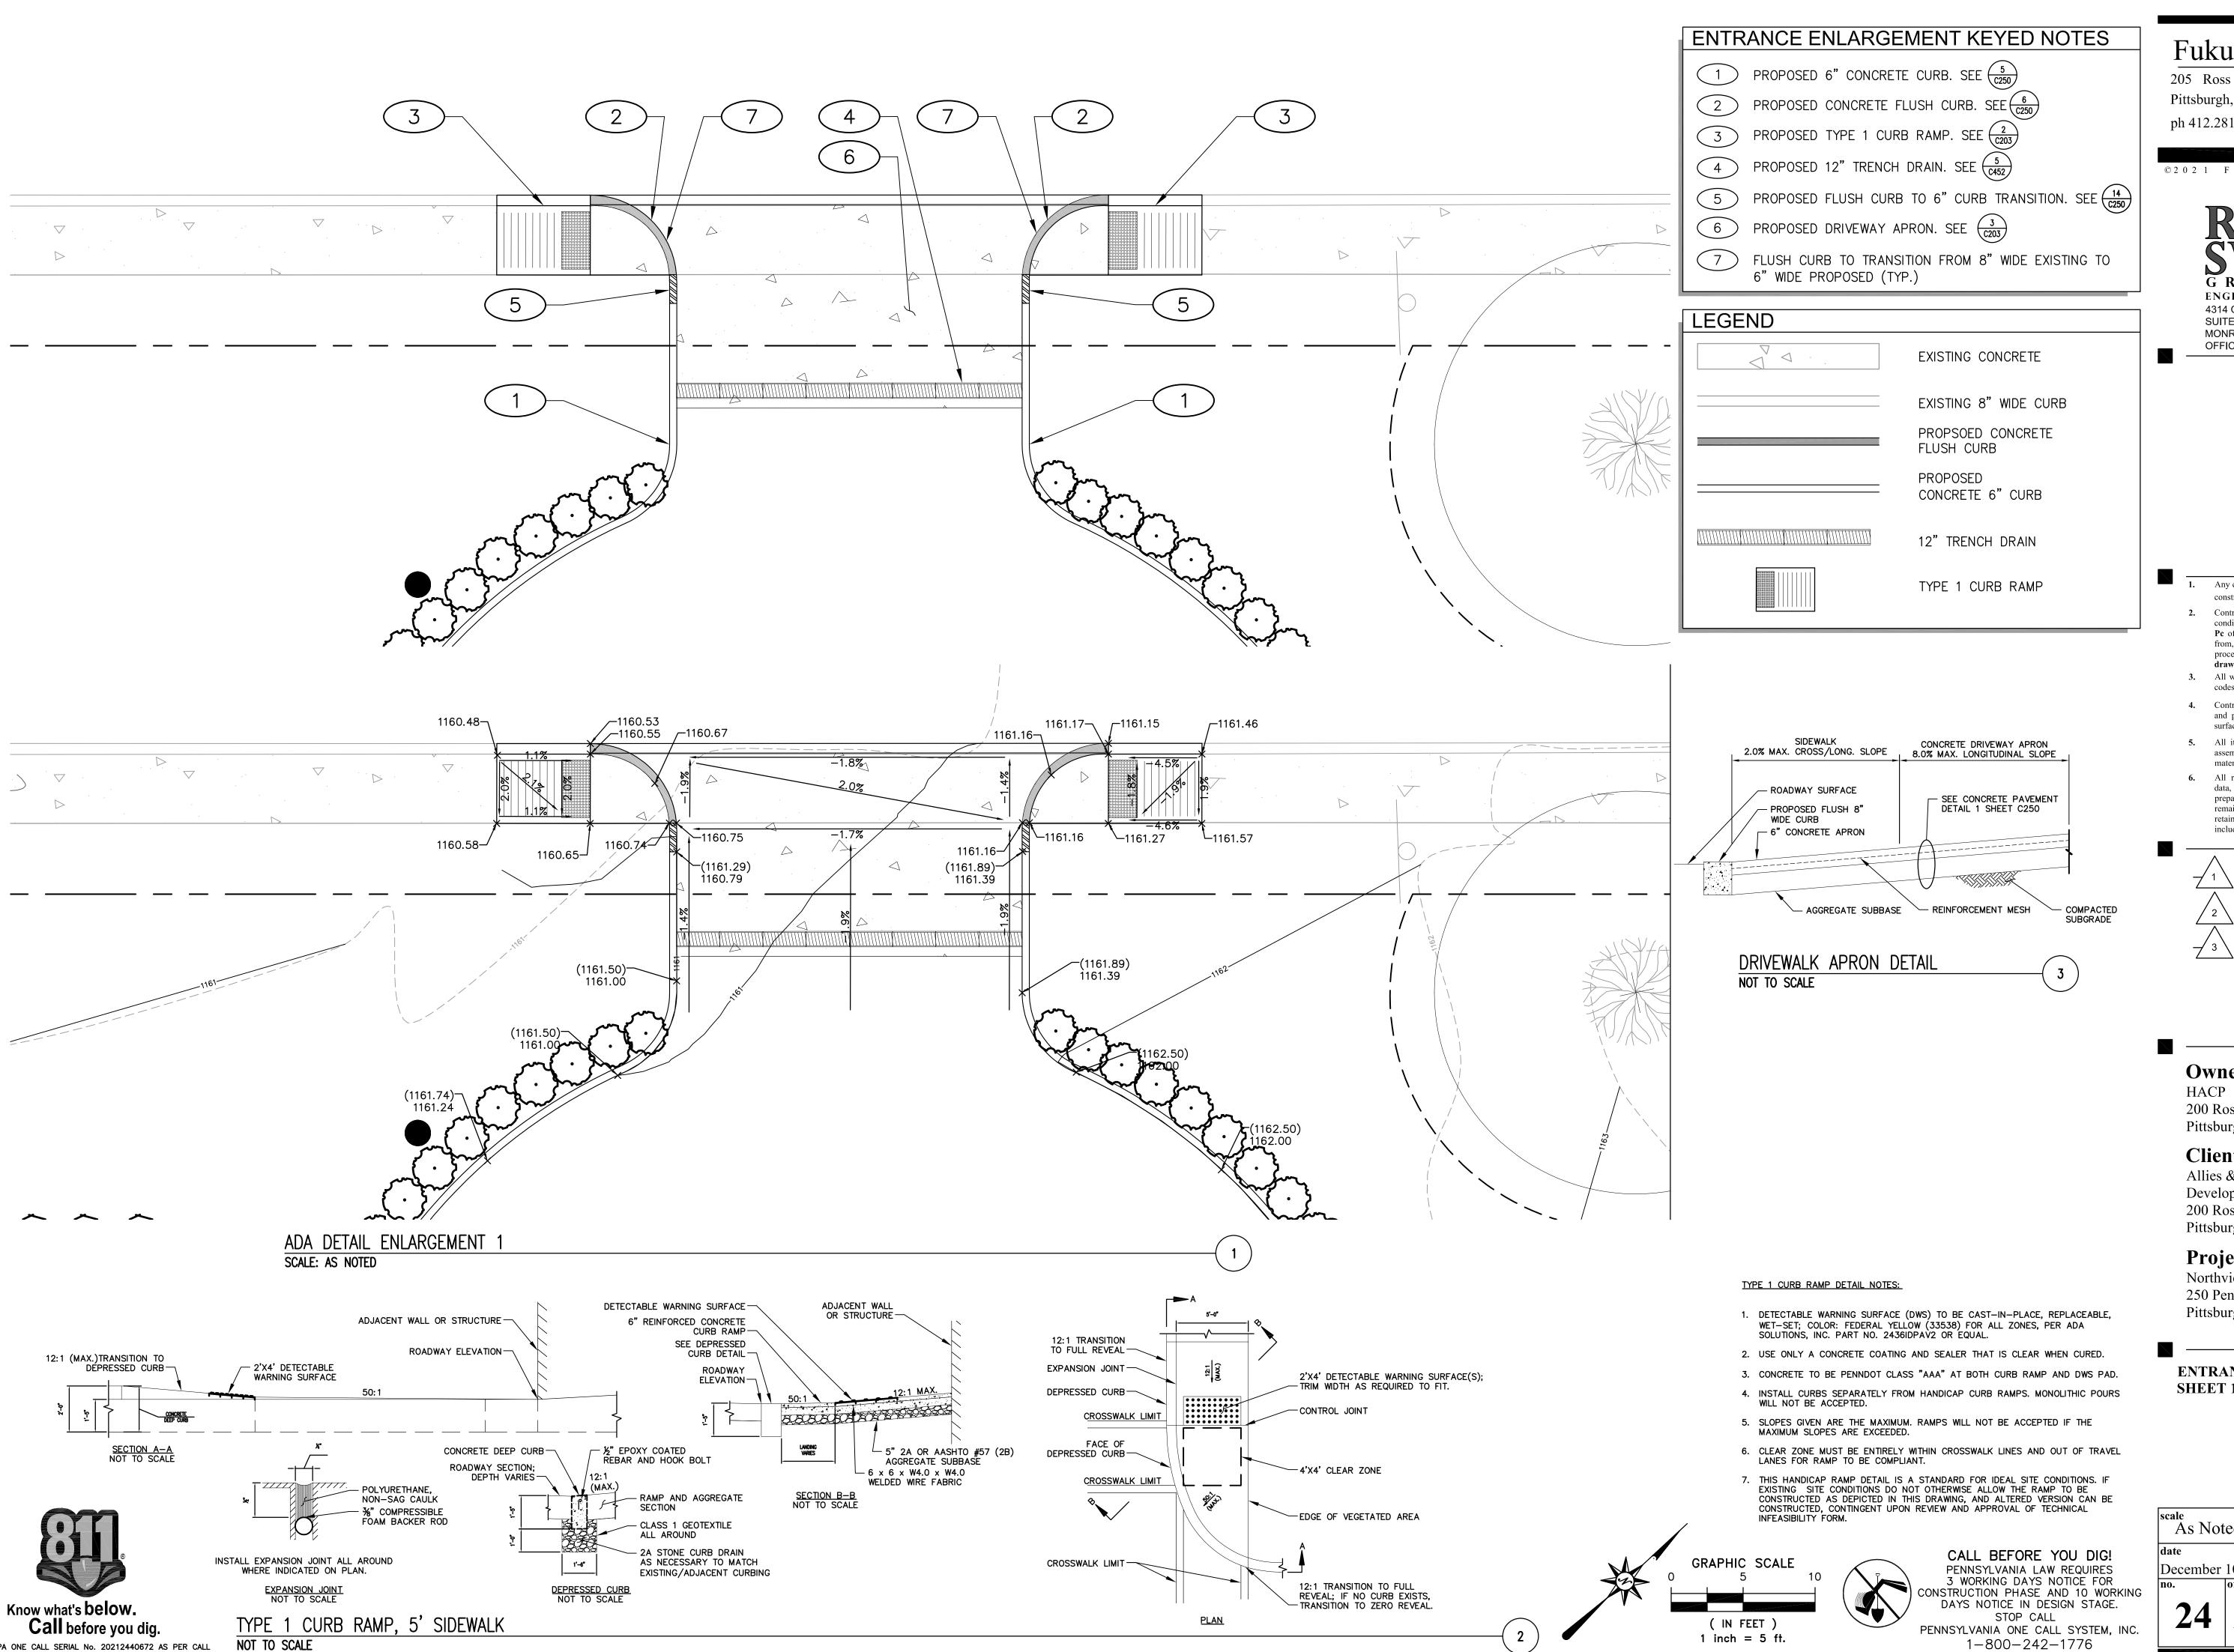PA ONE CALL SERIAL No. 20212440672 AS PER CALL FOR MAPS BY RED SWING GROUP SEPTEMBER 1et 2021

Fukui Architects Pc


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ENGINEERS & SURVEYORS 4314 OLD WILLIAM PENN HWY SUITE 101

MONROEVILLE, PA 15146 OFFICE: 724.325.1215



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revisions → 1 \ REVISED 2022/02/09 REVISED 2022/03/04 → 3 \ REVISED 2022/03/30

Owner:

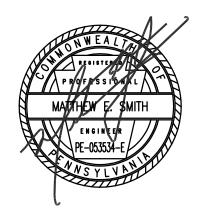200 Ross Street Pittsburgh,PA,15219

Client:

Allies & Ross Management and Development Corporation (ARMDC) 200 Ross Street Pittsburgh, PA 15219

Project Location:


Northview Heights Midrise 250 Penfort Street Pittsburgh, PA 15214

drawing title

project title

ENTRANCE ENLARGEMENT PLAN SHEET 1 OF 2

scale As Note	ed	Sheet No.
date		
December ino.	10, 2021 of.	C203
24	233	C203
		Project #2040

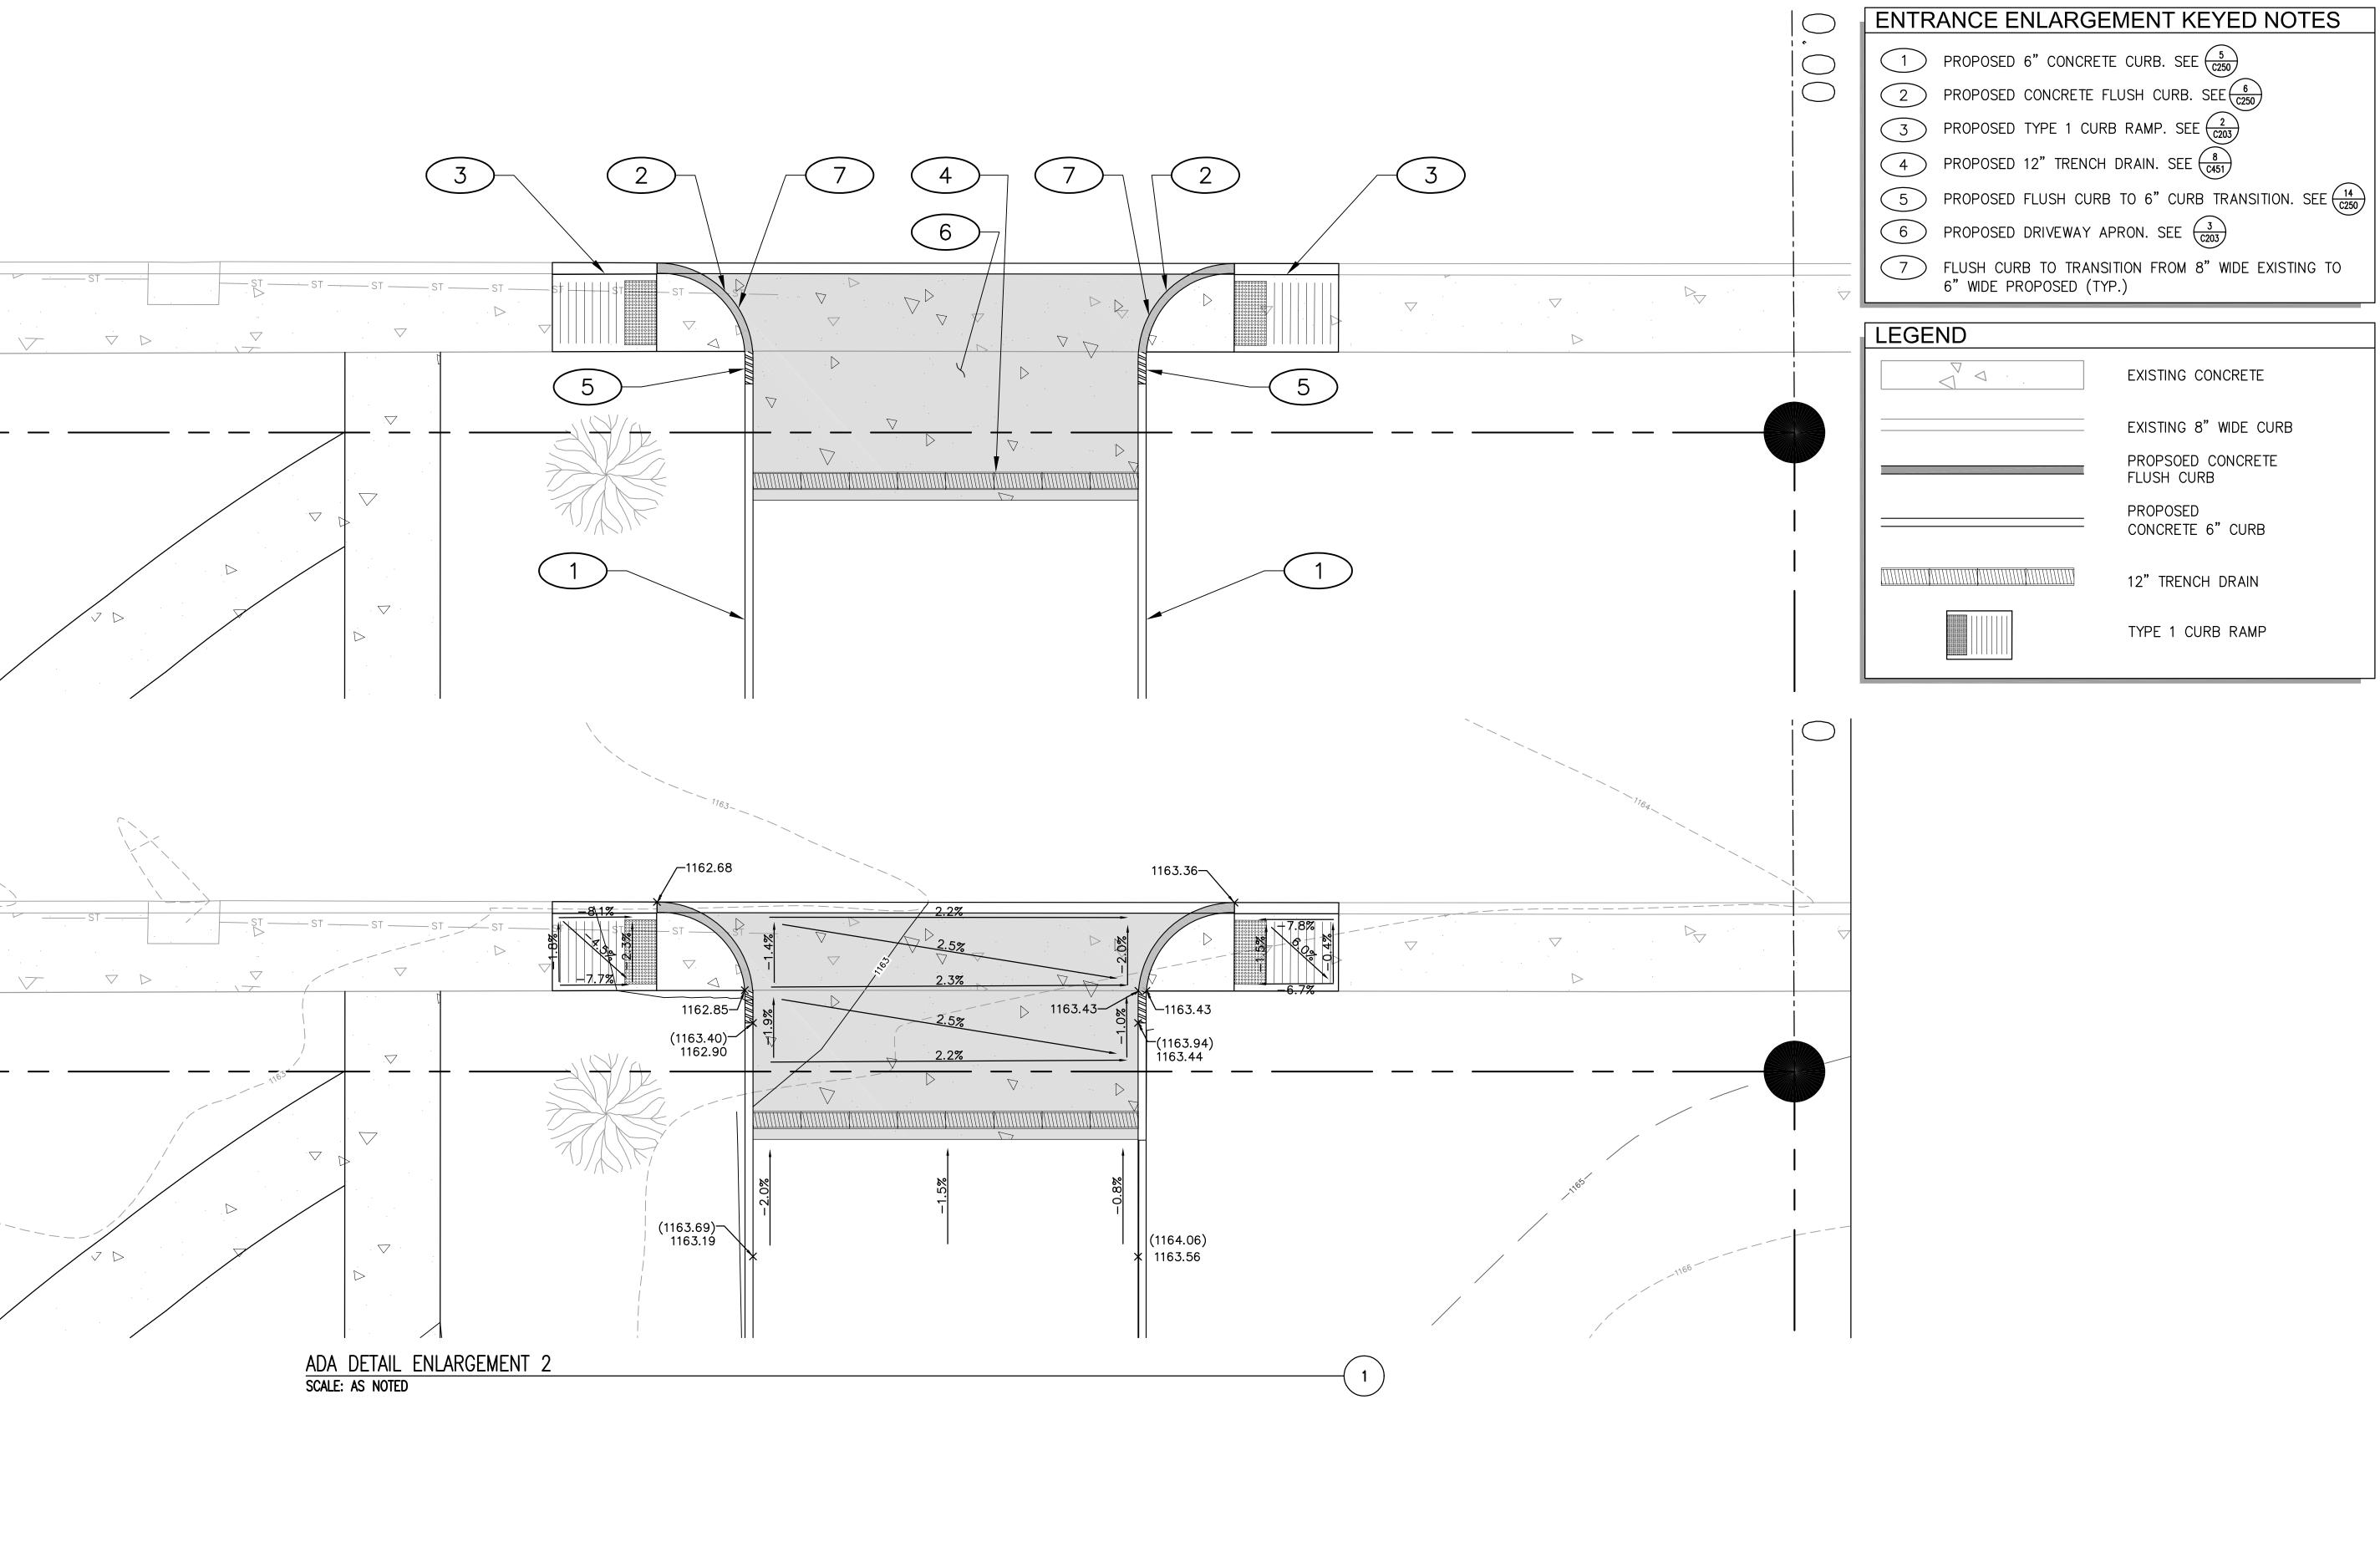

Fukui Architects Pc


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revisions

project title

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HACP 200 Ross Street Pittsburgh,PA,15219

Client:

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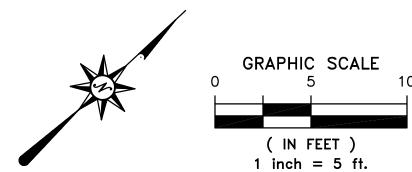
Northview Heights Midrise 246 Penfort Street Pittsburgh, PA 15214

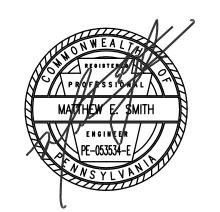drawing title

ENTRANCE ENLARGEMENT PLAN SHEET 2 OF 2



PA ONE CALL SERIAL No. 20212440672 AS PER CALL FOR MAPS BY RED SWING GROUP SEPTEMBER 1st 202






As Noted CALL BEFORE YOU DIG!


PENNSYLVANIA LAW REQUIRES
3 WORKING DAYS NOTICE FOR
CONSTRUCTION PHASE AND 10 WORKING
DAYS NOTICE IN DESIGN STAGE.

STOP CALL
PENNSYLVANIA ONE CALL SYSTEM, INC.
1-800-242-1776

December 3rd, 2023 233 **C204**

Sheet No.

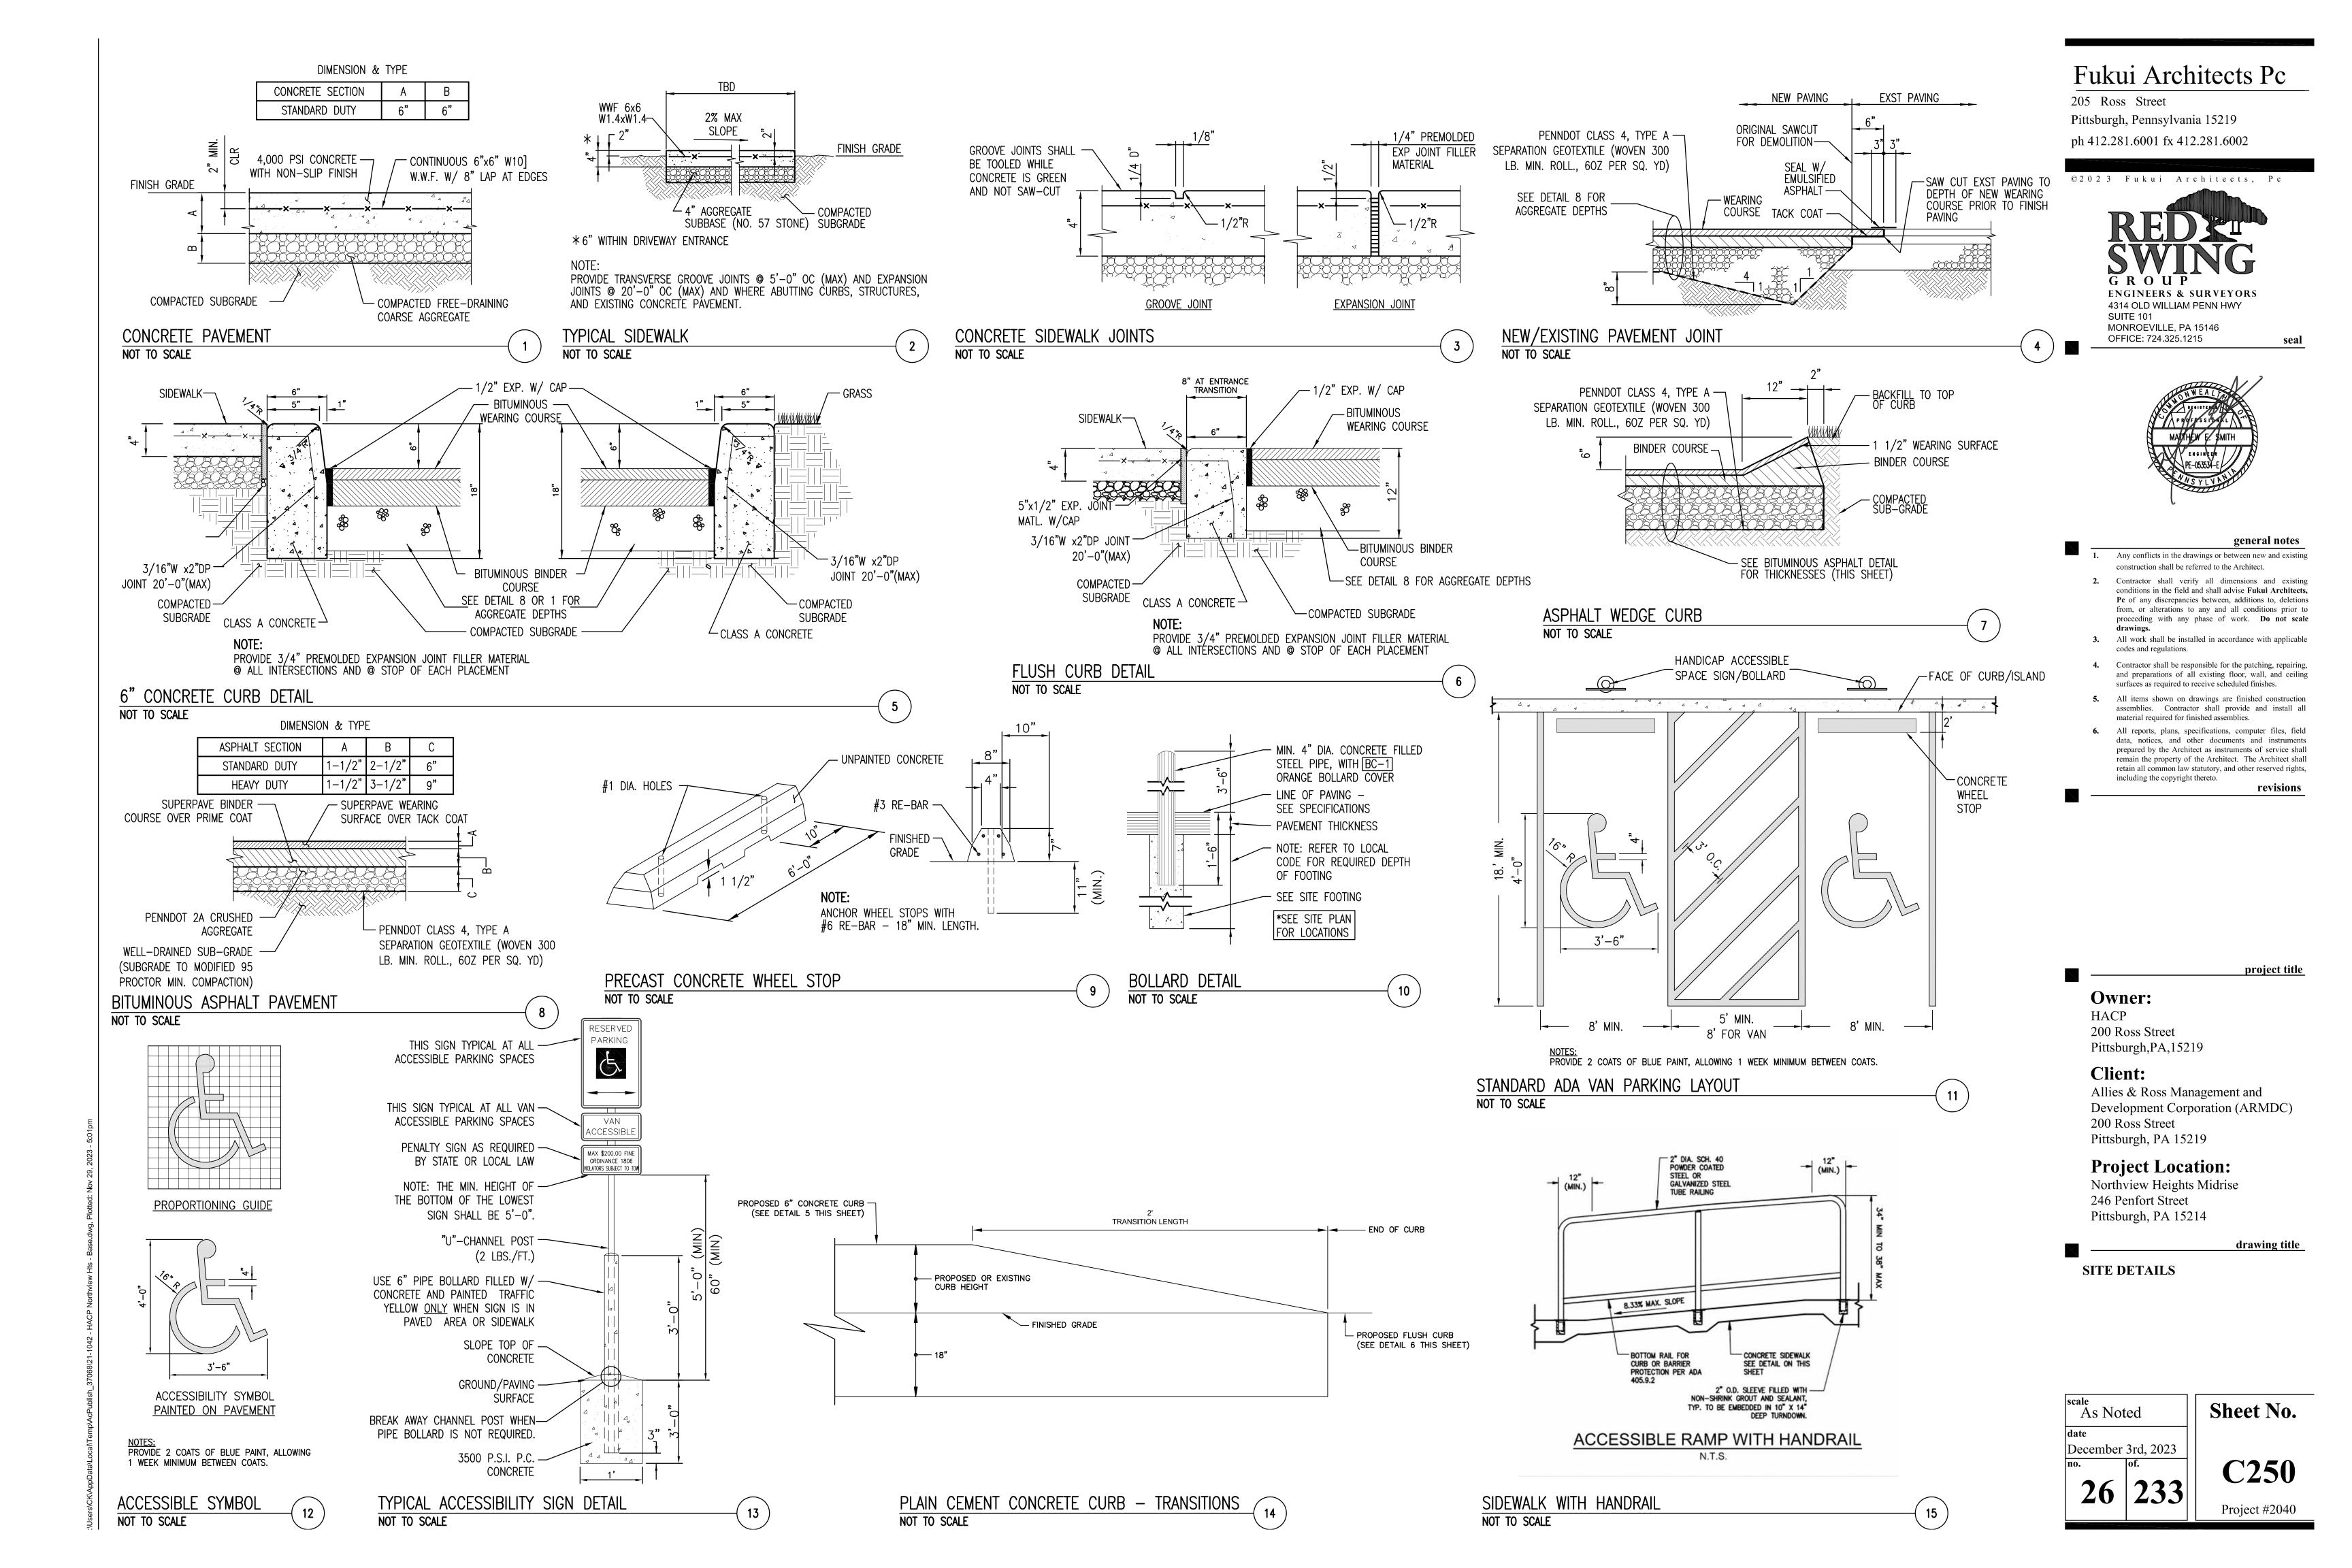

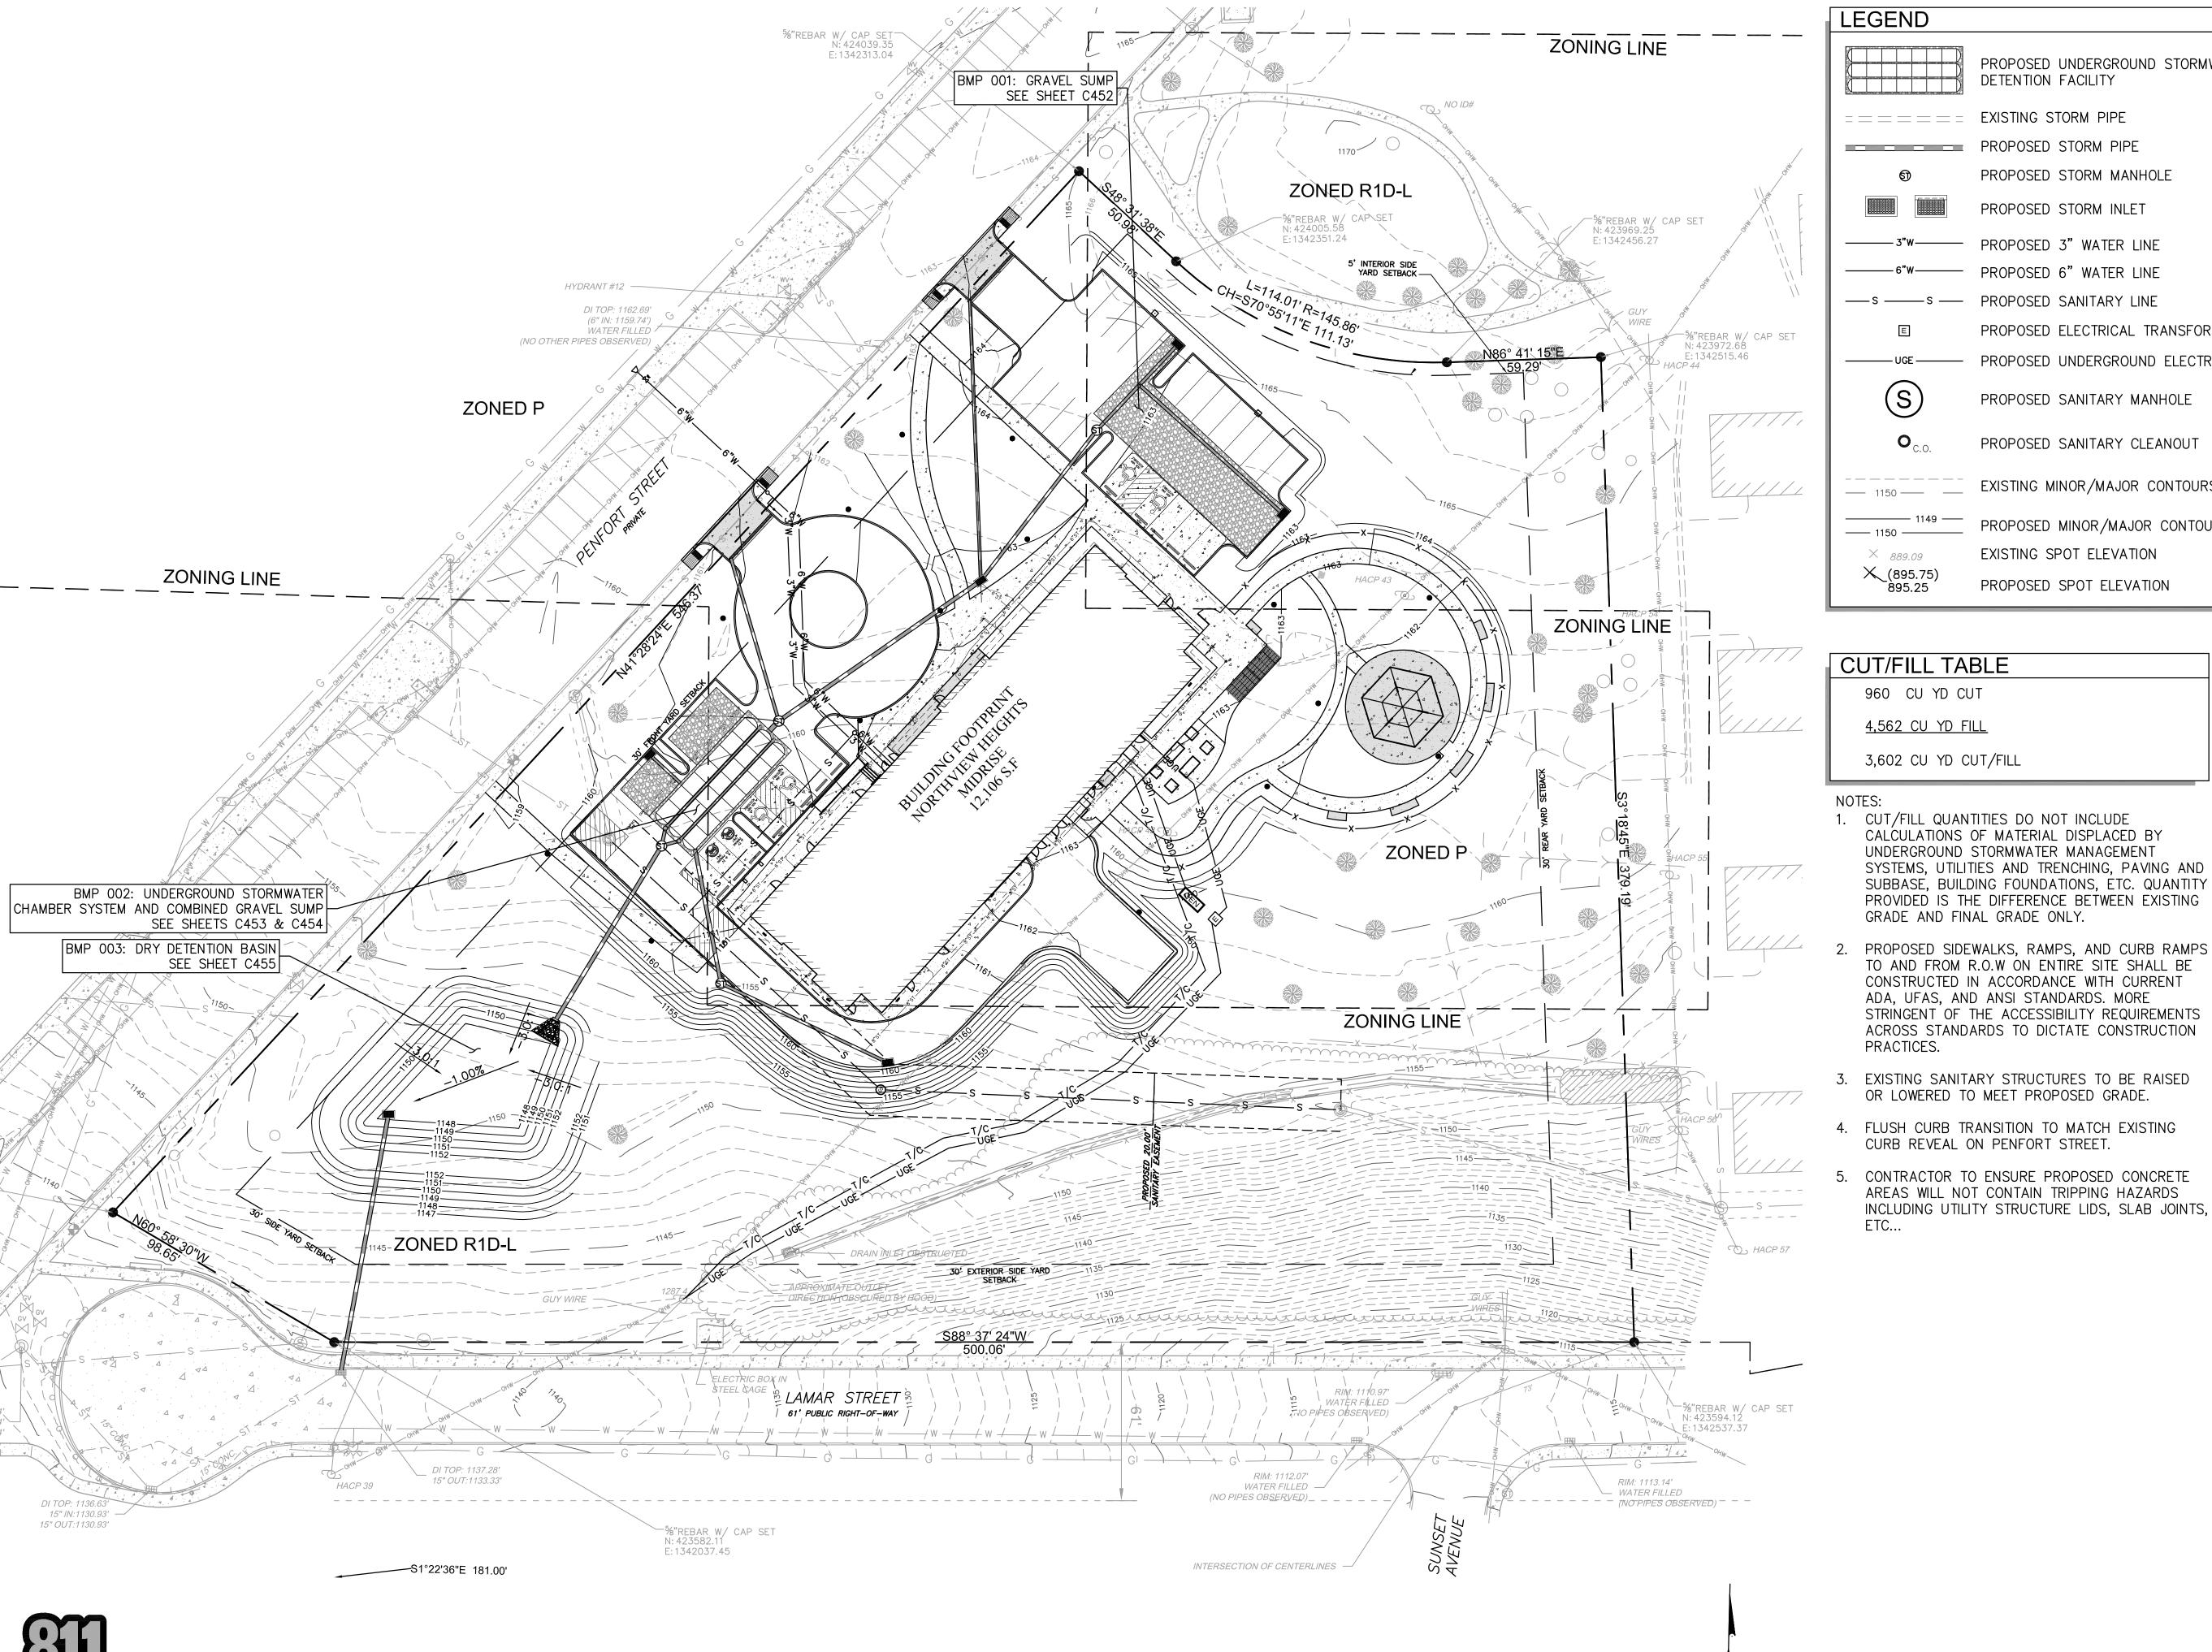

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Fukui Architects Pc

205 Ross Street

PROPOSED UNDERGROUND STORMWATER

DETENTION FACILITY

PROPOSED STORM MANHOLE

PROPOSED STORM INLET

PROPOSED 3" WATER LINE

PROPOSED 6" WATER LINE

(S)

PROPOSED ELECTRICAL TRANSFORMER

PROPOSED SANITARY MANHOLE

PROPOSED SANITARY CLEANOUT

EXISTING MINOR/MAJOR CONTOURS

PROPOSED MINOR/MAJOR CONTOURS

EXISTING SPOT ELEVATION

PROPOSED SPOT ELEVATION

PROPOSED UNDERGROUND ELECTRIC LINE


Pittsburgh, Pennsylvania 15219

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ENGINEERS & SURVEYORS 4314 OLD WILLIAM PENN HWY SUITE 101 MONROEVILLE, PA 15146

OFFICE: 724.325.1215



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revisions

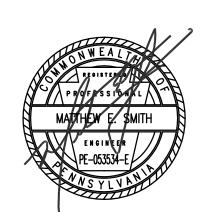project title

Owner:

HACP 200 Ross Street

Pittsburgh,PA,15219

Client:


Allies & Ross Management and Development Corporation (ARMDC) 200 Ross Street Pittsburgh, PA 15219

Project Location:


Northview Heights Midrise 246 Penfort Street Pittsburgh, PA 15214

drawing title

OVERALL GRADING PLAN

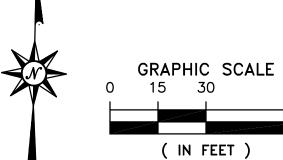

1 inch = 30 ft.

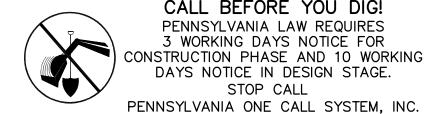


CALL BEFORE YOU DIG! PENNSYLVANIA LAW REQUIRES
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CONSTRUCTION PHASE AND 10 WORKING
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1-800-242-1776

December 3rd, 2023 233

As Noted

C300 Project #2040

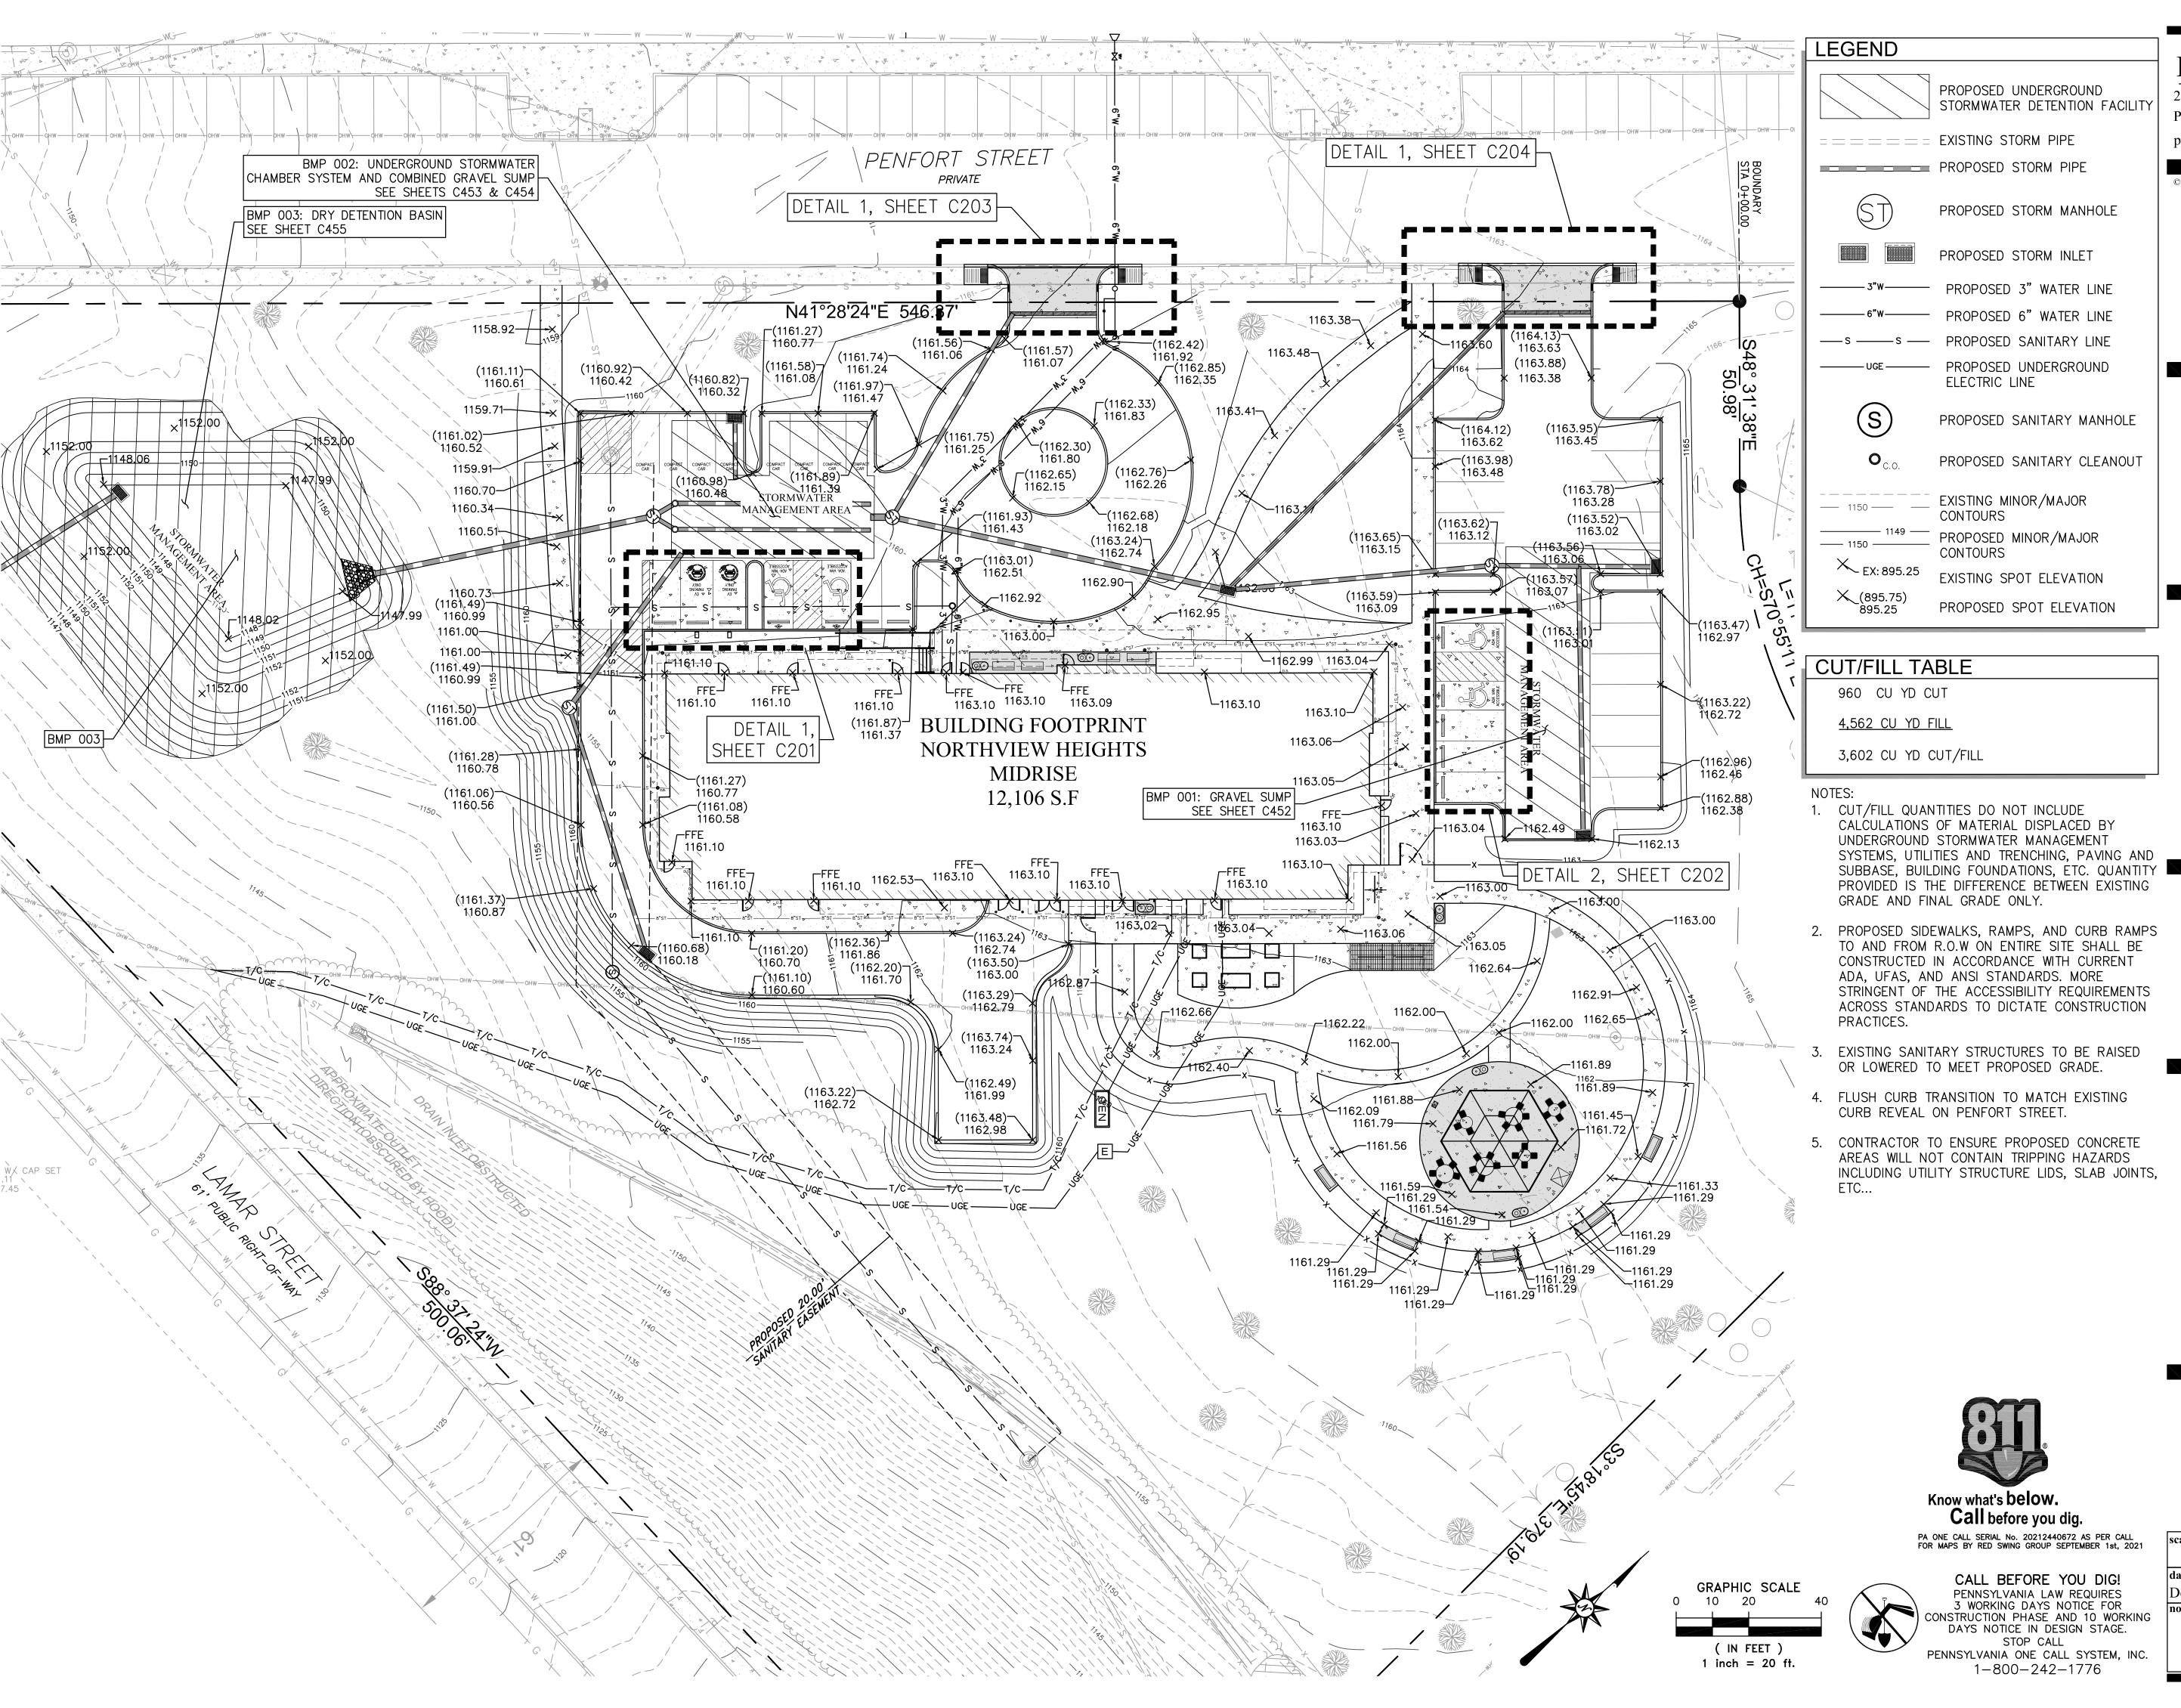

Fukui Architects Pc

205 Ross Street


Pittsburgh, Pennsylvania 15219

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ENGINEERS & SURVEYORS 4314 OLD WILLIAM PENN HWY

SUITE 101 MONROEVILLE, PA 15146 OFFICE: 724.325.1215



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revisions

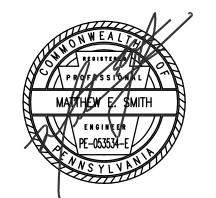project title

Owner:

HACP 200 Ross Street

Pittsburgh,PA,15219

Client:

Allies & Ross Management and Development Corporation (ARMDC) 200 Ross Street Pittsburgh, PA 15219

Project Location:

Northview Heights Midrise 246 Penfort Street Pittsburgh, PA 15214

drawing title

GRADING ENLARGEMENT PLAN



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PA ONE CALL SERIAL No. 20212440672 AS PER CALL FOR MAPS BY RED SWING GROUP SEPTEMBER 1st, 2021

CALL BEFORE YOU DIG! PENNSYLVANIA LAW REQUIRES
3 WORKING DAYS NOTICE FOR
CONSTRUCTION PHASE AND 10 WORKING
DAYS NOTICE IN DESIGN STAGE. STOP CALL


PENNSYLVANIA ONE CALL SYSTEM, INC. 1-800-242-1776

As Noted December 3rd, 2023

28

C301 233

Project #2040

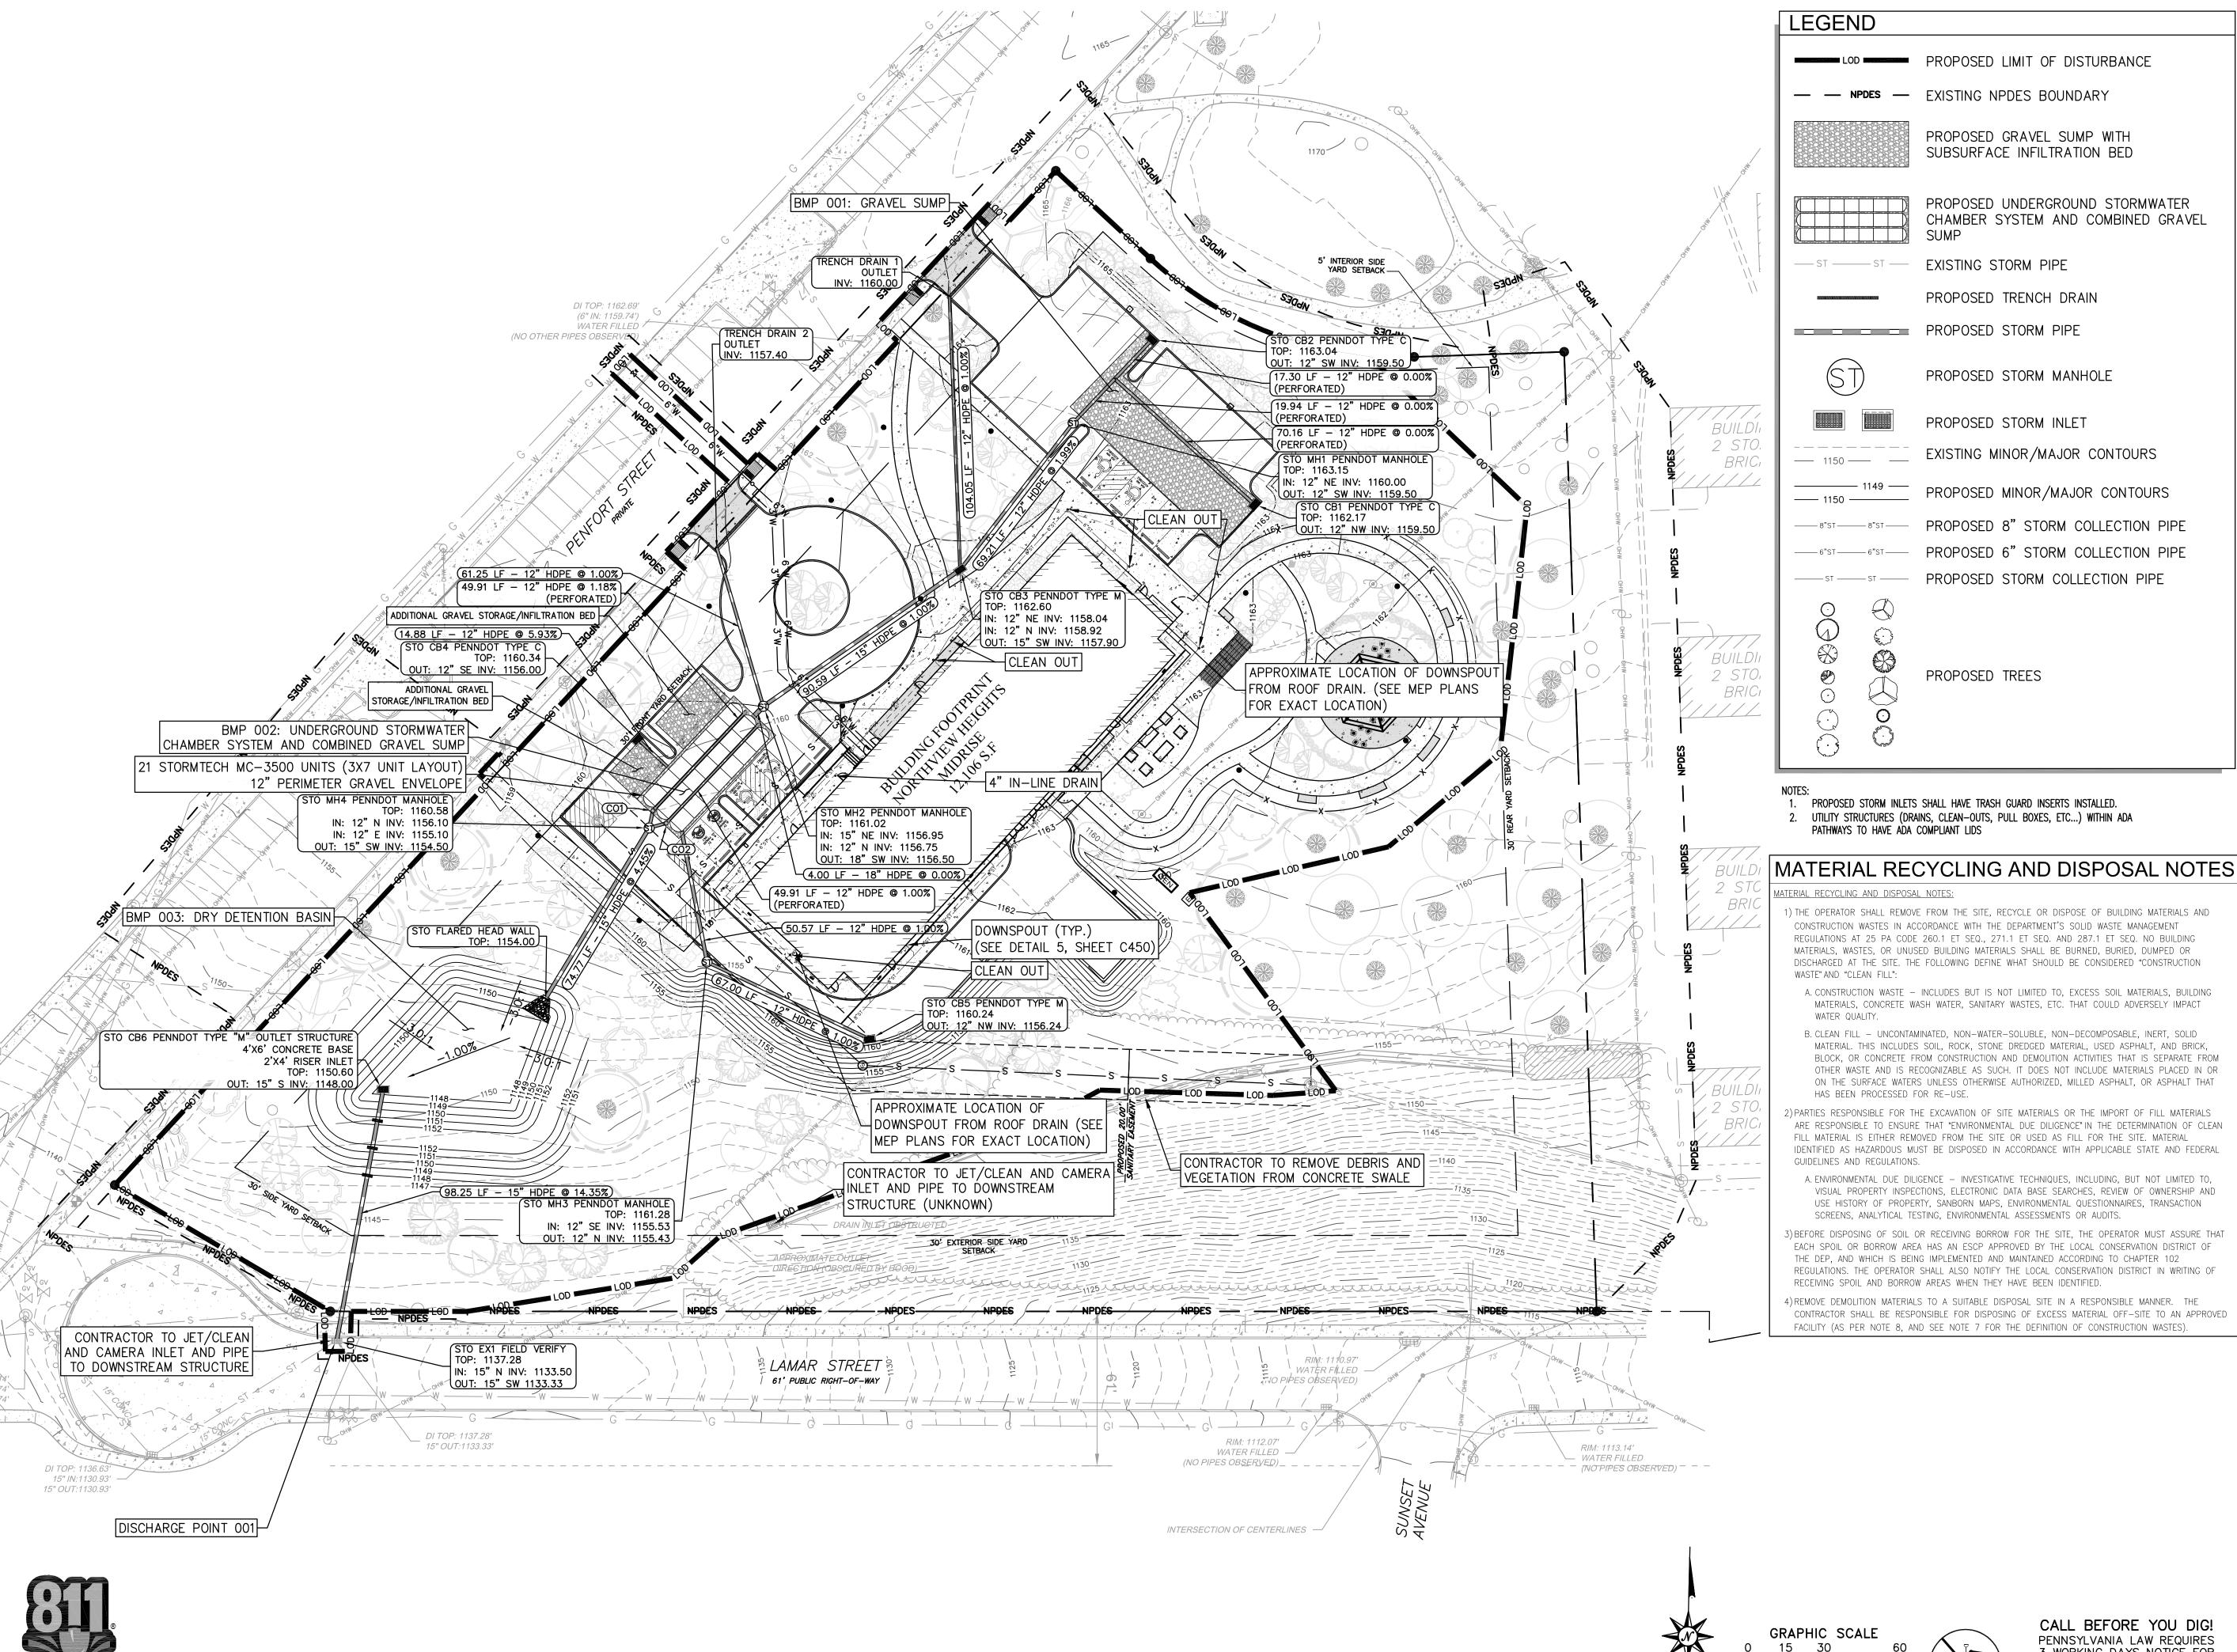

Know what's below.

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PA ONE CALL SERIAL NO. 20212440672 AS PER CALL FOR MAPS BY RED SWING GROUP SEPTEMBER 1st 202

Fukui Architects Pc 205 Ross Street Pittsburgh, Pennsylvania 15219 ph 412.281.6001 fx 412.281.6002 PROPOSED GRAVEL SUMP WITH SUBSURFACE INFILTRATION BED ©2023 Fukui Architects, Pc PROPOSED UNDERGROUND STORMWATER CHAMBER SYSTEM AND COMBINED GRAVEL **ENGINEERS & SURVEYORS** PROPOSED TRENCH DRAIN 4314 OLD WILLIAM PENN HWY SUITE 101 MONROEVILLE, PA 15146 OFFICE: 724.325.1215 PROPOSED STORM MANHOLE PROPOSED STORM INLET EXISTING MINOR/MAJOR CONTOURS PROPOSED MINOR/MAJOR CONTOURS PROPOSED 6" STORM COLLECTION PIPE

SUMP

PROPOSED STORM COLLECTION PIPE

PROPOSED TREES

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project title

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Client:


Allies & Ross Management and Development Corporation (ARMDC) 200 Ross Street Pittsburgh, PA 15219

Project Location:


Northview Heights Midrise 246 Penfort Street Pittsburgh, PA 15214

drawing title

POST CONSTRUCTION STORMWATER MANAGEMENT **PLAN**

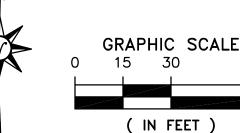

1 inch = 30 ft.

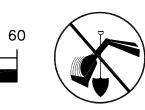

CALL BEFORE YOU DIG! PENNSYLVANIA LAW REQUIRES 3 WORKING DAYS NOTICE FOR CONSTRUCTION PHASE AND 10 WORKING DAYS NOTICE IN DESIGN STAGE. STOP CALL


PENNSYLVANIA ONE CALL SYSTEM, INC.


1-800-242-1776

December 3rd, 2023

As Noted

C400 Project #2040

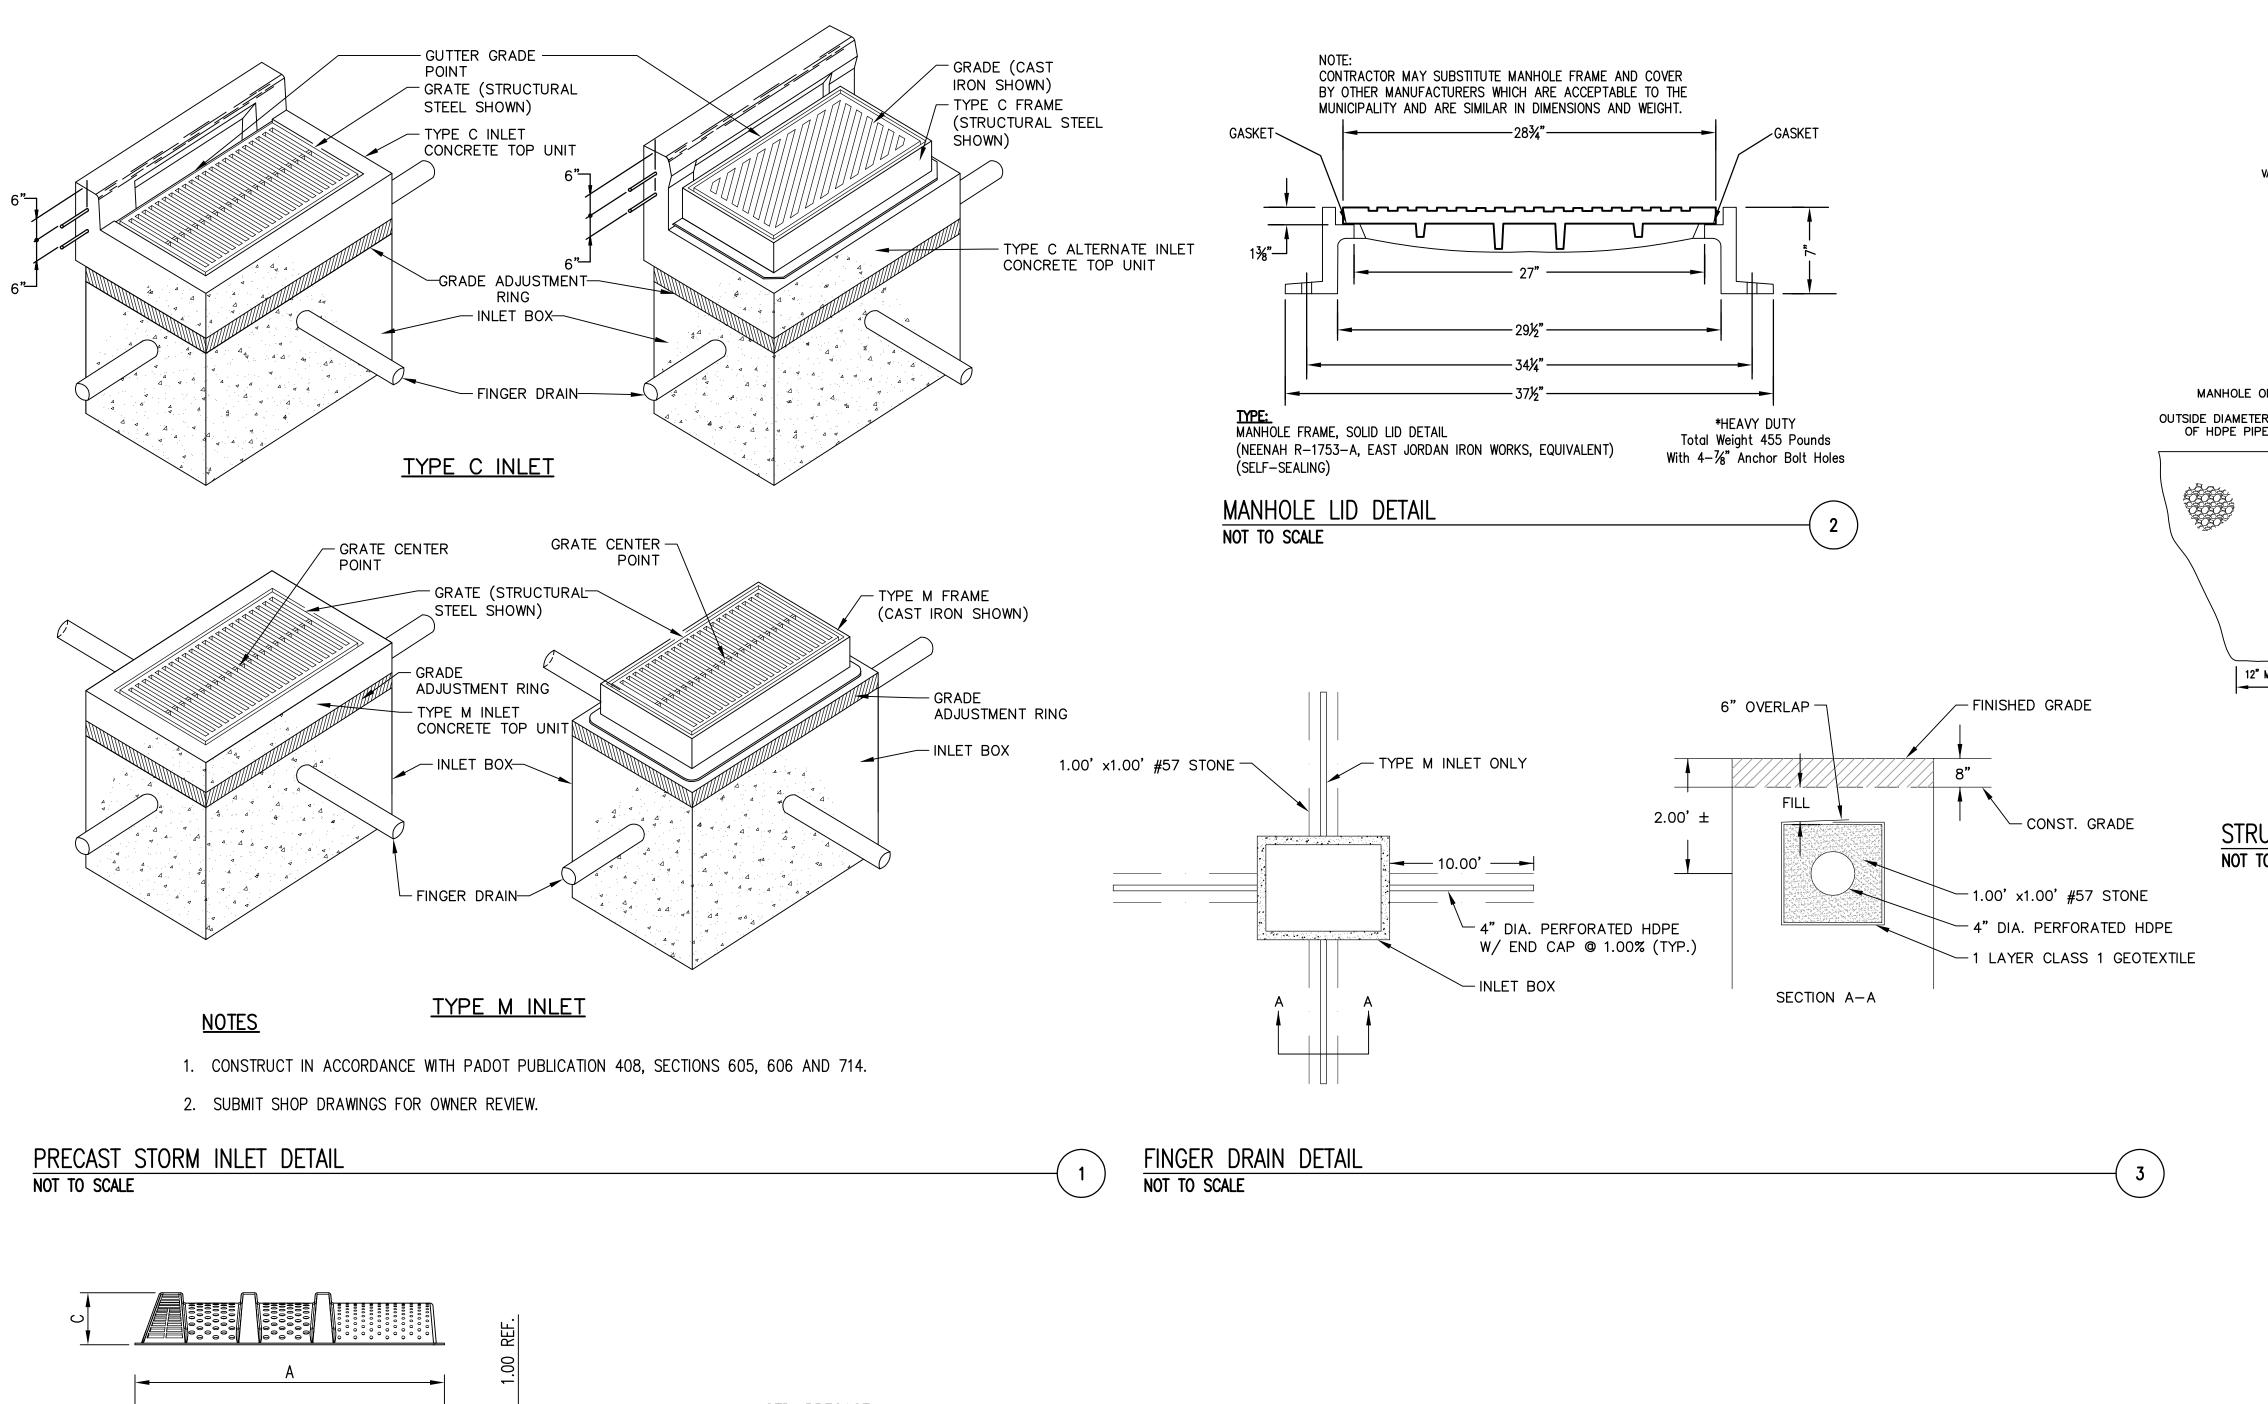

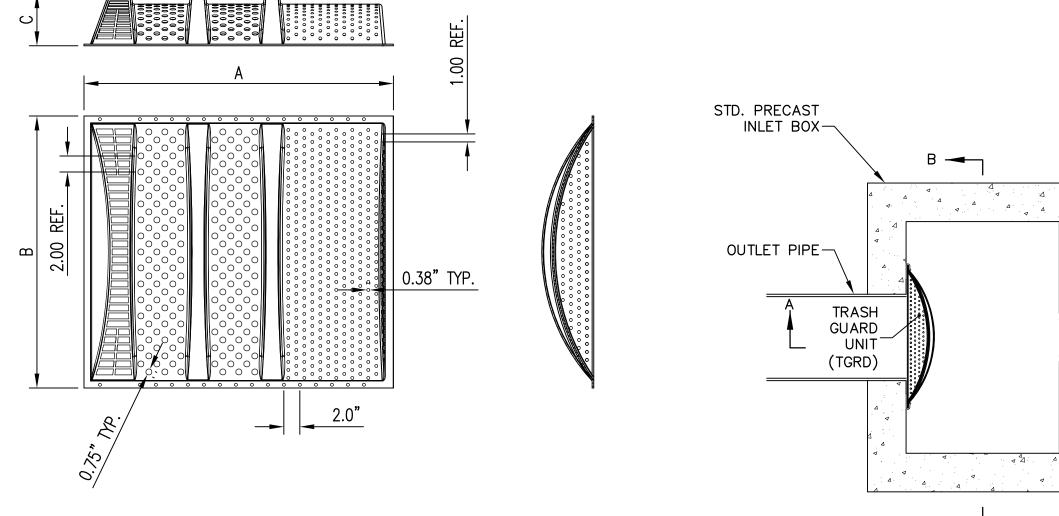

TRASHGUARD PLUS DIMENSIONS				
MODEL/SIZE	Α	В	С	OUTLET PIPE DIA.
TGRD23X24P	26.51"	23.00"	6.39"	≤15"
TGRD28X30P	33.15"	28.00"	6.29"	≤18"
TGRD34X36P	36.67"	34.00"	6.37"	≤24"


TRASHGUARD PLUS DETAIL


NOT TO SCALE

TRASH /- INLET PIPE GUARD -NO SUMP UNIT NEEDED (TGRD) OUTLET PIPE-GUARD UNIT - INLET PIPE (TGRD) _FROM SMP MIN. CLEARANCE SECTION B-B SECTION A-A SEAL WITH NON-SHRINK GROUT

- TRASH GUARD PLUS (TGRD) UNIT AND "PWD TGP HARDWARE KIT" TO BE PROVIDED BY ACF ENVIRONMENTAL SEE TRASH GUARD INSTALLATION DETAIL FOR GUIDANCE ON INSTALLING UNIT.
- 3. SEE TRASHGUARD UNIT DETAILS FOR SYSTEM DIMENSIONS AND AVAILABLE SIZES.
- 4. "RAIL STOP BOLT" NOT NEEDED FOR THIS APPLICATION
- 5. NO "SUMP" IS REQUIRED FOR THE TRASHGUARD PLUS TO FUNCTION CORRECTLY.

TRASHGUARD PLUS GREEN INLET DETAIL NOT TO SCALE

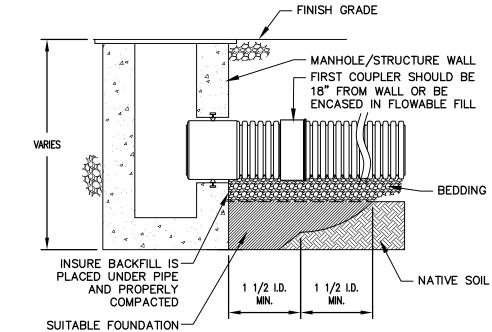

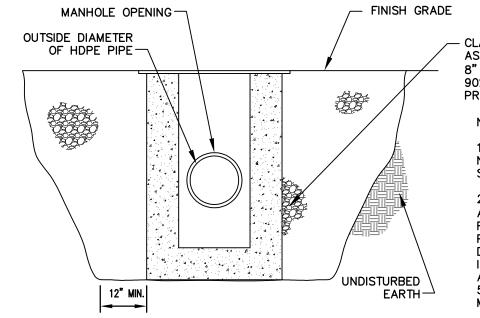


- CLASS I OR II BACKFILL PER ASTM D2321. COMPACTED IN 8" MAX. LIFTS TO A MIN. OF 90% MAX. STANDARD PROCTOR DENSITY

1. MAXIMUM INSERTION ANGLE SHALL NOT EXCEED REQUIREMENTS AS SPECIFIED BY THE MANUFACTURER. 2. SEE STANDARD DETAILS STD-202 AND 202A THROUGH STD-204 (A-F) FOR STRUCTURE CONNECTIONS, PRODUCT INFORMATION AND DIMENSIONAL PIPE DATA. INSTALLATION RECOMMENDATIONS ARE ALSO SPECIFIED IN TECHNICAL NOTE 5.04: HDPE CONNECTIONS TO MANHOLES AND STRUCTURES.

3. PERFORMANCE HIGHLY DEPENDENT ON INSTALLATION. CONTRACTOR MUST INSURE MANHOLE GASKET IS UNIFORMLY SEATED AROUND STRUCTURE ADAPTER. EXTRA PRECAUTIONSMUST BE TAKEN TO PREVENT DIFFERENTIAL SETTLEMENT BETWEEN THE PIPE AND MANHOLE.


STRUCTURE CONNECTION INSTALLATION DETAIL NOT TO SCALE

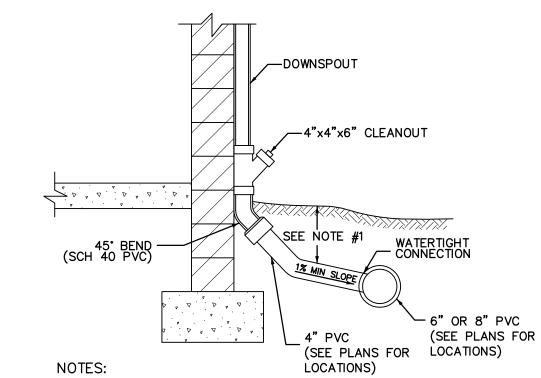

1. FOR ALL DEPTHS OF COVER LESS THAN 2 (2) FEET, PIPE MUST BE SCHEDULE 40 PVC. FOR DEPTHS OF COVER GREATER THAN TWO (2) FEET, FLEXIBLE PIPE MAY BE USED.

A WATERTIGHT CONNECTION SHALL BE MAINTAINED AT ALL TRANSITIONS FROM SCHEDULE 40 PVC TO ANY OTHER PIPE..



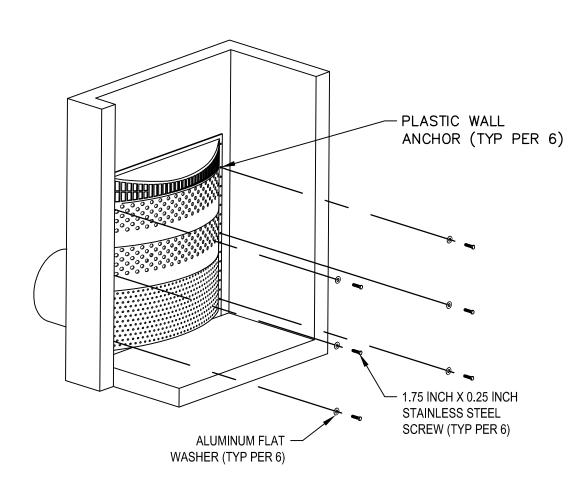


Fukui Architects Pc

205 Ross Street

Pittsburgh, Pennsylvania 15219 ph 412.281.6001 fx 412.281.6002

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revisions

project title

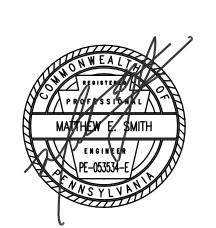Owner:

HACP 200 Ross Street Pittsburgh,PA,15219

Client:

Allies & Ross Management and Development Corporation (ARMDC) 200 Ross Street Pittsburgh, PA 15219

Project Location:

Northview Heights Midrise 246 Penfort Street Pittsburgh, PA 15214

drawing title


STORMWATER MANAGEMENT **DETAILS SHEET 1 OF 7**

scale As N	Noted	
date		
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no	of	

Sheet No.


C450 Project #2040

TRASHGUARD PLUS UNIT INSTALLATION DETAIL NOT TO SCALE

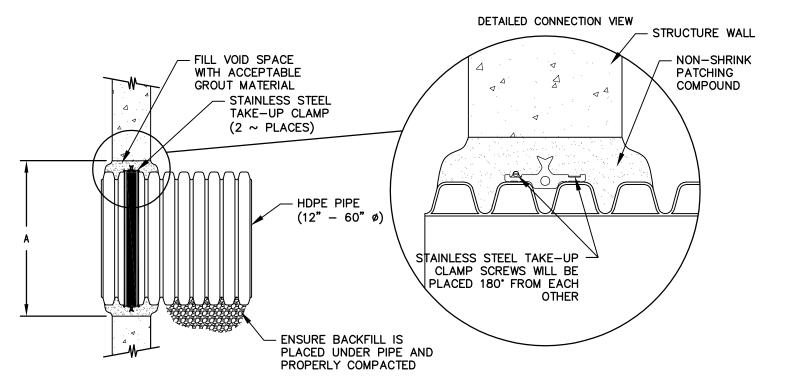

					NOTES:
	PIPE	E OD		MIN. DISTANCE PIPE	PERFORMANCE HIGHLY DEPENDENT ON INSTALLATION. CONTRACTOR
PIPE SIZE	A-PROFILE	H-PROFILE	"A" MIN. HOLE DIA.	INVERT TO STRUCTURE INVERT	MUST ENSURE MANHOLE GASKET IS UNIFORMLY SEATED AROUND STRUCTURE ADAPTER. EXTRA
12"	14.5"	N/A	19.5"	3.7"	PRECAUTIONS MUST BE TAKEN TO
15"	17.6"	N/A	23.00"	4.0"	PREVENT DIFFERENTIAL SETTLEMENT
18"	21.2"	N/A	26.50"	4.2"	BETWEEN THE PIPE AND
24"	27.8"	N/A	33.25"	4.5	STRUCTURE.
30"	35.1"	N/A	40.50"	5.2"	SEE STANDARD DETAIL WATERSTOP
36"	41.1"	41.1"	47.00"	5.5"	INSTALLATION FOR INSTALLATION
42"	47.7"	48.0"	53.00"	5.7"	RECOMMENDATIONS.
48"	53.6"	54.0 "	59.00"	5.7"	
60"	66.3"	67.3 "	72.00"	6.4"	FOLLOW MANUFACTURE
	-	-		•	SPECIFICATION IF VARIES FROM

12"-60" HDPE WATERSTOP GROUTED STRUCTURE CONNECTION NOT TO SCALE

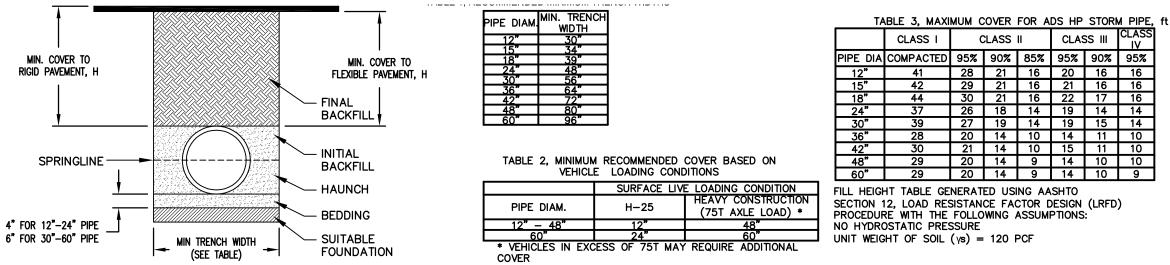

NOTES:

1. ALL PIPE SYSTEMS SHALL BE INSTALLED IN ACCORDANCE WITH ASTM D2321, "STANDARD PRACTICE FOR UNDERGROUND INSTALLATION OF THERMOPLASTIC PIPE FOR SEWERS AND OTHER GRAVITY FLOW APPLICATIONS". LATEST ADDITION. WITH THE EXCEPTION THAT THE INITIAL BACKFILL MAY EXTEND TO THE CROWN OF THE PIPE. SOIL CLASSIFICATIONS ARE PER THE LATEST VERSION OF ASTM D2321. CLASS IVB MATERIALS (MH, CH) AS DEFINED IN PREVIOUS VERSIONS OF ASTM D2321 ARE NOT APPROPRIATE BACKFILL MATERIALS.

2. MEASURES SHOULD BE TAKEN TO PREVENT MIGRATION OF NATIVE FINES INTO BACKFILL MATERIAL, WHEN REQUIRED


FOUNDATION: WHERE THE TRENCH BOTTOM IS UNSTABLE, THE CONTRACTOR SHALL EXCAVATE TO A DEPTH REQUIRED BY THE ENGINEER AND REPLACE WITH SUITABLE MATERIAL AS SPECIFIED BY THE ENGINEER. AS AN ALTERNATIVE AND AT THE DISCRETION OF THE DESIGN ENGINEER, THE TRENCH BOTTOM MAY BE STABILIZED USING A GEOTEXTILE MATERIAL. 4. BEDDING: SUITABLE MATERIAL SHALL BE CLASS I, II, III, OR IV. THE CONTRACTOR SHALL PROVIDE DOCUMENTATION FOR MATERIAL SPECIFICATION TO ENGINEER. COMPACTION SHALL BE SPECIFIED BY THE ENGINEER IN ACCORDANCE WITH TABLE 3 FOR THE APPLICABLE FILL HEIGHTS LISTED. UNLESS OTHERWISE NOTED BY THE ENGINEER, MINIMUM BEDDING THICKNESS SHALL BE 4" (100mm) FOR 12"-24" (300mm-600mm) DIAMETER PIPE; 6" (150mm) FOR 30"-60" (750mm-1500mm) DIAMETER PIPE. THE MIDDLE 1/3 BENEATH THE PIPE INVERT SHALL BE LOOSELY PLACED. PLEASE NOTE, CLASS IV MATERIAL HAS IMITED APPLICATION AND CAN BE DIFFICULT TO PLACE AND COMPACT; USE ONLY WITH THE APPROVAL OF A SOIL EXPERT.

5. <u>INITIAL BACKFILL:</u> SUITABLE MATERIAL SHALL BE CLASS I, II, III, OR IV IN THE PIPE ZONE EXTENDING TO THE CROWN OF THE PIPE. THE CONTRACTOR SHALL PROVIDE DOCUMENTATION FOR MATERIAL SPECIFICATION TO ENGINEER. MATERIAL SHALL BE INSTALLED AS REQUIRED IN ASTM D2321, LATEST EDITION. COMPACTION SHALL BE SPECIFIED BY THE ENGINEER IN ACCORDANCE WITH TABLE 3 FOR THE APPLICABLE FILL HEIGHTS LISTED. PLEASE NOTE, CLASS IV MATERIAL HAS LIMITED APPLICATION AND CAN BE DIFFICULT TO PLACE AND COMPACT; USE ONLY WITH THE APPROVAL OF A SOIL EXPERT.

6. MINIMUM COVER; MINIMUM COVER, H, IN NON-TRAFFIC APPLICATIONS (GRASS OR LANDSCAPE AREAS) IS 12" (300mm) FROM THE TOP OF PIPE TO GROUND SURFACE. ADDITIONAL COVER MAY BE REQUIRED TO PREVENT FLOTATION. FOR TRAFFIC APPLICATIONS; CLASS I OR II MATERIAL COMPACTED TO 90% SPD AND CLASS III COMPACTED TO 95% SPD IS REQUIRED. FOR TRAFFIC APPLICATIONS, MINIMUM COVER, H, IS 12" (300mm) UP TO 48" (1200mm) DIAMETER PIPE AND 24" (600mm) OF COVER FOR 60" (1500mm) DIAMETER PIPE, MEASURED FROM TOP OF PIPE TO BOTTOM OF FLEXIBLE PAVEMENT OR TO TOP OF RIGID PAVEMENT.

7. FOR ADDITIONAL INFORMATION SEE TECHNICAL NOTE 2.04. HP STORM TRENCH INSTALLATION DETAIL

NOT TO SCALE

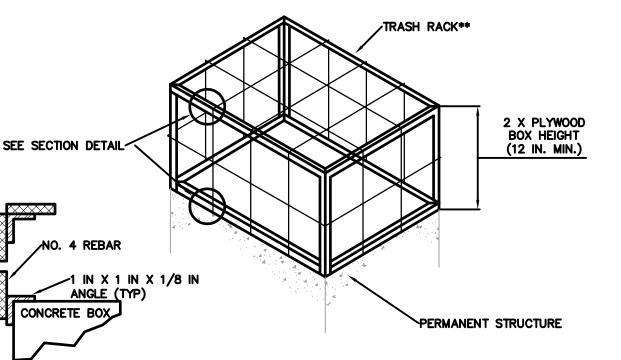

SECTION DETAIL

* 3/4 IN. PRESSURE TREATED PLYWOOD BOX WITH 2 IN. X 2 IN. PRESSURE TREATED CORNER SUPPORTS, SET INTO 1-1/2 IN. GRATE OFFSETS, CAULK ALL SEAMS TO FORM WATERTIGHT SEALS. ** TRASH RACK COMPOSED OF 1 IN. X 1 IN. X 1/8 IN. L (TYP.) AND #4 BARS (TYP.) WELDED TO THE ANGLES AND AT EACH INTERSECTION OF THE BARS; #4 BARS SPACED AT HALF THE DIAMETER OF THE BARREL MAX.

NOT TO SCALE

BOX SHALL BE BOLTED, STRAPPED, OR OTHERWISE SECURED TO THE PERMANENT RISER.

CLOGGED OR DAMAGED SPILLWAYS SHALL BE REPAIRED IMMEDIATELY. TRASH AND OTHER DEBRIS SHALL BE REMOVED FROM THE BASIN AND RISER.

STANDARD CONSTRUCTION DETAIL #7-10 TRASH RACK FOR PERMANENT STRUCTURE

0% SLOPE - GEOTEXTILE SECTION Y-Y Atw - GEOTEXTILE SECTION Z-Z PLAN VIEW

1		חוחר	RIPRAP		APRON		
	OUTLET NO.	PIPE DIA Pd (IN)	SIZE R	THICK. Rt (IN)	LENGTH AI (FT)	INITIAL WIDTH Aiw (FT)	TERMINAL WIDTH Atw (FT)
	1	15	5	27	8	4	12


ALL APRONS SHALL BE CONSTRUCTED TO THE DIMENSIONS SHOWN. TERMINAL WIDTHS SHALL BE ADJUSTED AS NECESSARY TO MATCH RECEIVING CHANNELS.

ALL APRONS SHALL BE INSPECTED AT LEAST WEEKLY AND AFTER EACH RUNOFF EVENT. DISPLACED RIPRAP WITHIN THE APRON SHALL BE REPLACED IMMEDIATELY STANDARD CONSTRUCTION DETAIL #9-1

RIPRAP APRON AT PIPE OUTLET WITH FLARED END SECTION OR ENDWALL NOT TO SCALE

RIPRAP APRON AT PIPE OUTLET

WITH FLARED END SECTION OR ENDWALL NOT TO SCALE

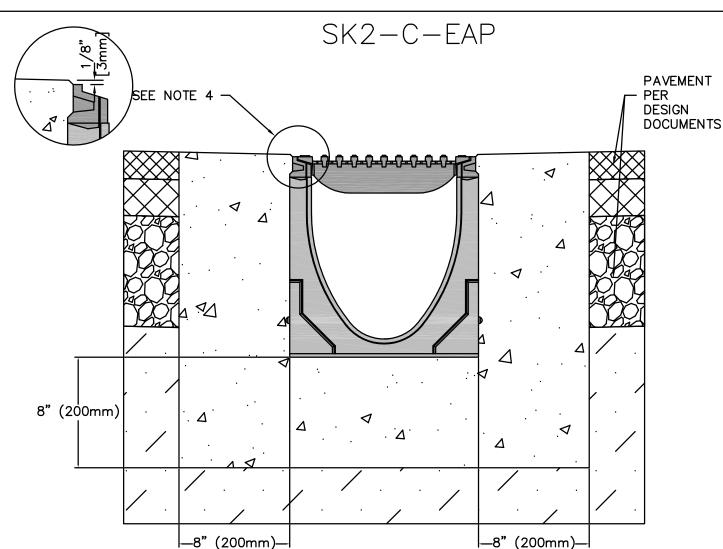

NOTES:

1. IT IS NECESSARY TO ENSURE MINIMUM DIMENSIONS SHOWN ARE SUITABLE FOR EXISTING GROUND CONDITIONS. ENGINEERING ADVICE MAY BE REQUIRED.

2. MINIMUM CONCRETE STRENGTH OF 4,000 PSI IS RECOMMENDED. CONCRETE SHOULD BE VIBRATED TO ELIMINATE AIR POCKETS. 3. EXPANSION AND CONTRACTION CONTROL JOINTS AND REINFORCEMENT ARE RECOMMENDED TO PROTECT CHANNEL AND CONCRETE SURROUND. ENGINEERING ADVICE MAY BE REQUIRED.

 \cdot . THE FINISHED LEVEL OF THE CONCRETE SURROUND MUST BE APPROX. 1/8" [3 mm] ABOVE THE TOP OF THE CHANNEL EDGE. 5. CONCRETE BASE THICKNESS SHOULD MATCH SLAB THICKNESS. ENGINEERING ADVICE MAY BE REQUIRED TO

DETERMINE PROPER LOAD CLASS. 6. REFER TO ACO'S LATEST INSTALLATION INSTRUCTIONS FOR FURTHER DETAILS. **SPECIFICATION CLAUSE**

POWERDRAIN S200K - LOAD CLASS C

<u>GENERAL</u> THE SURFACE DRAINAGE SYSTEM SHALL BE POLYMER CONCRETE S200K CHANNEL SYSTEM WITH DUCTILE IRON EDGE RAILS AS MANUFACTURED BY ACO POLYMER PRODUCTS, INC.


CHANNELS SHALL BE MANUFACTURED FROM POLYESTER RESIN POLYMER CONCRETE WITH AN INTEGRALLY CAST-IN DUCTILE IRON EDGE RAIL. MINIMUM PROPERTIES OF POLYMER CONCRETE WILL BE AS FOLLOWS: COMPRESSIVE STRENGTH 14,000 PSI

FLEXURAL STRENGTH: 4,000 PSI TENSILE STRENGTH: 1,500 PSI WATER ABSORPTION: 0.07% FROST PROOF YES DILUTE ACID AND ALKALI RESISTANT B117 SALT SPRAY TEST COMPLIANT

THE SYSTEM SHALL BE 8" (200mm) NOMINAL INTERNAL WIDTH WITH A 10.2" (260mm) OVERALL WIDTH AND A BUILT-IN SLOPE OF 0.5%. CHANNEL INVERT SHALL HAVE DEVELOPED "V" SHAPE. ALL CHANNELS SHALL BE INTERLOCKING WITH A MALE/FEMALE JOINT.

THE COMPLETE DRAINAGE SYSTEM SHALL BE BY ACO POLYMER PRODUCTS, INC. ANY DEVIATION OR PARTIAL SYSTEM DESIGN AND/OR IMPROPER INSTALLATION WILL VOID ANY AND ALL WARRANTIES PROVIDED BY ACO POLYMER PRODUCTS, INC.

CHANNEL SHALL WITHSTAND LOADING TO PROPER LOAD CLASS AS OUTLINED BY EN 1433. GRATE TYPE SHALL BE APPROPRIATE TO MEET THE SYSTEM LOAD CLASS SPECIFIED AND INTENDED APPLICATION. GRATES SHALL BE SECURED USING EITHER THE 'POWERLOK' BOLTLESS LOCKING SYSTEM OR THE 4 BOLT LOCKING OPTION. CHANNEL AND GRATE SHALL BE CERTIFIED TO MEET THE SPECIFIED EN 1433 LOAD CLASS. THE SYSTEM SHALL BE INSTALLED IN ACCORDANCE WITH THE MANUFACTURER'S INSTRUCTIONS AND RECOMMENDATIONS.

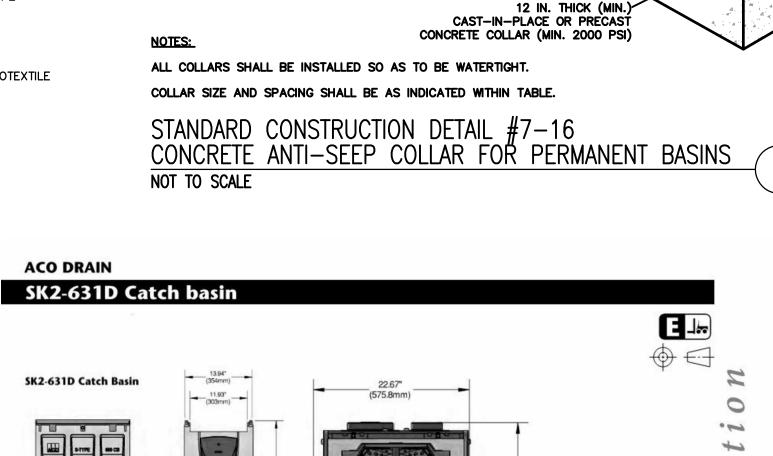

riser to First

COLLAR


COLLARS

SPACING


PROVIDE~

WATERTIGHT

CONNECTION

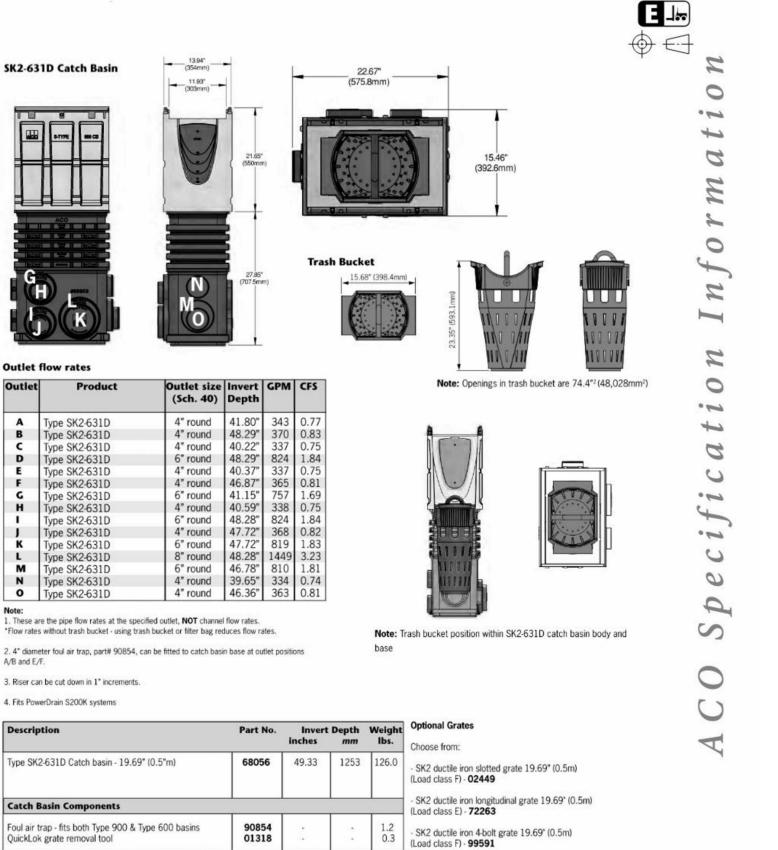




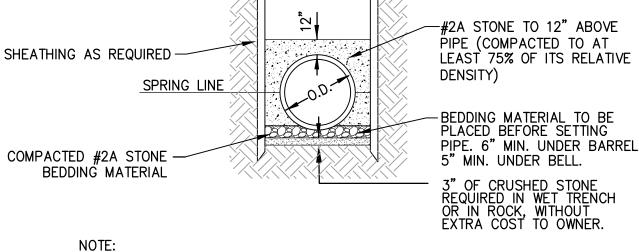

1) THE TRENCH WALL SHALL BE SUBSTANTIALLY VERTICAL IN THE PIPE ZONE. MAXIMUM TRENCH WIDTH SHALL BE OD + 24 INCHES AND MINIMUM TRENCH

PIPE ZONE DETAIL - STORM NOT TO SCALE

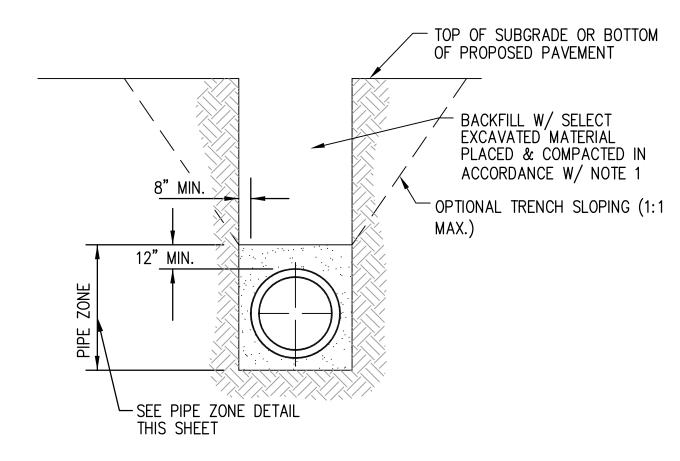

TRENCH SECTION - STORM NOT TO SCALE

STRUCTURE TABLE STRUCTURE NAME | STRUCTURE TYPE | STRUCTURE DETAILS PIPES IN PIPES OUT SURFACE ELEV. = 1162.17 12" Corrugated HDPE Pipe PENNDOT TYPE C SUMP = 1159.5INV OUT =1159.50 INV OUT = 1159.50SURFACE ELEV. = 1163.04 12" Corrugated HDPE Pipe PENNDOT TYPE C CB2 SUMP = 1159.5INV OŬT =1159.50 INV OUT = 1159.50SURFACE ELEV. = 1162.60 | 12" CORRUGATED HDPE PIPE SUMP = 1157.9INV IN =1158.04 15" Corrugated HDPE Pipe CB3 PENNDOT TYPE M INV IN = 1158.04INV OŬT =1157.90 12" HDPE PIPE INV IN = 1158.92INV IN =1158.92 INV OUT = 1157.90SURFACE ELEV. = 1160.34 12" HDPE Pipe INV OUT =1156.00 CB4 PENNDOT TYPE C SUMP = 1156.0INV OUT = 1156.00SURFACE ELEV. = 1160.24 12" HDPE Pipe CB5 PENNDOT TYPE M SUMP = 1156.2INV OUT =1156.24 INV OUT = 1156.24SURFACE ELEV. = 1150.60 15" Corrugated HDPE Pipe PENNDOT TYPE M CB6 SUMP = 1148.0INV OŬT =1148.00 INV OUT = 1148.00SURFACE ELEV. = 1160.53 SUMP = 1156.0CORRUGATED HDPE PIPE 12" Corrugated HDPE Pipe CO1 CLEANOUT INV IN = 1156.08INV IN =1156.08 INV OUT =1155.98 INV OUT = 1155.98SURFACE ELEV. = 1160.58 SUMP = 1154.512" HDPE PIPE 12" HDPE Pipe CO2 CLEANOUT INV OUT =1155.20 INV IN = 1154.46INV IN =1154.46 INV OUT = 1155.20SURFACE ELEV. = 1163.15 12" Corrugated HDPE Pipe SUMP = 1159.5CORRUGATED HDPE PIPE PENNDOT MANHOLE INV IN = 1160.00INV OUT =1159.50 INV IN = 1160.00INV OUT = 1159.50SURFACE ELEV. = 1161.02 ' CORRUGATED HDPE PIPE SUMP = 1156.5INV IN =1156.95 18" Corrugated HDPE Pipe PENNDOT MANHOLE INV IN = 1156.95INV OUT =1156.50 12" HDPE PIPE INV IN = 1156.75INV OUT = 1156.50SURFACE ELEV. = 1161.28 12" Concrete Pipe INV OUT =1155.43 SUMP = 1155.412" HDPE PIPE PENNDOT MANHOLE MH3 INV IN =1155.53 INV IN = 1155.53INV OUT = 1155.43SURFACE ELEV. = 1160.58 CORRUGATED HDPE PIPE SUMP = 1152.5INV IN =1156.10 15" Corrugated HDPE Pipe PENNDOT MANHOLE MH4 INV IN = 1156.1012" HDPE PIPE INV OUT =1154.50 INV IN = 1155.10INV OUT = 1154.50SURFACE ELEV. = 1163.02 12" HDPE Pipe TD1 TRENCH DRAIN SUMP = 1160.0INV OUT =1160.00 INV OUT = 1160.00SURFACE ELEV. = 1160.88 12" HDPE Pipe TD2 TRENCH DRAIN SUMP = 1157.4

INV OUT = 1157.40


STORM STRUCTURE AND PIPE SCHEDULE

Fukui Architects Pc

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OFFICE: 724.325.1215



general notes

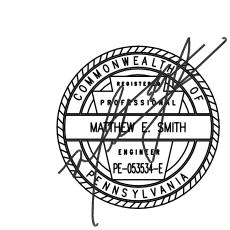Any conflicts in the drawings or between new and existing construction shall be referred to the Architect.

2. Contractor shall verify all dimensions and existing conditions in the field and shall advise Fukui Architects. Pc of any discrepancies between, additions to, deletions from, or alterations to any and all conditions prior to proceeding with any phase of work. Do not scale

3. All work shall be installed in accordance with applicable codes and regulations.

4. Contractor shall be responsible for the patching, repairing and preparations of all existing floor, wall, and ceiling surfaces as required to receive scheduled finishes.

5. All items shown on drawings are finished construction assemblies. Contractor shall provide and install all material required for finished assemblies.

6. All reports, plans, specifications, computer files, field data, notices, and other documents and instruments prepared by the Architect as instruments of service shall remain the property of the Architect. The Architect shall retain all common law statutory, and other reserved rights, including the copyright thereto.

revisions

project title

Owner: HACP

200 Ross Street Pittsburgh, PA, 15219

Client:

Allies & Ross Management and Development Corporation (ARMDC) 200 Ross Street Pittsburgh, PA 15219

Project Location:

Northview Heights Midrise 246 Penfort Street Pittsburgh, PA 15214

drawing title

STORMWATER MANAGEMENT **DETAILS SHEET 2 OF 7**


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INV OUT =1157.40

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Project #2040

TRENCH DRAIN DETAIL NOT TO SCALE



NOT TO SCALE

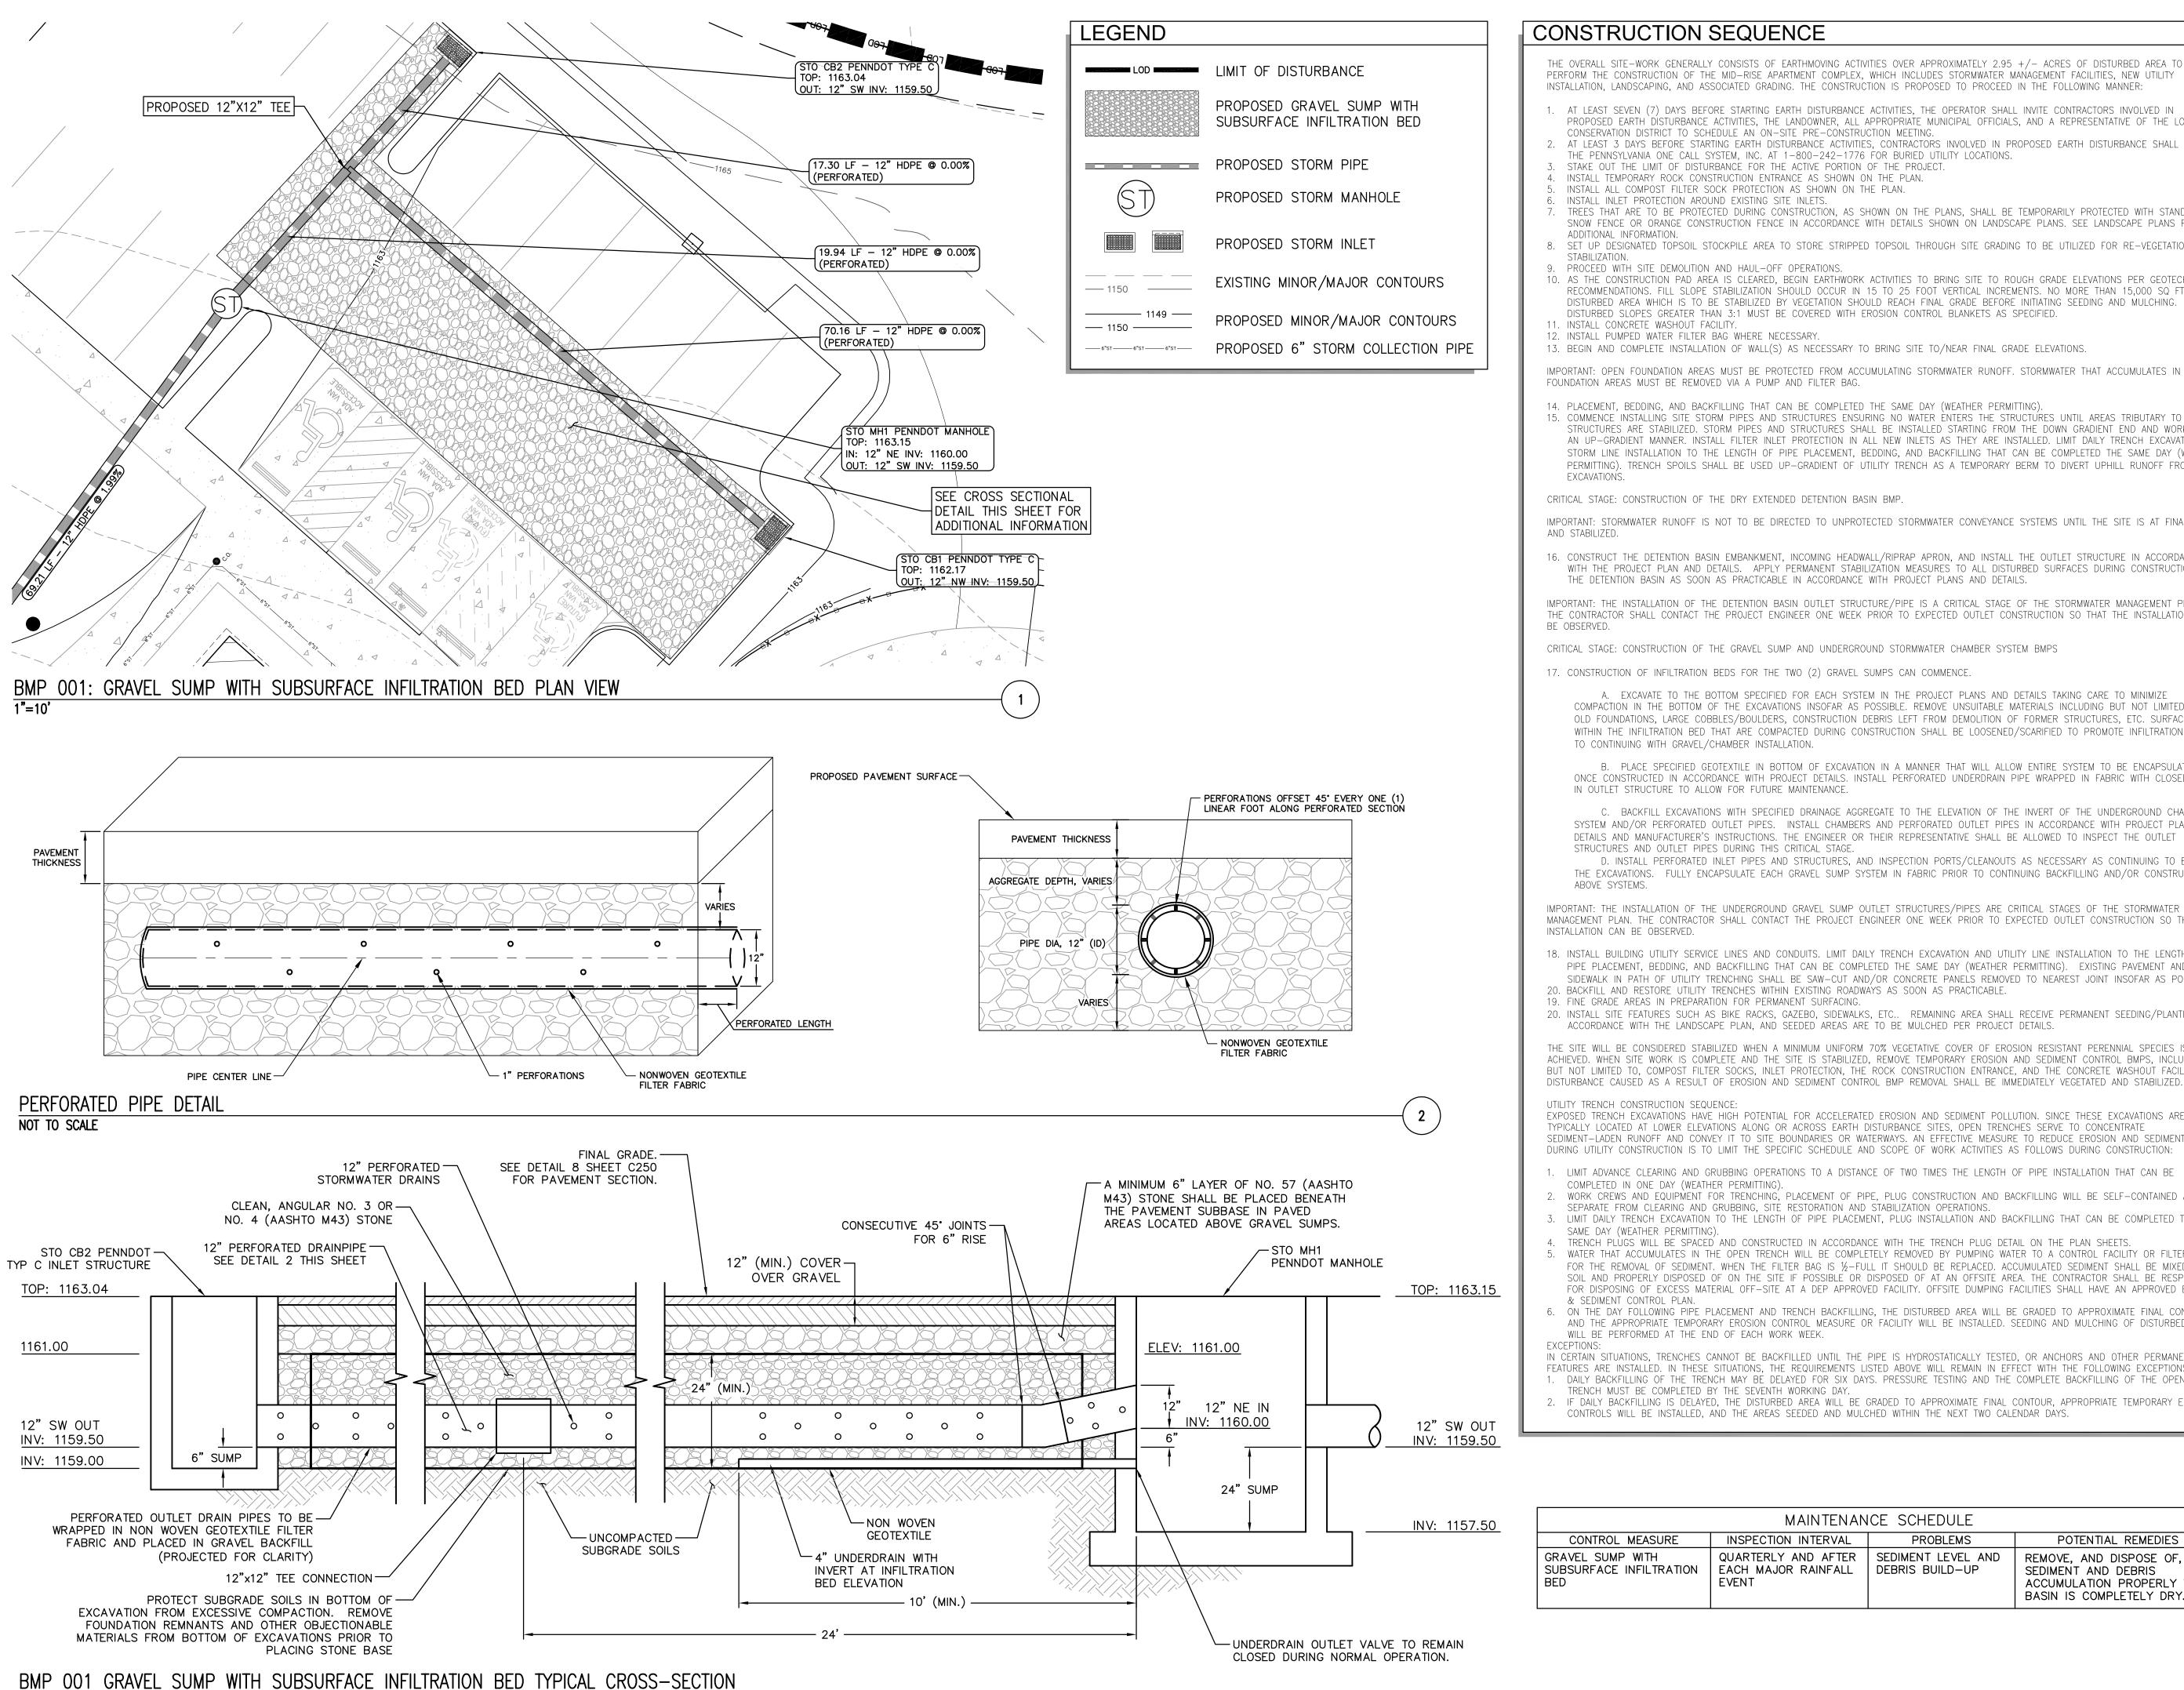CONSTRUCTION SEQUENCE

THE OVERALL SITE-WORK GENERALLY CONSISTS OF EARTHMOVING ACTIVITIES OVER APPROXIMATELY 2.95 +/- ACRES OF DISTURBED AREA TO PERFORM THE CONSTRUCTION OF THE MID-RISE APARTMENT COMPLEX, WHICH INCLUDES STORMWATER MANAGEMENT FACILITIES, NEW UTILITY INSTALLATION, LANDSCAPING, AND ASSOCIATED GRADING. THE CONSTRUCTION IS PROPOSED TO PROCEED IN THE FOLLOWING MANNER:

- 1. AT LEAST SEVEN (7) DAYS BEFORE STARTING EARTH DISTURBANCE ACTIVITIES, THE OPERATOR SHALL INVITE CONTRACTORS INVOLVED IN PROPOSED EARTH DISTURBANCE ACTIVITIES, THE LANDOWNER, ALL APPROPRIATE MUNICIPAL OFFICIALS, AND A REPRESENTATIVE OF THE LOCAL
- CONSERVATION DISTRICT TO SCHEDULE AN ON-SITE PRE-CONSTRUCTION MEETING. 2. AT LEAST 3 DAYS BEFORE STARTING EARTH DISTURBANCE ACTIVITIES, CONTRACTORS INVOLVED IN PROPOSED EARTH DISTURBANCE SHALL NOTIFY THE PENNSYLVANIA ONE CALL SYSTEM, INC. AT 1-800-242-1776 FOR BURIED UTILITY LOCATIONS.
- 3. STAKE OUT THE LIMIT OF DISTURBANCE FOR THE ACTIVE PORTION OF THE PROJECT. 4. INSTALL TEMPORARY ROCK CONSTRUCTION ENTRANCE AS SHOWN ON THE PLAN.
- 5. INSTALL ALL COMPOST FILTER SOCK PROTECTION AS SHOWN ON THE PLAN.
- . INSTALL INLET PROTECTION AROUND EXISTING SITE INLETS.
- TREES THAT ARE TO BE PROTECTED DURING CONSTRUCTION, AS SHOWN ON THE PLANS, SHALL BE TEMPORARILY PROTECTED WITH STANDARD SNOW FENCE OR ORANGE CONSTRUCTION FENCE IN ACCORDANCE WITH DETAILS SHOWN ON LANDSCAPE PLANS. SEE LANDSCAPE PLANS FOR
- 8. SET UP DESIGNATED TOPSOIL STOCKPILE AREA TO STORE STRIPPED TOPSOIL THROUGH SITE GRADING TO BE UTILIZED FOR RE-VEGETATION AND
- 10. AS THE CONSTRUCTION PAD AREA IS CLEARED, BEGIN EARTHWORK ACTIVITIES TO BRING SITE TO ROUGH GRADE ELEVATIONS PER GEOTECHNICAL RECOMMENDATIONS. FILL SLOPE STABILIZATION SHOULD OCCUR IN 15 TO 25 FOOT VERTICAL INCREMENTS. NO MORE THAN 15,000 SQ FT OF DISTURBED AREA WHICH IS TO BE STABILIZED BY VEGETATION SHOULD REACH FINAL GRADE BEFORE INITIATING SEEDING AND MULCHING.
- DISTURBED SLOPES GREATER THAN 3:1 MUST BE COVERED WITH EROSION CONTROL BLANKETS AS SPECIFIED. 11. INSTALL CONCRETE WASHOUT FACILITY.
- 12. INSTALL PUMPED WATER FILTER BAG WHERE NECESSARY. 13. BEGIN AND COMPLETE INSTALLATION OF WALL(S) AS NECESSARY TO BRING SITE TO/NEAR FINAL GRADE ELEVATIONS.

IMPORTANT: OPEN FOUNDATION AREAS MUST BE PROTECTED FROM ACCUMULATING STORMWATER RUNOFF. STORMWATER THAT ACCUMULATES IN OPEN FOUNDATION AREAS MUST BE REMOVED VIA A PUMP AND FILTER BAG.

14. PLACEMENT, BEDDING, AND BACKFILLING THAT CAN BE COMPLETED THE SAME DAY (WEATHER PERMITTING). 15. COMMENCE INSTALLING SITE STORM PIPES AND STRUCTURES ENSURING NO WATER ENTERS THE STRUCTURES UNTIL AREAS TRIBUTARY TO THE STRUCTURES ARE STABILIZED. STORM PIPES AND STRUCTURES SHALL BE INSTALLED STARTING FROM THE DOWN GRADIENT END AND WORKING IN AN UP-GRADIENT MANNER. INSTALL FILTER INLET PROTECTION IN ALL NEW INLETS AS THEY ARE INSTALLED. LIMIT DAILY TRENCH EXCAVATION AND STORM LINE INSTALLATION TO THE LENGTH OF PIPE PLACEMENT, BEDDING, AND BACKFILLING THAT CAN BE COMPLETED THE SAME DAY (WEATHER PERMITTING). TRENCH SPOILS SHALL BE USED UP-GRADIENT OF UTILITY TRENCH AS A TEMPORARY BERM TO DIVERT UPHILL RUNOFF FROM

CRITICAL STAGE: CONSTRUCTION OF THE DRY EXTENDED DETENTION BASIN BMP.

IMPORTANT: STORMWATER RUNOFF IS NOT TO BE DIRECTED TO UNPROTECTED STORMWATER CONVEYANCE SYSTEMS UNTIL THE SITE IS AT FINAL GRADE AND STABILIZED.

16. CONSTRUCT THE DETENTION BASIN EMBANKMENT, INCOMING HEADWALL/RIPRAP APRON, AND INSTALL THE OUTLET STRUCTURE IN ACCORDANCE WITH THE PROJECT PLAN AND DETAILS. APPLY PERMANENT STABILIZATION MEASURES TO ALL DISTURBED SURFACES DURING CONSTRUCTION OF THE DETENTION BASIN AS SOON AS PRACTICABLE IN ACCORDANCE WITH PROJECT PLANS AND DETAILS.

IMPORTANT: THE INSTALLATION OF THE DETENTION BASIN OUTLET STRUCTURE/PIPE IS A CRITICAL STAGE OF THE STORMWATER MANAGEMENT PLAN. THE CONTRACTOR SHALL CONTACT THE PROJECT ENGINEER ONE WEEK PRIOR TO EXPECTED OUTLET CONSTRUCTION SO THAT THE INSTALLATION CAN BE OBSERVED.

CRITICAL STAGE: CONSTRUCTION OF THE GRAVEL SUMP AND UNDERGROUND STORMWATER CHAMBER SYSTEM BMPS

17. CONSTRUCTION OF INFILTRATION BEDS FOR THE TWO (2) GRAVEL SUMPS CAN COMMENCE.

A. EXCAVATE TO THE BOTTOM SPECIFIED FOR EACH SYSTEM IN THE PROJECT PLANS AND DETAILS TAKING CARE TO MINIMIZE COMPACTION IN THE BOTTOM OF THE EXCAVATIONS INSOFAR AS POSSIBLE. REMOVE UNSUITABLE MATERIALS INCLUDING BUT NOT LIMITED TO OLD FOUNDATIONS, LARGE COBBLES/BOULDERS, CONSTRUCTION DEBRIS LEFT FROM DEMOLITION OF FORMER STRUCTURES, ETC. SURFACES WITHIN THE INFILTRATION BED THAT ARE COMPACTED DURING CONSTRUCTION SHALL BE LOOSENED/SCARIFIED TO PROMOTE INFILTRATION PRIOR TO CONTINUING WITH GRAVEL/CHAMBER INSTALLATION.

B. PLACE SPECIFIED GEOTEXTILE IN BOTTOM OF EXCAVATION IN A MANNER THAT WILL ALLOW ENTIRE SYSTEM TO BE ENCAPSULATED ONCE CONSTRUCTED IN ACCORDANCE WITH PROJECT DETAILS. INSTALL PERFORATED UNDERDRAIN PIPE WRAPPED IN FABRIC WITH CLOSED VALVE IN OUTLET STRUCTURE TO ALLOW FOR FUTURE MAINTENANCE.

C. BACKFILL EXCAVATIONS WITH SPECIFIED DRAINAGE AGGREGATE TO THE ELEVATION OF THE INVERT OF THE UNDERGROUND CHAMBER SYSTEM AND/OR PERFORATED OUTLET PIPES. INSTALL CHAMBERS AND PERFORATED OUTLET PIPES IN ACCORDANCE WITH PROJECT PLANS AND DETAILS AND MANUFACTURER'S INSTRUCTIONS. THE ENGINEER OR THEIR REPRESENTATIVE SHALL BE ALLOWED TO INSPECT THE OUTLET STRUCTURES AND OUTLET PIPES DURING THIS CRITICAL STAGE.

D. INSTALL PERFORATED INLET PIPES AND STRUCTURES, AND INSPECTION PORTS/CLEANOUTS AS NECESSARY AS CONTINUING TO BACKFILL THE EXCAVATIONS. FULLY ENCAPSULATE EACH GRAVEL SUMP SYSTEM IN FABRIC PRIOR TO CONTINUING BACKFILLING AND/OR CONSTRUCTING ABOVE SYSTEMS.

MANAGEMENT PLAN. THE CONTRACTOR SHALL CONTACT THE PROJECT ENGINEER ONE WEEK PRIOR TO EXPECTED OUTLET CONSTRUCTION SO THAT THE INSTALLATION CAN BE OBSERVED.

18. INSTALL BUILDING UTILITY SERVICE LINES AND CONDUITS. LIMIT DAILY TRENCH EXCAVATION AND UTILITY LINE INSTALLATION TO THE LENGTH OF PIPE PLACEMENT, BEDDING, AND BACKFILLING THAT CAN BE COMPLETED THE SAME DAY (WEATHER PERMITTING). EXISTING PAVEMENT AND/OR SIDEWALK IN PATH OF UTILITY TRENCHING SHALL BE SAW-CUT AND/OR CONCRETE PANELS REMOVED TO NEAREST JOINT INSOFAR AS POSSIBLE. 20. BACKFILL AND RESTORE UTILITY TRENCHES WITHIN EXISTING ROADWAYS AS SOON AS PRACTICABLE. 19. FINE GRADE AREAS IN PREPARATION FOR PERMANENT SURFACING.

20. INSTALL SITE FEATURES SUCH AS BIKE RACKS, GAZEBO, SIDEWALKS, ETC.. REMAINING AREA SHALL RECEIVE PERMANENT SEEDING/PLANTING IN ACCORDANCE WITH THE LANDSCAPE PLAN, AND SEEDED AREAS ARE TO BE MULCHED PER PROJECT DETAILS.

THE SITE WILL BE CONSIDERED STABILIZED WHEN A MINIMUM UNIFORM 70% VEGETATIVE COVER OF EROSION RESISTANT PERENNIAL SPECIES IS ACHIEVED. WHEN SITE WORK IS COMPLETE AND THE SITE IS STABILIZED, REMOVE TEMPORARY EROSION AND SEDIMENT CONTROL BMPS, INCLUDING, BUT NOT LIMITED TO, COMPOST FILTER SOCKS, INLET PROTECTION, THE ROCK CONSTRUCTION ENTRANCE, AND THE CONCRETE WASHOUT FACILITY.

EXPOSED TRENCH EXCAVATIONS HAVE HIGH POTENTIAL FOR ACCELERATED EROSION AND SEDIMENT POLLUTION. SINCE THESE EXCAVATIONS ARE TYPICALLY LOCATED AT LOWER ELEVATIONS ALONG OR ACROSS EARTH DISTURBANCE SITES, OPEN TRENCHES SERVE TO CONCENTRATE SEDIMENT-LADEN RUNOFF AND CONVEY IT TO SITE BOUNDARIES OR WATERWAYS. AN EFFECTIVE MEASURE TO REDUCE EROSION AND SEDIMENTATION DURING UTILITY CONSTRUCTION IS TO LIMIT THE SPECIFIC SCHEDULE AND SCOPE OF WORK ACTIVITIES AS FOLLOWS DURING CONSTRUCTION:

- 1. LIMIT ADVANCE CLEARING AND GRUBBING OPERATIONS TO A DISTANCE OF TWO TIMES THE LENGTH OF PIPE INSTALLATION THAT CAN BE
- COMPLETED IN ONE DAY (WEATHER PERMITTING). 2. WORK CREWS AND EQUIPMENT FOR TRENCHING, PLACEMENT OF PIPE, PLUG CONSTRUCTION AND BACKFILLING WILL BE SELF-CONTAINED AND
- SEPARATE FROM CLEARING AND GRUBBING, SITE RESTORATION AND STABILIZATION OPERATIONS. 3. LIMIT DAILY TRENCH EXCAVATION TO THE LENGTH OF PIPE PLACEMENT, PLUG INSTALLATION AND BACKFILLING THAT CAN BE COMPLETED THE
- SAME DAY (WEATHER PERMITTING). 4. TRENCH PLÙGS WILL BE SPACED AND CONSTRUCTED IN ACCORDANCE WITH THE TRENCH PLUG DETAIL ON THE PLAN SHEFTS. 5. WATER THAT ACCUMULATES IN THE OPEN TRENCH WILL BE COMPLETELY REMOVED BY PUMPING WATER TO A CONTROL FACILITY OR FILTER BAG FOR THE REMOVAL OF SEDIMENT. WHEN THE FILTER BAG IS 1/2-FULL IT SHOULD BE REPLACED. ACCUMULATED SEDIMENT SHALL BE MIXED WITH SOIL AND PROPERLY DISPOSED OF ON THE SITE IF POSSIBLE OR DISPOSED OF AT AN OFFSITE AREA. THE CONTRACTOR SHALL BE RESPONSIBLE FOR DISPOSING OF EXCESS MATERIAL OFF-SITE AT A DEP APPROVED FACILITY. OFFSITE DUMPING FACILITIES SHALL HAVE AN APPROVED EROSION
- 6. ON THE DAY FOLLOWING PIPE PLACEMENT AND TRENCH BACKFILLING, THE DISTURBED AREA WILL BE GRADED TO APPROXIMATE FINAL CONTOUR, AND THE APPROPRIATE TEMPORARY EROSION CONTROL MEASURE OR FACILITY WILL BE INSTALLED. SEEDING AND MULCHING OF DISTURBED AREAS WILL BE PERFORMED AT THE END OF EACH WORK WEEK.
- IN CERTAIN SITUATIONS, TRENCHES CANNOT BE BACKFILLED UNTIL THE PIPE IS HYDROSTATICALLY TESTED, OR ANCHORS AND OTHER PERMANENT FEATURES ARE INSTALLED. IN THESE SITUATIONS, THE REQUIREMENTS LISTED ABOVE WILL REMAIN IN EFFECT WITH THE FOLLOWING EXCEPTIONS: 1. DAILY BACKFILLING OF THE TRENCH MAY BE DELAYED FOR SIX DAYS. PRESSURE TESTING AND THE COMPLETE BACKFILLING OF THE OPEN
- TRENCH MUST BE COMPLETED BY THE SEVENTH WORKING DAY. 2. IF DAILY BACKFILLING IS DELAYED, THE DISTURBED AREA WILL BE GRADED TO APPROXIMATE FINAL CONTOUR, APPROPRIATE TEMPORARY EROSION CONTROLS WILL BE INSTALLED, AND THE AREAS SEEDED AND MULCHED WITHIN THE NEXT TWO CALENDAR DAYS.


MAINTENANCE SCHEDULE							
CONTROL MEASURE	INSPECTION INTERVAL	PROBLEMS	POTENTIAL REMEDIES				
GRAVEL SUMP WITH SUBSURFACE INFILTRATION BED	QUARTERLY AND AFTER EACH MAJOR RAINFALL EVENT	SEDIMENT LEVEL AND DEBRIS BUILD—UP	REMOVE, AND DISPOSE OF, SEDIMENT AND DEBRIS ACCUMULATION PROPERLY WHEN BASIN IS COMPLETELY DRY.				

Fukui Architects Pc

205 Ross Street


Pittsburgh, Pennsylvania 15219

ph 412.281.6001 fx 412.281.6002

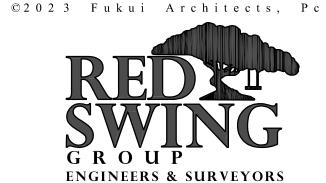

4314 OLD WILLIAM PENN HWY SUITE 101 MONROEVILLE, PA 15146

OFFICE: 724.325.1215

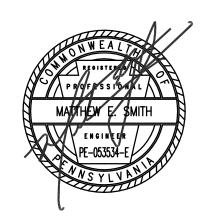

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revisions

project title

Owner:

HACP 200 Ross Street

Pittsburgh, PA, 15219

Client:

Allies & Ross Management and Development Corporation (ARMDC) 200 Ross Street Pittsburgh, PA 15219

Project Location:


Northview Heights Midrise 246 Penfort Street Pittsburgh, PA 15214

drawing title

STORMWATER MANAGEMENT **DETAILS AND PROFILES** SHEET 3 OF 7

Sheet No. As Noted December 3rd, 2023

C452 Project #2040

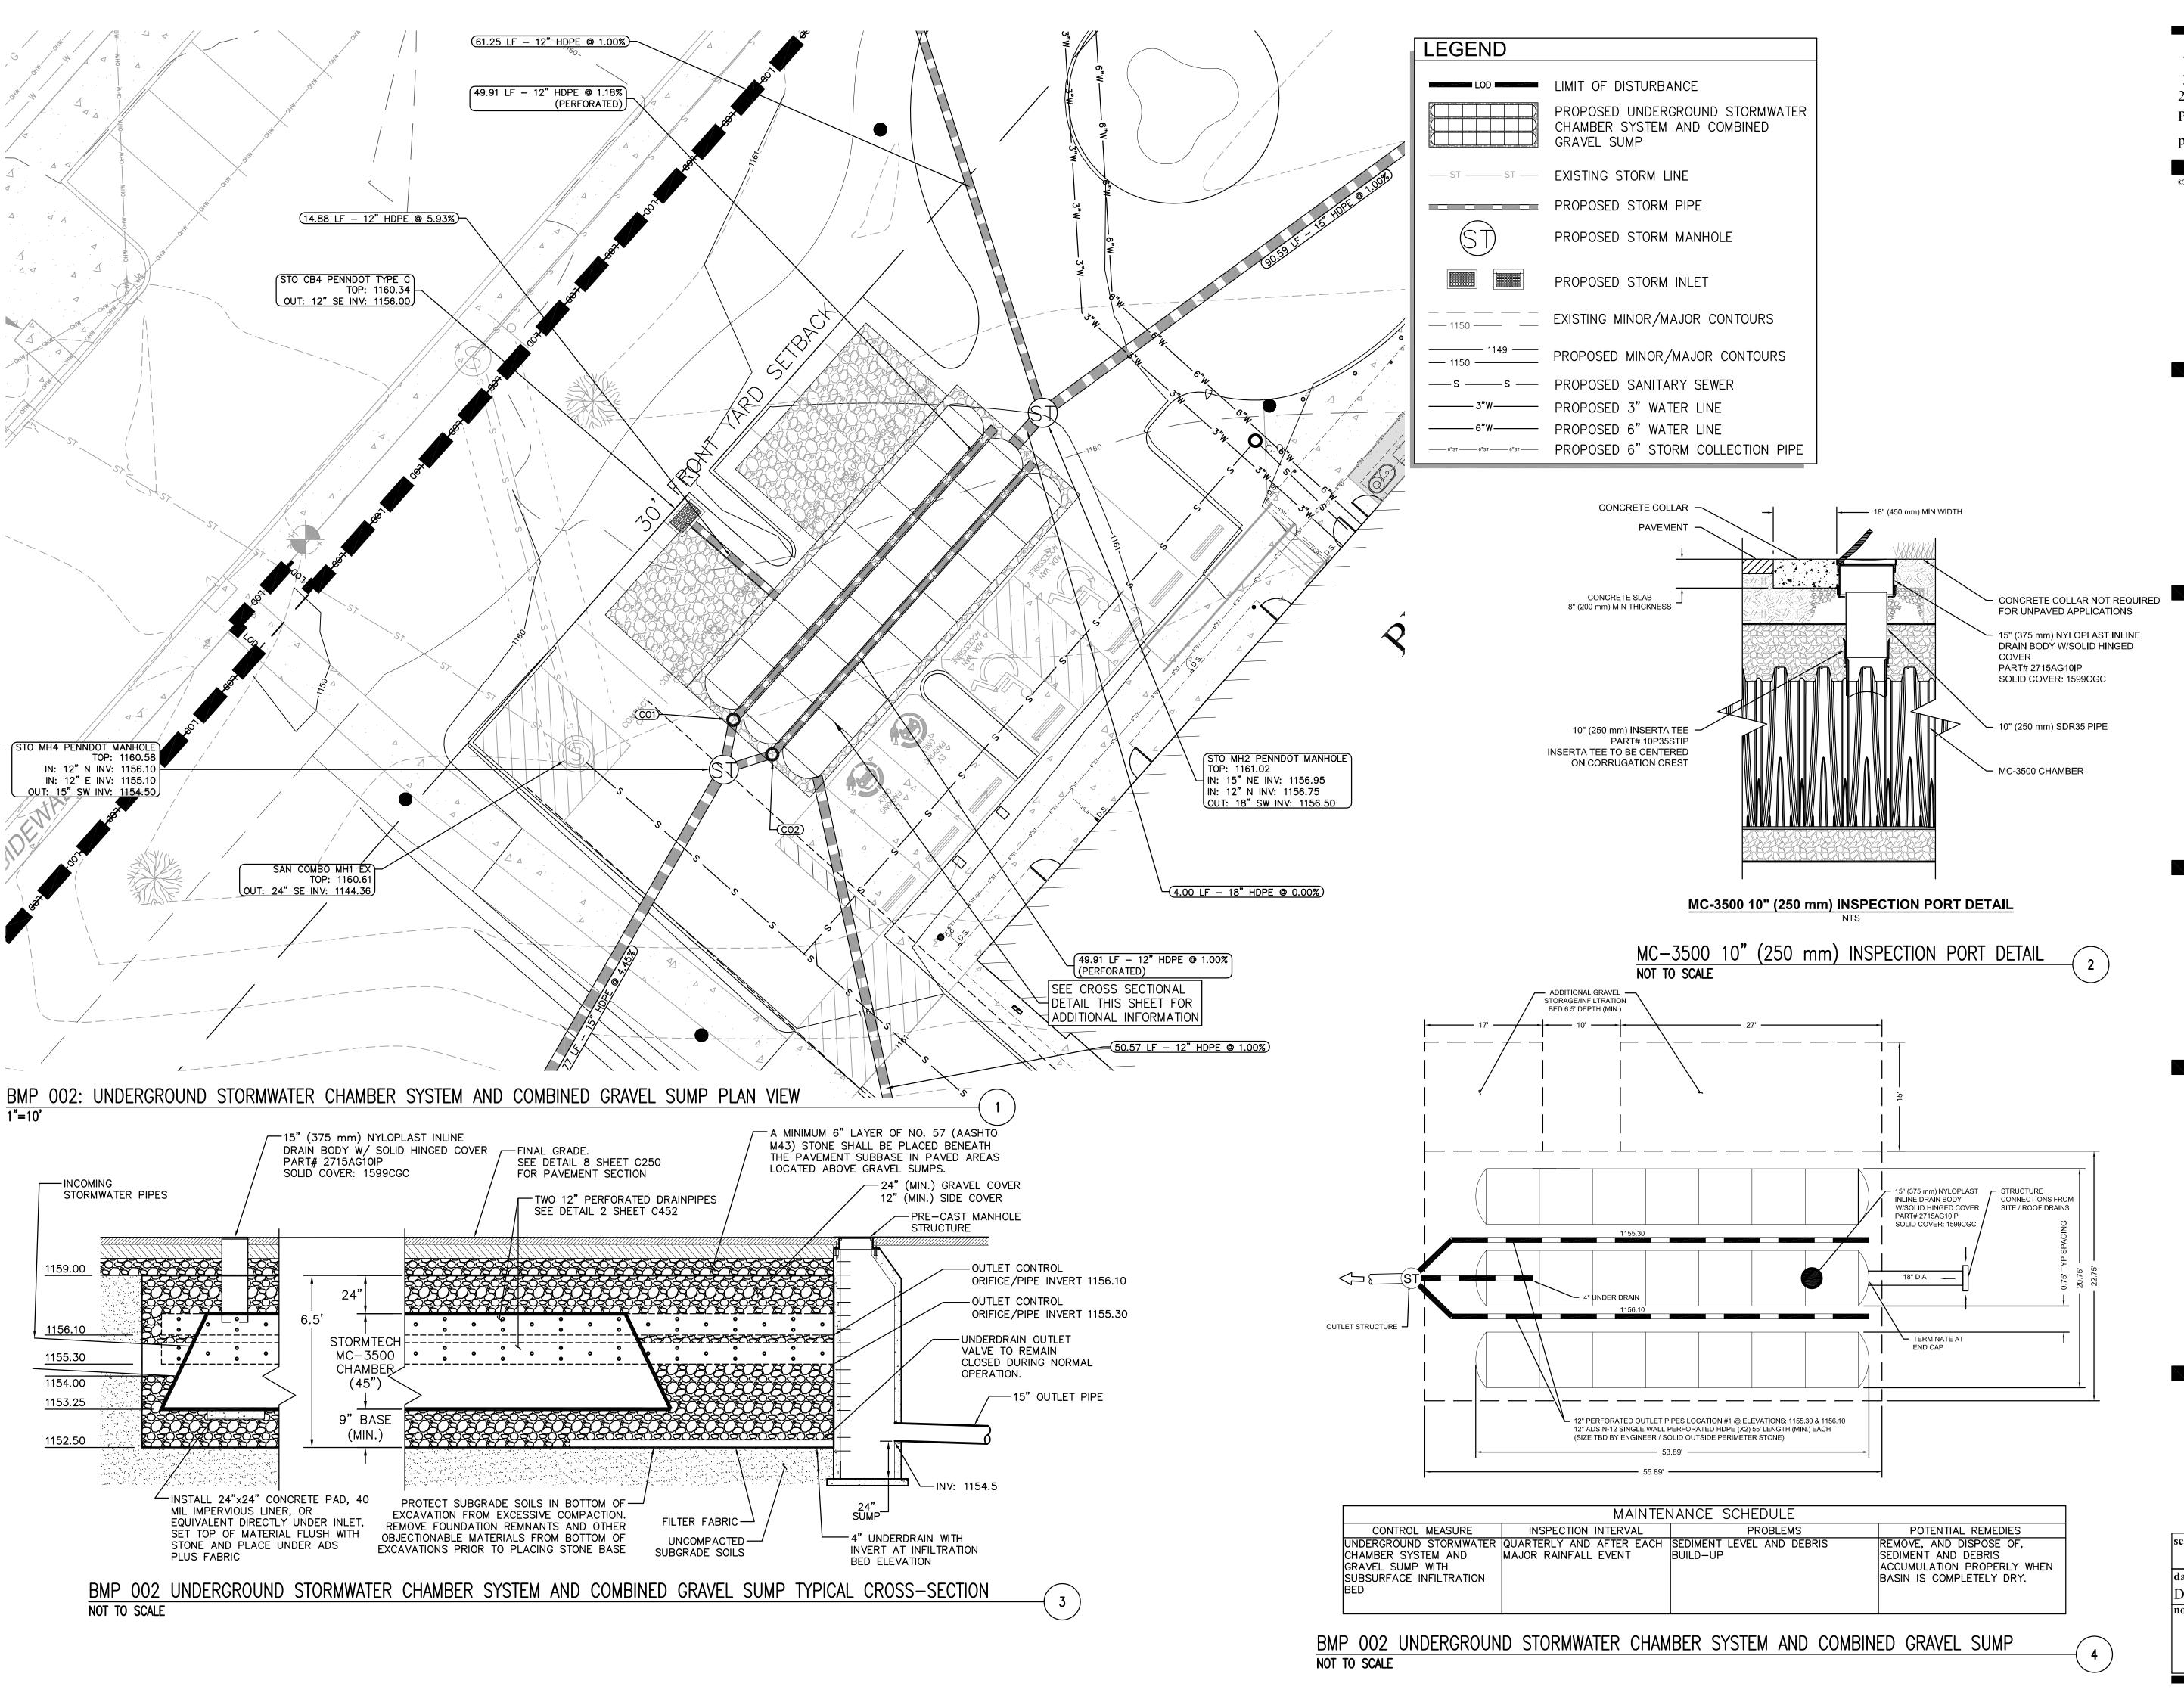

Fukui Architects Pc

205 Ross Street Pittsburgh, Pennsylvania 15219

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OFFICE: 724.325.1215

general notes

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revisions

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STORMWATER MANAGEMENT **DETAILS AND PROFILES** SHEET 4 OF 7

As Noted December 3rd, 2023

Sheet No.

C453





MC-3500 STORMTECH CHAMBER SPECIFICATIONS

- 1. CHAMBERS SHALL BE STORMTECH MC-3500.
- 2. CHAMBERS SHALL BE ARCH-SHAPED AND SHALL BE MANUFACTURED FROM VIRGIN, IMPACT-MODIFIED POLYPROPYLENE COPOLYMERS.
- CHAMBERS SHALL MEET THE REQUIREMENTS OF ASTM F2418-16a, "STANDARD SPECIFICATION FOR POLYPROPYLENE (PP) CORRUGATED WALL STORMWATER COLLECTION CHAMBERS" CHAMBER CLASSIFICATION 45x76 DESIGNATION SS.
- 4. CHAMBER ROWS SHALL PROVIDE CONTINUOUS, UNOBSTRUCTED INTERNAL SPACE WITH NO INTERNAL SUPPORTS THAT WOULD IMPEDE FLOW OR LIMIT ACCESS FOR INSPECTION.
- 5. THE STRUCTURAL DESIGN OF THE CHAMBERS, THE STRUCTURAL BACKFILL, AND THE INSTALLATION REQUIREMENTS SHALL ENSURE THAT THE LOAD FACTORS SPECIFIED IN THE AASHTO LRFD BRIDGE DESIGN SPECIFICATIONS, SECTION 12.12, ARE MET FOR: 1) LONG-DURATION DEAD LOADS AND 2) SHORT-DURATION LIVE LOADS, BASED ON THE AASHTO DESIGN TRUCK WITH CONSIDERATION FOR IMPACT AND MULTIPLE VEHICLE PRESENCES
- 6. CHAMBERS SHALL BE DESIGNED, TESTED AND ALLOWABLE LOAD CONFIGURATIONS DETERMINED IN ACCORDANCE WITH ASTM F2787, "STANDARD PRACTICE FOR STRUCTURAL DESIGN OF THERMOPLASTIC CORRUGATED WALL STORMWATER COLLECTION CHAMBERS". LOAD CONFIGURATIONS SHALL INCLUDE: 1) INSTANTANEOUS (<1 MIN) AASHTO DESIGN TRUCK LIVE LOAD ON MINIMUM COVER 2) MAXIMUM PERMANENT (75-YR) COVER LOAD AND 3) ALLOWABLE COVER WITH PARKED (1-WEEK) AASHTO DESIGN
- 7. REQUIREMENTS FOR HANDLING AND INSTALLATION: TO MAINTAIN THE WIDTH OF CHAMBERS DURING SHIPPING AND HANDLING, CHAMBERS SHALL HAVE

JOINT SHALL NOT BE LESS THAN 3".

- INTEGRAL. INTERLOCKING STACKING LUGS. TO ENSURE A SECURE JOINT DURING INSTALLATION AND BACKFILL, THE HEIGHT OF THE CHAMBER
- TO ENSURE THE INTEGRITY OF THE ARCH SHAPE DURING INSTALLATION, a) THE ARCH STIFFNESS CONSTANT AS DEFINED IN SECTION 6.2.8 OF ASTM F2418 SHALL BE GREATER THAN OR EQUAL TO 500 LBS/IN/IN. AND b) TO RESIST CHAMBER DEFORMATION DURING INSTALLATION AT ELEVATED TEMPERATURES (ABOVE 73° F / 23° C), CHAMBERS SHALL BE PRODUCED FROM REFLECTIVE GOLD
- 8. ONLY CHAMBERS THAT ARE APPROVED BY THE SITE DESIGN ENGINEER WILL BE ALLOWED. UPON REQUEST BY THE SITE DESIGN ENGINEER OR OWNER, THE CHAMBER MANUFACTURER SHALL SUBMIT A STRUCTURAL EVALUATION FOR APPROVAL BEFORE DELIVERING CHAMBERS TO THE PROJECT SITE AS
- THE STRUCTURAL EVALUATION SHALL BE SEALED BY A REGISTERED PROFESSIONAL ENGINEER. • THE STRUCTURAL EVALUATION SHALL DEMONSTRATE THAT THE SAFETY FACTORS ARE GREATER THAN OR EQUAL TO 1.95 FOR DEAD LOAD AND 1.75 FOR LIVE LOAD, THE MINIMUM REQUIRED BY

ASTM F2787 AND BY SECTIONS 3 AND 12.12 OF THE AASHTO LRFD BRIDGE DESIGN SPECIFICATIONS

- THE TEST DERIVED CREEP MODULUS AS SPECIFIED IN ASTM F2418 SHALL BE USED FOR PERMANENT DEAD LOAD DESIGN EXCEPT THAT IT SHALL BE THE 75-YEAR MODULUS USED FOR DESIGN.
- 9. CHAMBERS AND END CAPS SHALL BE PRODUCED AT AN ISO 9001 CERTIFIED MANUFACTURING FACILITY.

IMPORTANT - NOTES FOR THE BIDDING AND INSTALLATION OF MC-3500 **CHAMBER SYSTEM**

- STORMTECH MC-3500 CHAMBERS SHALL NOT BE INSTALLED UNTIL THE MANUFACTURER'S REPRESENTATIVE HAS COMPLETED A PRE-CONSTRUCTION MEETING WITH THE INSTALLERS.
- STORMTECH MC-3500 CHAMBERS SHALL BE INSTALLED IN ACCORDANCE WITH THE "STORMTECH MC-3500/MC-4500 CONSTRUCTION GUIDE".
- CHAMBERS ARE NOT TO BE BACKFILLED WITH A DOZER OR AN EXCAVATOR SITUATED OVER THE STORMTECH RECOMMENDS 3 BACKFILL METHODS:
- STONESHOOTER LOCATED OFF THE CHAMBER BED BACKFILL AS ROWS ARE BUILT USING AN EXCAVATOR ON THE FOUNDATION STONE OR SUBGRADE. BACKFILL FROM OUTSIDE THE EXCAVATION USING A LONG BOOM HOE OR EXCAVATOR
- 4. THE FOUNDATION STONE SHALL BE LEVELED AND COMPACTED PRIOR TO PLACING CHAMBERS.
- 5. JOINTS BETWEEN CHAMBERS SHALL BE PROPERLY SEATED PRIOR TO PLACING STONE.
- 6. MAINTAIN MINIMUM -SPACING BETWEEN THE CHAMBER ROWS.
- 7. INLET AND OUTLET MANIFOLDS MUST BE INSERTED A MINIMUM OF 12" (300 mm) INTO CHAMBER END CAPS.
- EMBEDMENT STONE SURROUNDING CHAMBERS MUST BE A CLEAN, CRUSHED, ANGULAR STONE MEETING THE AASHTO M43 DESIGNATION OF #3 OR #4.
- STONE MUST BE PLACED ON THE TOP CENTER OF THE CHAMBER TO ANCHOR THE CHAMBERS IN PLACE
- THE CONTRACTOR MUST REPORT ANY DISCREPANCIES WITH CHAMBER FOUNDATION MATERIALS BEARING CAPACITIES TO THE SITE DESIGN ENGINEER.
- ADS RECOMMENDS THE USE OF "FLEXSTORM CATCH IT" INSERTS DURING CONSTRUCTION FOR ALL INLETS TO PROTECT THE SUBSURFACE STORMWATER MANAGEMENT SYSTEM FROM CONSTRUCTION SITE

NOTES FOR CONSTRUCTION EQUIPMENT

- STORMTECH MC-3500 CHAMBERS SHALL BE INSTALLED IN ACCORDANCE WITH THE "STORMTECH MC-3500/MC-4500 CONSTRUCTION GUIDE".
- THE USE OF EQUIPMENT OVER MC-3500 CHAMBERS IS LIMITED:
- NO EQUIPMENT IS ALLOWED ON BARE CHAMBERS. NO RUBBER TIRED LOADER, DUMP TRUCK, OR EXCAVATORS ARE ALLOWED UNTIL PROPER FILL
- DEPTHS ARE REACHED IN ACCORDANCE WITH THE "STORMTECH MC-3500/MC-4500 CONSTRUCTION
- WEIGHT LIMITS FOR CONSTRUCTION EQUIPMENT CAN BE FOUND IN THE "STORMTECH MC-3500/MC-4500 CONSTRUCTION GUIDE".
- FULL 36" (900 mm) OF STABILIZED COVER MATERIALS OVER THE CHAMBERS IS REQUIRED FOR DUMP TRUCK TRAVEL OR DUMPING


USE OF A DOZER TO PUSH EMBEDMENT STONE BETWEEN THE ROWS OF CHAMBERS MAY CAUSE DAMAGE TO CHAMBERS AND IS NOT AN ACCEPTABLE BACKFILL METHOD. ANY CHAMBERS DAMAGED BY USING THE "DUMP AND PUSH" METHOD ARE NOT COVERED UNDER THE STORMTECH STANDARD WARRANTY.

CONTACT STORMTECH AT 1-888-892-2694 WITH ANY QUESTIONS ON INSTALLATION REQUIREMENTS OR WEIGHT LIMITS FOR CONSTRUCTION EQUIPMENT.

ACCEPTABLE FILL MATERIALS: STORMTECH MC-3500 CHAMBER SYSTEMS


MATERIAL LOCATION		DESCRIPTION	AASHTO MATERIAL CLASSIFICATIONS	COMPACTION / DENSITY REQUIREMENT
D	FINAL FILL: FILL MATERIAL FOR LAYER 'D' STARTS FROM THE TOP OF THE 'C' LAYER TO THE BOTTOM OF FLEXIBLE PAVEMENT OR UNPAVED FINISHED GRADE ABOVE. NOTE THAT PAVEMENT SUBBASE MAY BE PART OF THE 'D' LAYER	ANY SOIL/ROCK MATERIALS, NATIVE SOILS, OR PER ENGINEER'S PLANS. CHECK PLANS FOR PAVEMENT SUBGRADE REQUIREMENTS.	N/A	PREPARE PER SITE DESIGN ENGINEER'S PLANS. PAVED INSTALLATIONS MAY HAVE STRINGENT MATERIAL AND PREPARATION REQUIREMENTS.
С	INITIAL FILL: FILL MATERIAL FOR LAYER 'C' STARTS FROM THE TOP OF THE EMBEDMENT STONE ('B' LAYER) TO 24" (600 mm) ABOVE THE TOP OF THE CHAMBER. NOTE THAT PAVEMENT SUBBASE MAY BE A PART OF THE 'C' LAYER.	GRANULAR WELL-GRADED SOIL/AGGREGATE MIXTURES, <35% FINES OR PROCESSED AGGREGATE. MOST PAVEMENT SUBBASE MATERIALS CAN BE USED IN LIEU OF THIS LAYER.	AASHTO M145¹ A-1, A-2-4, A-3 OR AASHTO M43¹ 3, 357, 4, 467, 5, 56, 57, 6, 67, 68, 7, 78, 8, 89, 9, 10	BEGIN COMPACTIONS AFTER 24" (600 mm) OF MATERIAL OVER THE CHAMBERS IS REACHED. COMPACT ADDITIONAL LAYERS IN 12" (300 mm) MAX LIFTS TO A MIN. 95% PROCTOR DENSITY FOR WELL GRADED MATERIAL AND 95% RELATIVE DENSITY FOR PROCESSED AGGREGATE MATERIALS.
В	EMBEDMENT STONE: FILL SURROUNDING THE CHAMBERS FROM THE FOUNDATION STONE ('A' LAYER) TO THE 'C' LAYER ABOVE.	CLEAN, CRUSHED, ANGULAR STONE	AASHTO M43 ¹ 3, 4	NO COMPACTION REQUIRED.
А	FOUNDATION STONE: FILL BELOW CHAMBERS FROM THE SUBGRADE UP TO THE FOOT (BOTTOM) OF THE CHAMBER.	CLEAN, CRUSHED, ANGULAR STONE	AASHTO M43¹ 3, 4	PLATE COMPACT OR ROLL TO ACHIEVE A FLAT SURFACE. ^{2,3}


- THE LISTED AASHTO DESIGNATIONS ARE FOR GRADATIONS ONLY. THE STONE MUST ALSO BE CLEAN, CRUSHED, ANGULAR. FOR EXAMPLE, A SPECIFICATION FOR #4 STONE WOULD STATE: "CLEAN, CRUSHED, ANGULAR NO. 4 (AASHTO M43) STONE". STORMTECH COMPACTION REQUIREMENTS ARE MET FOR 'A' LOCATION MATERIALS WHEN PLACED AND COMPACTED IN 9" (230 mm) (MAX) LIFTS USING TWO FULL COVERAGES WITH A VIBRATORY COMPACTOR.
- WHERE INFILTRATION SURFACES MAY BE COMPROMISED BY COMPACTION, FOR STANDARD DESIGNS, CONTACT STORMTECH FOR 4. ONCE LAYER 'C' IS PLACED, ANY SOIL/MATERIAL CAN BE PLACED IN LAYER 'D' UP TO THE FINISHED GRADE. MOST PAVEMENT SUBBASE SOILS CAN BE USED TO REPLACE THE MATERIAL REQUIREMENTS OF LAYER 'C' OR 'D' AT THE SITE DESIGN ENGINEER'S DISCRETION.

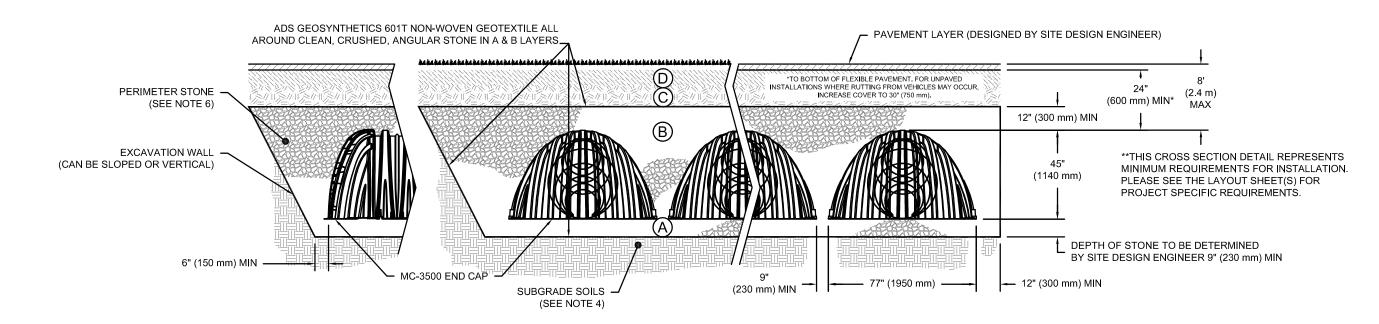

- CHAMBERS SHALL MEET THE REQUIREMENTS OF ASTM F2418-16a, "STANDARD SPECIFICATION FOR POLYPROPYLENE (PP) CORRUGATED WALL STORMWATER COLLECTION CHAMBERS" CHAMBER CLASSIFICATION
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- THE SITE DESIGN ENGINEER IS RESPONSIBLE FOR ASSESSING THE BEARING RESISTANCE (ALLOWABLE BEARING CAPACITY) OF THE SUBGRADE SOILS AND THE DEPTH OF FOUNDATION STONE WITH CONSIDERATION FOR THE RANGE OF EXPECTED SOIL MOISTURE CONDITIONS.
- PERIMETER STONE MUST BE EXTENDED HORIZONTALLY TO THE EXCAVATION WALL FOR BOTH VERTICAL AND SLOPED EXCAVATION WALLS REQUIREMENTS FOR HANDLING AND INSTALLATION:
- TO MAINTAIN THE WIDTH OF CHAMBERS DURING SHIPPING AND HANDLING, CHAMBERS SHALL HAVE INTEGRAL, INTERLOCKING STACKING LUGS.
- TO ENSURE A SECURE JOINT DURING INSTALLATION AND BACKFILL, THE HEIGHT OF THE CHAMBER JOINT SHALL NOT BE LESS THAN 3".
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MC-3500 CROSS SECTION DETAIL




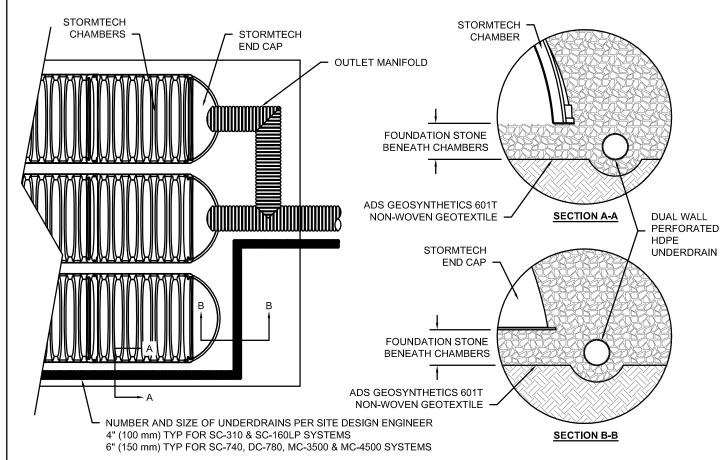


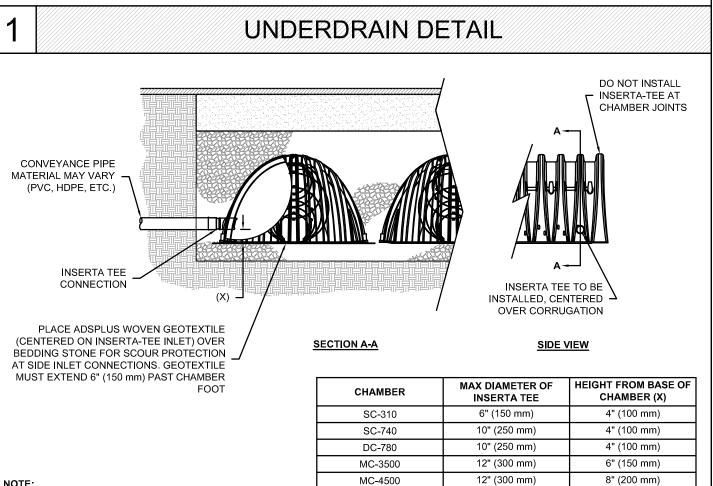INSERTA-TEE SIDE INLET DETAIL

NOTE:
PART NUMBERS WILL VARY BASED ON INLET PIPE MATERIALS.

CONTACT STORMTECH FOR MORE INFORMATION.

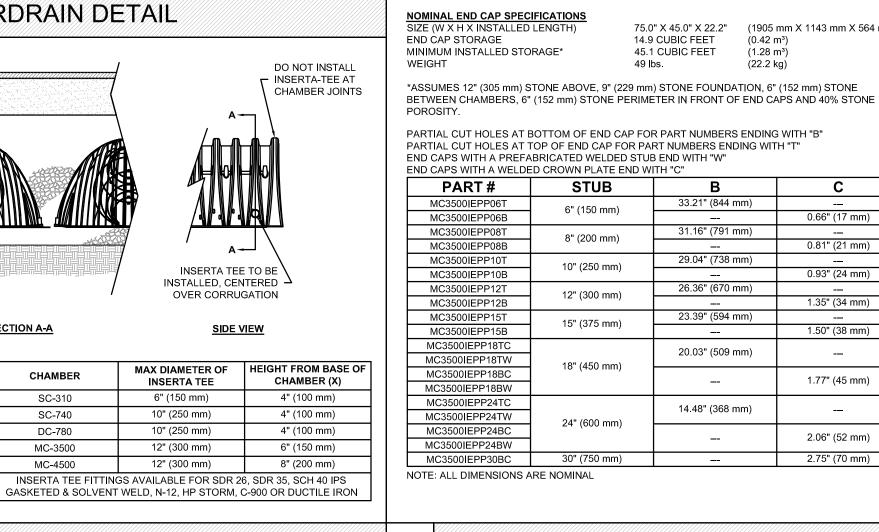

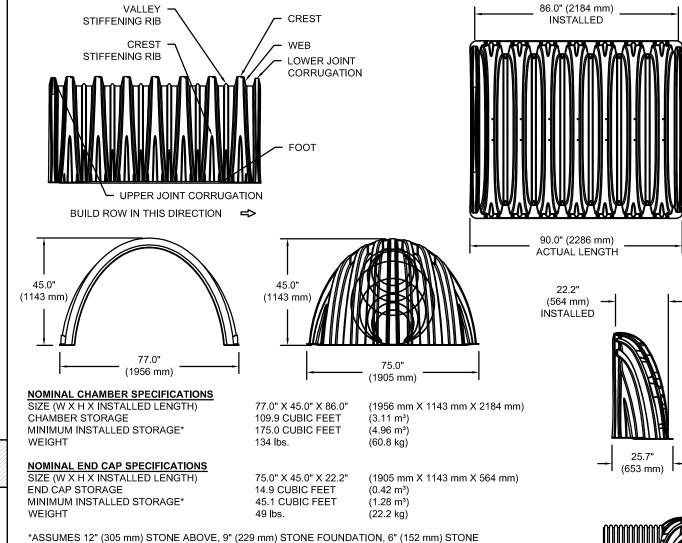

PARTIAL CUT HOLES AT BOTTOM OF END CAP FOR PART NUMBERS ENDING WITH "B" PARTIAL CUT HOLES AT TOP OF END CAP FOR PART NUMBERS ENDING WITH "T" END CAPS WITH A PREFABRICATED WELDED STUB END WITH "W" END CAPS WITH A WELDED CROWN PLATE END WITH "C" PART# STUB MC3500IEPP067 33.21" (844 mm 6" (150 mm) MC3500IEPP06B 8" (200 mm) 0.81" (21 mm) MC3500IEPP08B 29.04" (738 mm) 10" (250 mm) 0.93" (24 mm) MC3500IEPP10B MC3500IEPP12T 12" (300 mm) 1.35" (34 mm) MC3500IEPP12B 23.39" (594 mm) MC3500IEPP15T CUSTOM PARTIAL CUT INVERTS ARE 15" (375 mm) 1.50" (38 mm) MC3500IEPP15B MC3500IEPP18TC 20.03" (509 mm) AND 15-48" (375-1200 mm) 18" (450 mm) MC3500IEPP18BC MC3500IEPP18BW MC3500IEPP24TC 14.48" (368 mm) MC3500IEPP24TW 24" (600 mm) GREATER THAN 10" (250 mm). THE MC3500IEPP24B0 INVERT LOCATION IN COLUMN 'B' MC3500IEPP24BW ARE THE HIGHEST POSSIBLE FOR THE PIPE SIZE NOTE: ALL DIMENSIONS ARE NOMINAL

MC-3500 TECHNICAL SPECIFICATIONS

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conditions in the field and shall advise Fukui Architects, AVAILABLE UPON REQUEST. **Pc** of any discrepancies between, additions to, deletions INVENTORIED MANIFOLDS INCLUDE from, or alterations to any and all conditions prior to 12-24" (300-600 mm) SIZE ON SIZE proceeding with any phase of work. Do not scale ECCENTRIC MANIFOLDS, CUSTOM INVERT LOCATIONS ON THE MC-3500 All work shall be installed in accordance with applicable END CAP CUT IN THE FIELD ARE NOT codes and regulations. RECOMMENDED FOR PIPE SIZES

Fukui Architects Pc

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ENGINEERS & SURVEYORS

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SUITE 101

Pittsburgh, Pennsylvania 15219

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205 Ross Street

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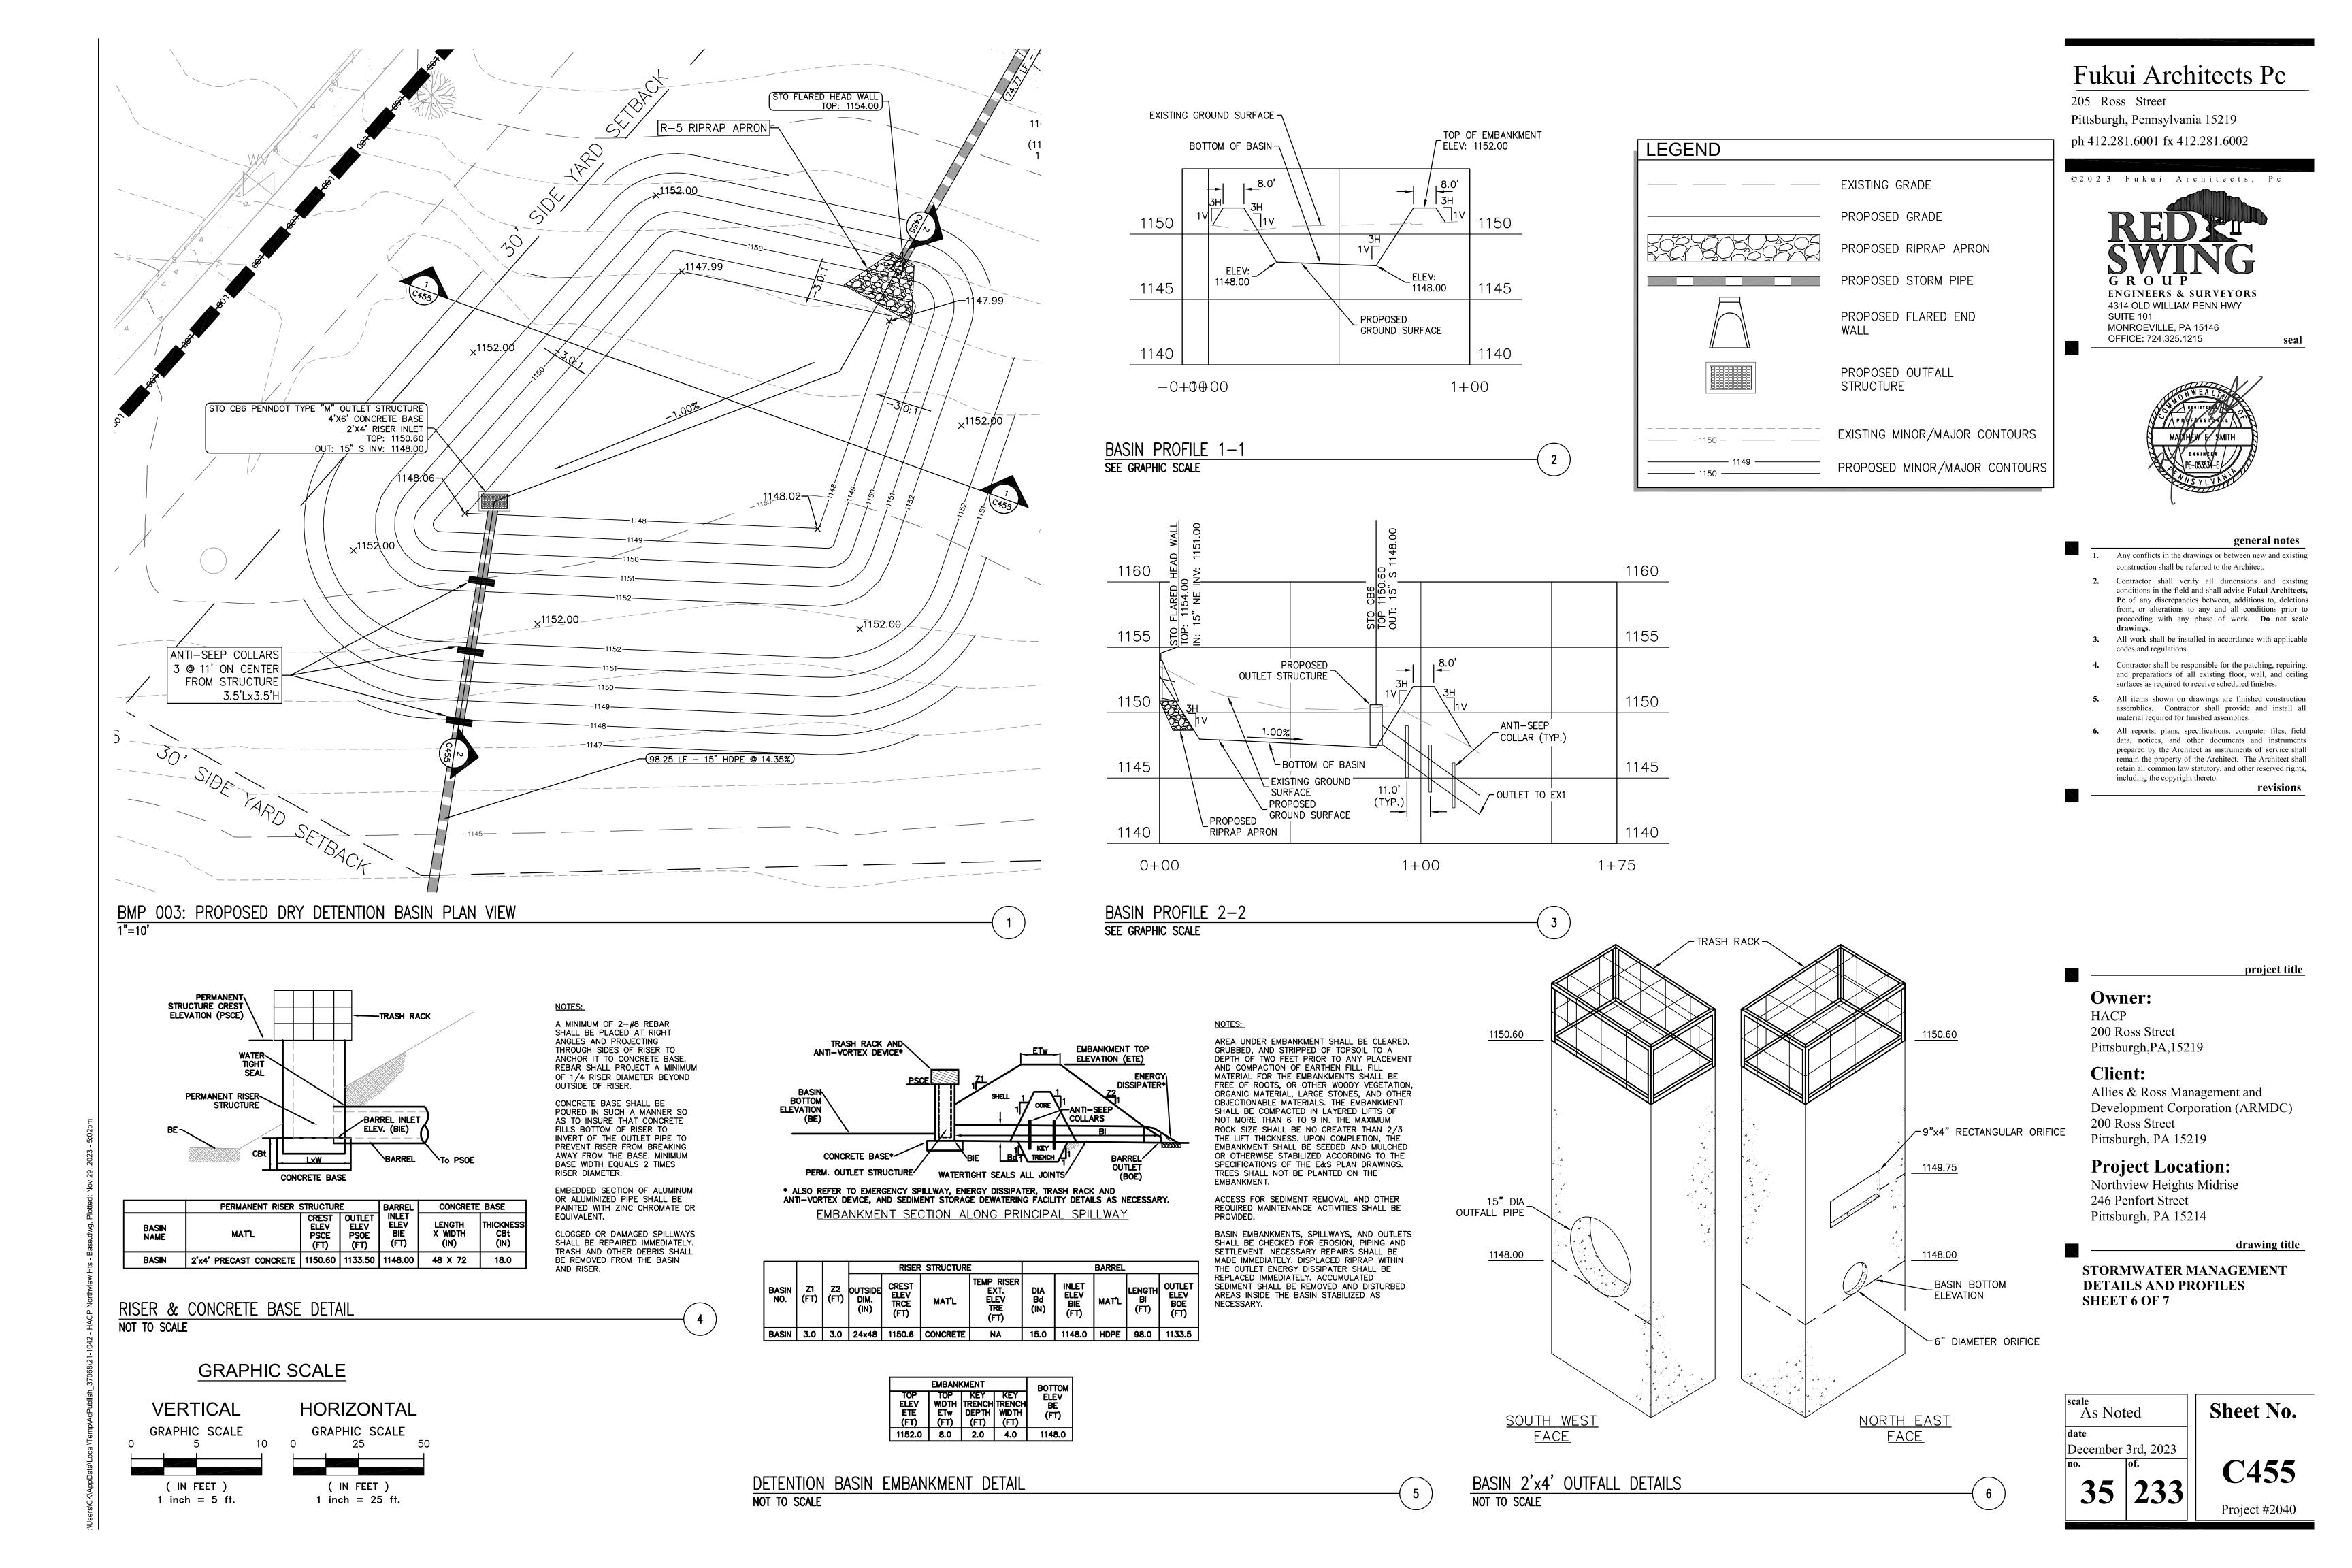
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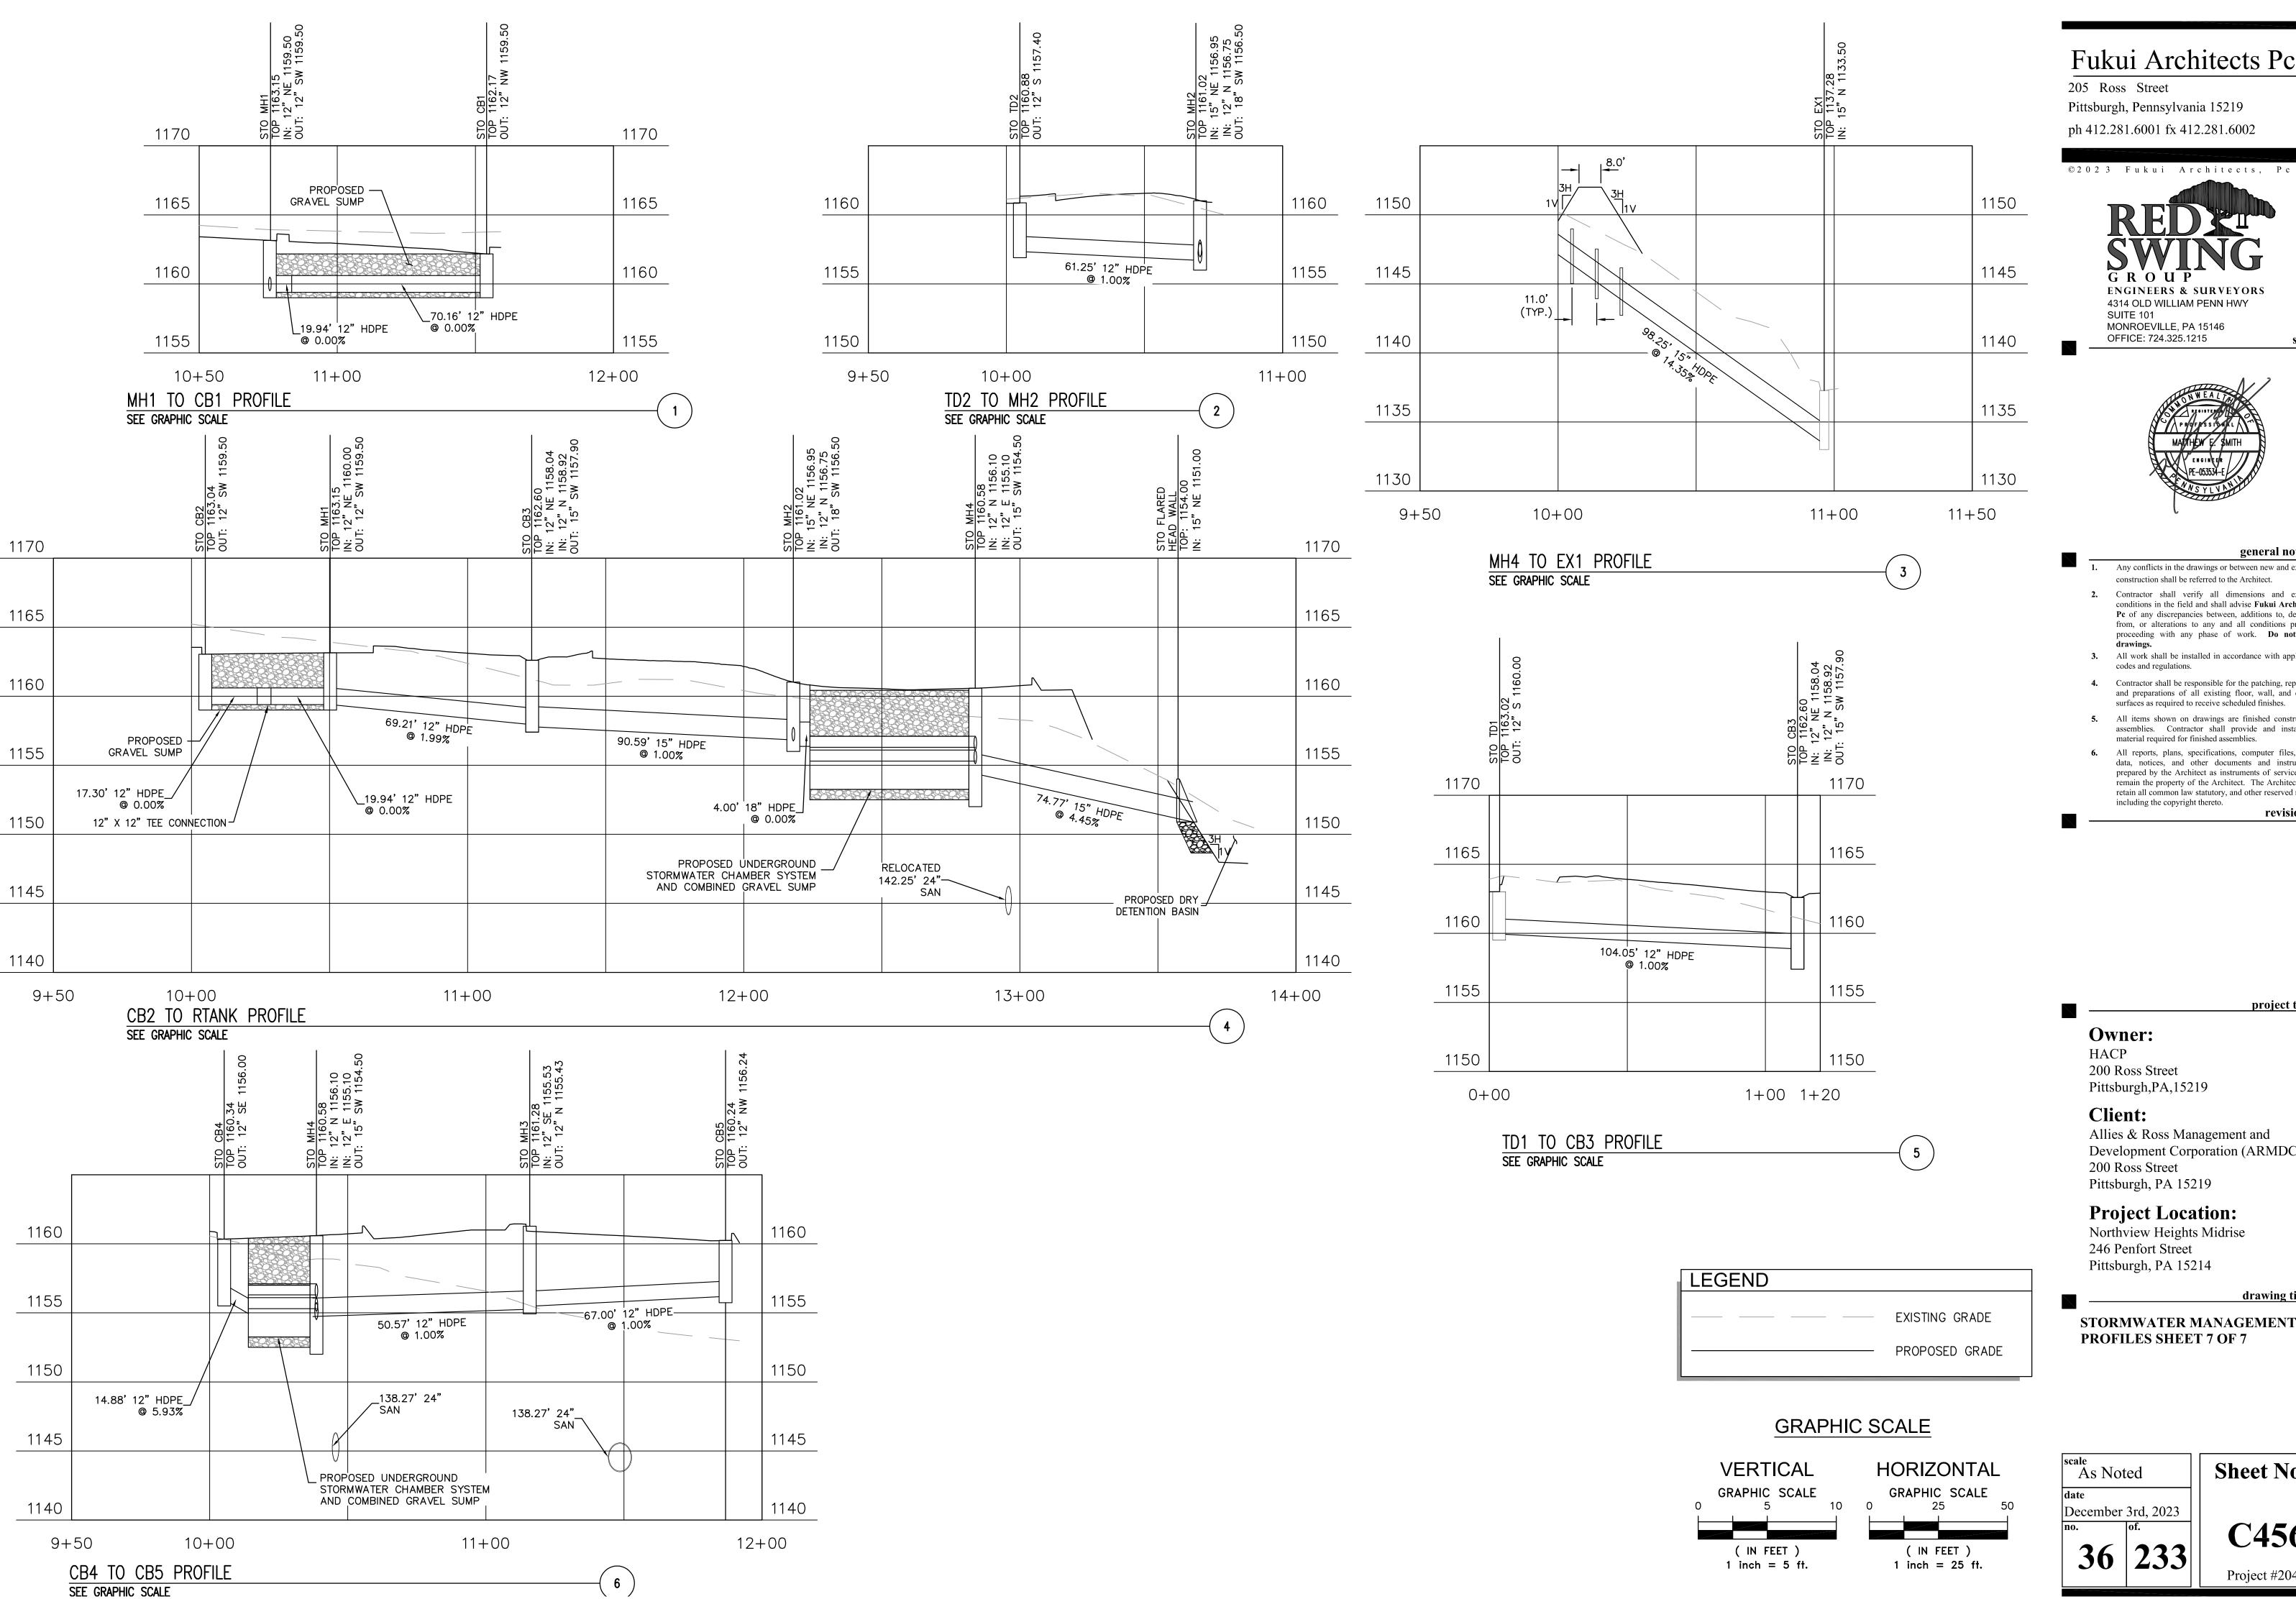
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STORMWATER MANAGEMENT **DETAILS SHEET 5 OF 7**

As Noted December 3rd, 2023






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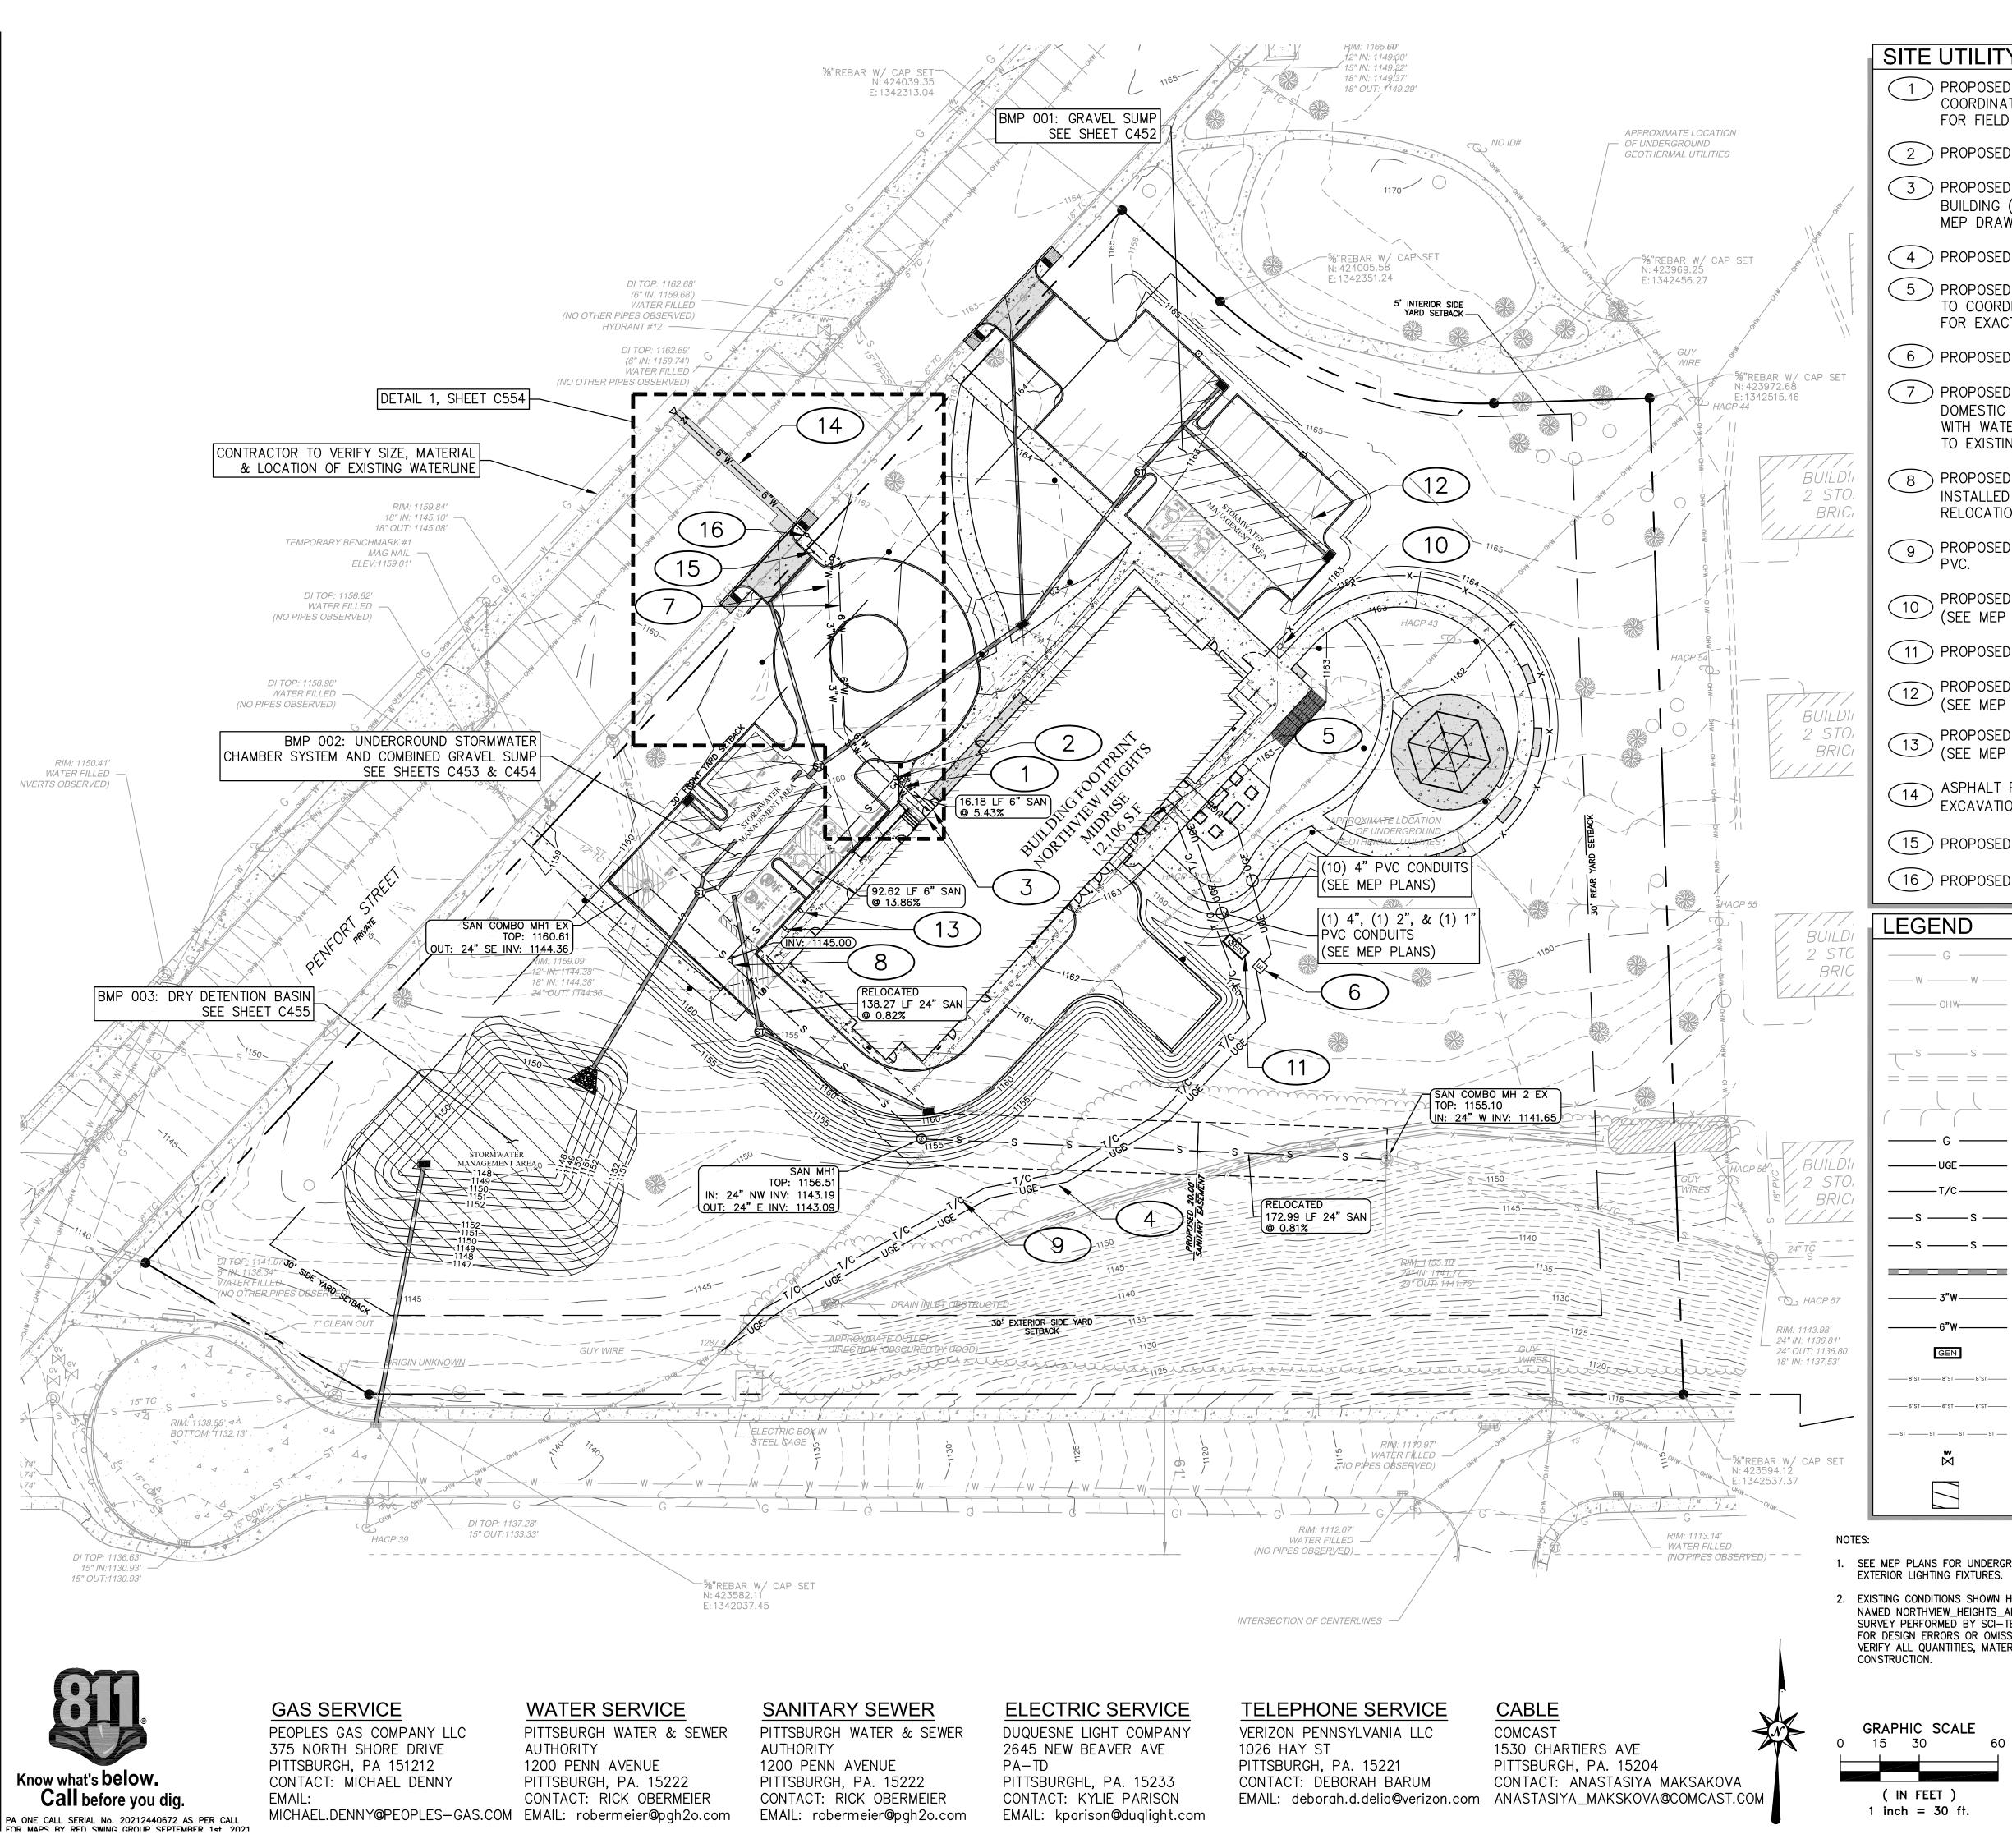
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drawing title

STORMWATER MANAGEMENT PROFILES SHEET 7 OF 7

As Noted December 3rd, 2023

C456 Project #2040

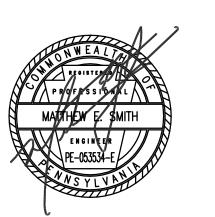

SITE UTILITY NOTES

- 1 PROPOSED SANITARY SEWER LATERAL. CONTRACTOR TO COORDINATE WITH SANITARY SEWER SERVICE PROVIDER FOR FIELD CONNECTION TO EXISTING SYSTEM.
- 2 PROPOSED SANITARY CLEANOUT. SEE $\frac{3}{(550)}$
- (3) PROPOSED WATERLINES TO BE CAPPED 1'-0" OUTSIDE BUILDING (3" TO 2.5" REDUCER TO BE COORDINATE WITH MEP DRAWINGS).
- (4) PROPOSED UNDERGROUND ELECTRIC. (2) 5" PVC.
- 5) PROPOSED FIRE DEPARTMENT CONNECTION. CONTRACTOR TO COORDINATE WITH FIRE MARSHAL AND ARCHITECT FOR EXACT LOCATION.
- (6) PROPOSED ELECTRICAL TRANSFORMER. (BY DLC)
- $(\ 7\)$ PROPOSED 6" WATER SERVICE LINE TO BE SPLIT TO 3" DOMESTIC AND 6" FIRE PROTECTION LINE. COORDINATE WITH WATER SERVICE PROVIDER FOR FIELD CONNECTION TO EXISTING SYSTEM.
- 8 PROPOSED 6" PVC SDR 35 TO 24" SANITARY WYE TO BE INSTALLED AND CAPPED DURING 24" SANITARY MAIN RELOCATION. SEE 2 C550
- 9 PROPOSED TELEPHONE/COMMUNICATIONS CONDITS. (2) 4"
- PROPOSED ELECTRICAL PULL BOXES. (TYP.) ノ (SEE MEP PLANS)
- (11) PROPOSED GENERATOR. (SEE MEP PLANS)
- PROPOSED UNDERGROUND CONDUITS FOR LIGHTING. (TYP.) (SEE MEP PLANS)
- 、PROPOSED ELECTRIC VEHICLE CHARGING PEDESTAL. (SEE MEP PLANS)
- ASPHALT PAVEMENT EXCAVATION AND REPLACEMENT, SEE $\frac{8}{C250}$
- 15 PROPOSED VALVE BOX, SEE (WVB)
- (16) PROPOSED 6" CURB STOP

LEGEND

EXISTING GAS LINE EXISTING WATER LINE EXISTING OVERHEAD WIRE EXISTING SANITARY LATERAL

EXISTING SANITARY LINE

EXISTING STORM LINE EXISTING GEOTHERMAL UTILITIES

——— G ——— PROPOSED GAS LINE

PROPOSED UNDERGROUND ELECTRIC LINES PROPOSED TELE. & COMMUNICATIONS LINES

PROPOSED 24" RE-ROUTED SANITARY LINE ----s -----s ---- PROPOSED 6" SANITARY LATERAL WHERE NOTED

PROPOSED STORM LINE PROPOSED 3" WATER LINE


PROPOSED 6" WATER LINE PROPOSED GENERATOR (SEE MEP PLANS) GEN PROPOSED 8" STORM COLLECTION PIPE

> PROPOSED 6" STORM COLLECTION PIPE PROPOSED STORM COLLECTION PIPE

PROPOSED WATER VALVE

PROPOSED VALVE BOX

- 1. SEE MEP PLANS FOR UNDERGROUND ELECTRICAL ROUTING TO LIGHT POLE BASES AND OTHER EXTERIOR LIGHTING FIXTURES.
- 2. EXISTING CONDITIONS SHOWN HEREIN WERE OBTAINED FROM FUKUI ARCHITECTS IN DWG FILED NAMED NORTHVIEW_HEIGHTS_ALTA_UPDATE-DRAFT 2022-3-17 AND DATED 3/17/2022 PER SURVEY PERFORMED BY SCI-TEK. RED SWING CONSULTING SERVICES, LLC IS NOT RESPONSIBLE FOR DESIGN ERRORS OR OMISSIONS RESULTING FROM SURVEY INACCURACIES. CONTRACTOR TO VERIFY ALL QUANTITIES, MATERIAL TYPES AND SIZES AS NECESSARY FOR BIDDING AND

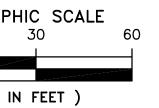



CALL BEFORE YOU DIG! PENNSYLVANIA LAW REQUIRES 3 WORKING DAYS NOTICE FOR CONSTRUCTION PHASE AND 10 WORKING DAYS NOTICE IN DESIGN STAGE.

STOP CALL PENNSYLVANIA ONE CALL SYSTEM, INC. 1-800-242-1776

Fukui Architects Pc

205 Ross Street


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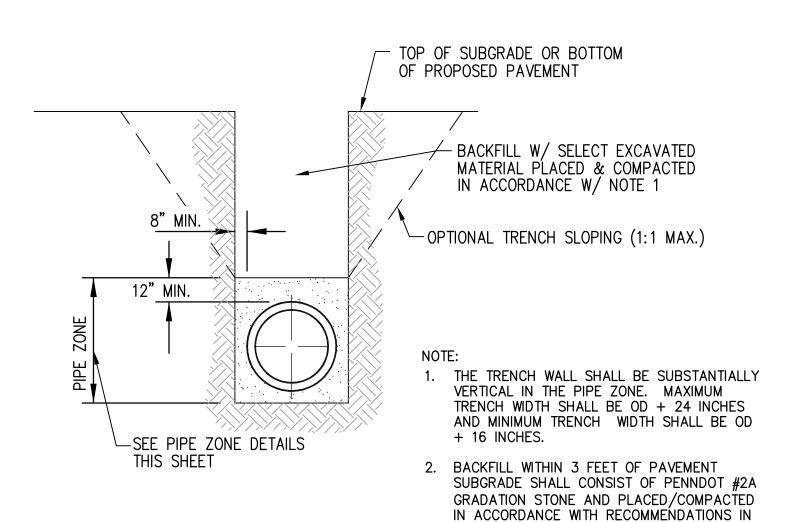
UTILITY PLAN

As Noted

C500


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Sheet No. December 3rd, 2023

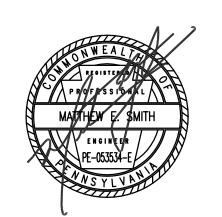

GEOTECHNICAL REPORT

TRENCH SECTION - STORM & SANITARY NOT TO SCALE

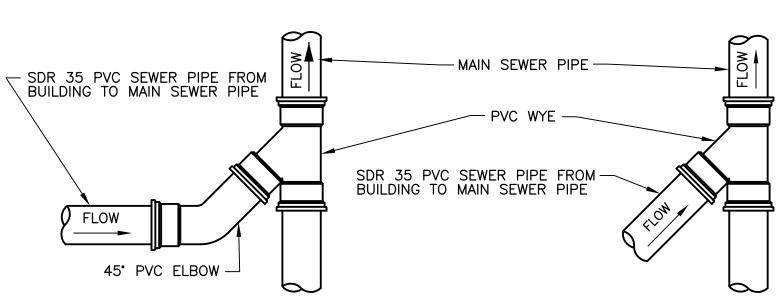

- 1. THESE DETAILS APPLY TO STORM AND SANITARY SEWER CONNECTIONS WITH APPROPRIATE CHANGES TO WYE AND PIPE SIZES, AND PIPE MATERIALS.
- 2. ALL PVC PIPE AND FITTINGS SHALL BE MINIMUM SDR 35 WITH RUBBER GASKETED JOINTS.

TYPICAL WYE CONNECTION NOT TO SCALE

LESS THAN 95% OF MODIFIED PROCTOR DENSITY. THE EMBEDMENT AND BACKFILL SHALL BE WETTED TO ±2% OF OPTIMUM MOISTURE CONTENT (NO WATER JETTING IS ALLOWED).

- 2. THE TRENCH WALL SHALL BE SUBSTANTIALLY VERTICAL IN THE PIPE ZONE. MAXIMUM TRENCH WIDTH (W) SHALL BE O.D. + 24" AND MINIMUM TRENCH SHALL BE O.D. + 16".
- 3. NO ROCK WILL BE PERMITTED IN BACKFILL IN THE ZONE FROM BOTTOM OF TRENCH TO 2' ABOVE THE PIPE NOR IN THE TOP 18" OF TRENCH BACKFILL AT THE GROUND SURFACE. ROCK MAY BE PLACED ELSEWHERE IN THE BACKFILL PROVIDED THE SIZE OF PIECES IN THE LARGEST DIMENSION DOES NOT EXCEED

BACKFILL W/ SELECT EXCAVATED MATERIAL LIFTS SHALL NOT EXCEED 10" IN DEPTH AND SHALL BE MECHANICALLY COMPACTED TO OBTAIN A DENSITY NOT LESS THAN 95% OF MODIFIED PROCTOR DENSITY. THE EMBEDMENT AND BACKFILL SHALL BE WETTED TO ±2% OF OPTIMUM MOISTURE CONTENT (NO WATER JETTING IS ALLOWED).

PAVEMENT SUBGRADE OR FINAL GROUND -

SURFACE IN NON-PAVEMENT AREAS (ALLOW FOR MINIMUM 6" OF TOPSOIL)

5" DIA. ELECTRICAL CONDUITS, MINIMUM SCHEDULE 40 PVC PIPE. PROVIDE A MINIMUM OF 2 CONDUITS W/PULL CHORDS FOR BUILDING SERVICE ALL SWEEPS TO BE SCHEDULE 80.

ELECTRIC SERVICE LINE 4. SLOPING OF THE TRENCH SIDES ABOVE THE PIPE ZONE WILL BE ALLOWED D = INSIDE DIAMETER O.D. = OUTSIDE DIAMETER -PAVEMENT SUBGRADE OR FINAL GROUND -SURFACE IN NON-PAVEMENT AREAS (ALLOW FOR MINIMUM 6" OF TOPSOIL) BACKFILL W/ SELECT EXCAVATED MATERIAL-LIFTS SHALL NOT EXCEED 10" IN DEPTH AND SHALL BE MECHANICALLY COMPACTED TO OBTAIN A DENSITY NOT LESS THAN 95% OF MODIFIED PROCTOR DENSITY. THE EMBEDMENT AND BACKFILL SHALL BE WETTED TO $\pm 2\%$ OF OPTIMUM MOISTURE CONTENT (NO WATER JETTING IS ALLOWED) 4" DIA. TELEPHONE 4" DIA. TELEPHONE-DUCT, PROVIDE DUCT, PROVIDE A A MINIMUM OF 2 MINIMUM OF 2 -BEDDING FOR TELEPHONE CONDUIT SHALL CONDUITS FOR CONDUITS FOR CONSIST OF SAND PLACED IN MAXIMUM 6" BUILDING SERVICE BUILDING SERVICE THICK LOOSE LIFTS AND COMPACTED TO A POINT OF NON-MOVEMENT BENEATH THE COMPACTING EQUIPMENT - 5" DIA. ELECTRICAL CONDUITS, MINIMUM SCHEDULE 40 PVC PIPE, PROVIDE A MINIMUM OF 2 CONDUITS W/PULL CHORDS FOR


> BUILDING SERVICE ALL SWEEPS TO BE SCHEDULE 80.

TELEPHONE SERVICE LINE

COMBINED ELECTRIC AND TELEPHONE SERVICE LINE D = INSIDE DIAMETER O.D. = OUTSIDE DIAMETER

CONDUIT TRENCHING DETAIL


NOT TO SCALE

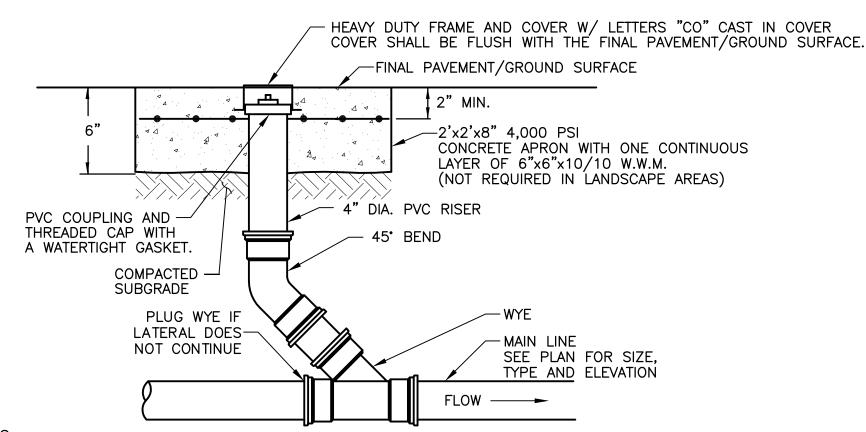

- 1. THIS DETAIL APPLIES TO STORM AND SANITARY SEWER CLEANOUTS WITH APPROPRIATE CHANGES TO WYE AND PIPE SIZES, AND PIPE MATERIALS.
- 2. ALL PVC PIPE AND FITTINGS SHALL BE MINIMUM SDR 35 WITH RUBBER GASKETED JOINTS.

TYPICAL CLEANOUT

NOT TO SCALE

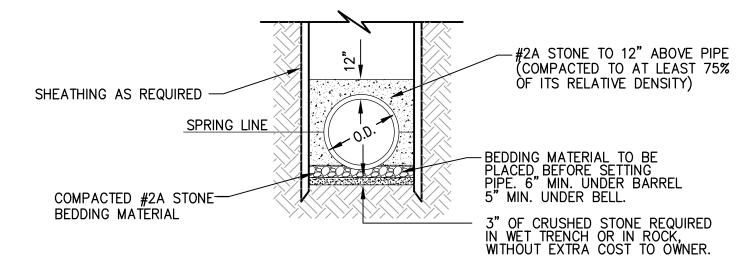

3" OF CRUSHED STONE REQUIRED IN WET TRENCH OR IN ROCK, WITHOUT EXTRA COST TO OWNER. PIPE ZONE DETAIL - STORM & SANITARY NOT TO SCALE

BEDDING FOR TELEPHONE

CONDUIT SHALL CONSIST OF

COMPACTED TO A POINT OF NON-MOVEMENT BENEATH THE

COMPACTING EQUIPMENT

SAND PLACED IN MAXIMUM 6" THICK LOOSE LIFTS AND

WATERTIGHT FRAME AND COVER) FOUR 3/4" DIA. ANCHOR BOLTS TO SECURE FRAME TO TOP SECTION. HOLES (4 REQ'D.) SHALL BE DRILLED IN TOP SECTION FOR MULTIPLE EXPANDING MACHINE-BOLT ANCHORS. JOINT BETWEEN M.H. FRAME AND TOP SECTION SHALL BE SEALED AS SPECIFIED WITH WATERPROOF GASKET PRECAST CONC. M.H. SECTIONS MANUFACTURED IN ACCORDANCE WITH A.S.T.M. SPEC. C478. ^{──} 5'-10" DIA. PAD 🖟 -MANHOLE STEPS AS SPECIFIED - ALL JOINTS BETWEEN PRECAST SECTION SHALL BE SEALED AS SPECIFIED WITH WATERPROOF GASKET. (SEE NOTE 5) - SLOPE @ 1/2" PER FT. (TYP.) PRECAST BASE SECTION 0.1' DROP ACROSS MANHOLE 4" COMPACTED AASHTO-NO. 57 COARSE AGGREGATE ─ MANHOLE INVERT

- MANHOLE FRAME AND COVER

(ALL SANITARY MANHOLES SHALL HAVE

1. USE PRECAST CONCRETE GRADE ADJUSTMENT RINGS BETWEEN TOP SECTION AND FRAME TO RAISE MANHOLE TOP HEIGHT IF NECESSARY.

PROPOSED FINAL GROUND SURFACE-

USE ANCHOR BOLTS AND WATERPROOF GASKET AS SPECIFIED. EACH SECTION TO BE SUPPLIED WITH LIFTING

HOLES WHICH ARE TO BE GROUTED WITH WATERPROOF GROUT. SUBMIT SHOP DRAWINGS TO ENGINEER FOR

AND BOTTOM LIPS OF THE JOINT.

- APPROVAL. MAXIMUM RISER HEIGHT SHALL BE LIMITED TO
- JOINTS SHALL BE SEALED AT BOTH THE TOP

MANHOLE DIAMETER BASED ON MAXIMUM PIPE SIZE STRAIGHT THRU PIPE IF 90° ANGLE PIPE IF 180° ANGLE PIPE MANHOLE DIAMETER 18" 33" 27" 60" 33" 72**"** 36" 33" 36" 48" 36" 84" 54" 96" 42" 54"

STANDARD PRE-CAST MANHOLE NOT TO SCALE

STRUCTURE TABLE							
STRUCTURE NAME	STRUCTURE TYPE	STRUCTURE DETAILS	PIPES IN	PIPES OUT			
CLEAN OUT	SDR 35 CLEANOUT	SURFACE ELEV. = 1162.86 SUMP = 1158.0 INV IN = 1158.14 INV OUT = 1158.04	6" SDR 35 INV IN =1158.14	6" SDR 35 INV OUT =1158.04			
COMBO MH 2 EX	FIELD VERIFY	SURFACE ELEV. = 1155.10 SUMP = 144.8 INV IN = 1141.65	24" PS 115 INV IN =1141.65				
COMBO MH1 EX	FIELD VERIFY	SURFACE ELEV. = 1160.61 SUMP = 1144.4 INV OUT = 1144.36		24" PS 115 INV OUT =1144.36			
MH1	48" PRECAST MANHOLE	SURFACE ELEV. = 1156.51 SUMP = 1143.1 INV IN = 1143.19 INV OUT = 1143.09	24" PS 115 INV IN =1143.19	24" PS 115 INV OUT =1143.09			

PIPE TABLE					
NAME	SIZE	LENGTH	SLOPE	MATERIAL	
SAN EX1 TO SAN MH1	24"	142.25	0.82%	PS 115	
SAN MH2 TO EXMH2	24"	176.98'	0.81%	PS 115	
CO TO CONNECTION	6"	94.09'	13.86%	SDR 35	
BLGD TO CO	6"	17.68'	5.43%	SDR 35	

SANITARY STRUCTURE AND PIPE SCHEDULE NOT TO SCALE

205 Ross Street

Fukui Architects Pc


Pittsburgh, Pennsylvania 15219 ph 412.281.6001 fx 412.281.6002

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MONROEVILLE, PA 15146

OFFICE: 724.325.1215



general notes
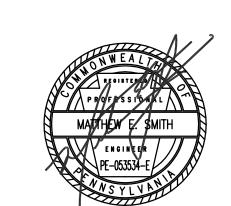
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revisions

project title

Owner:

HACP 200 Ross Street Pittsburgh, PA, 15219

Client:

Allies & Ross Management and Development Corporation (ARMDC) 200 Ross Street Pittsburgh, PA 15219

Project Location:

Northview Heights Midrise 246 Penfort Street Pittsburgh, PA 15214


drawing title

UTILITY DETAILS

As Noted December 3rd, 2023 38 | 233

Sheet No.

C550 Project #2040

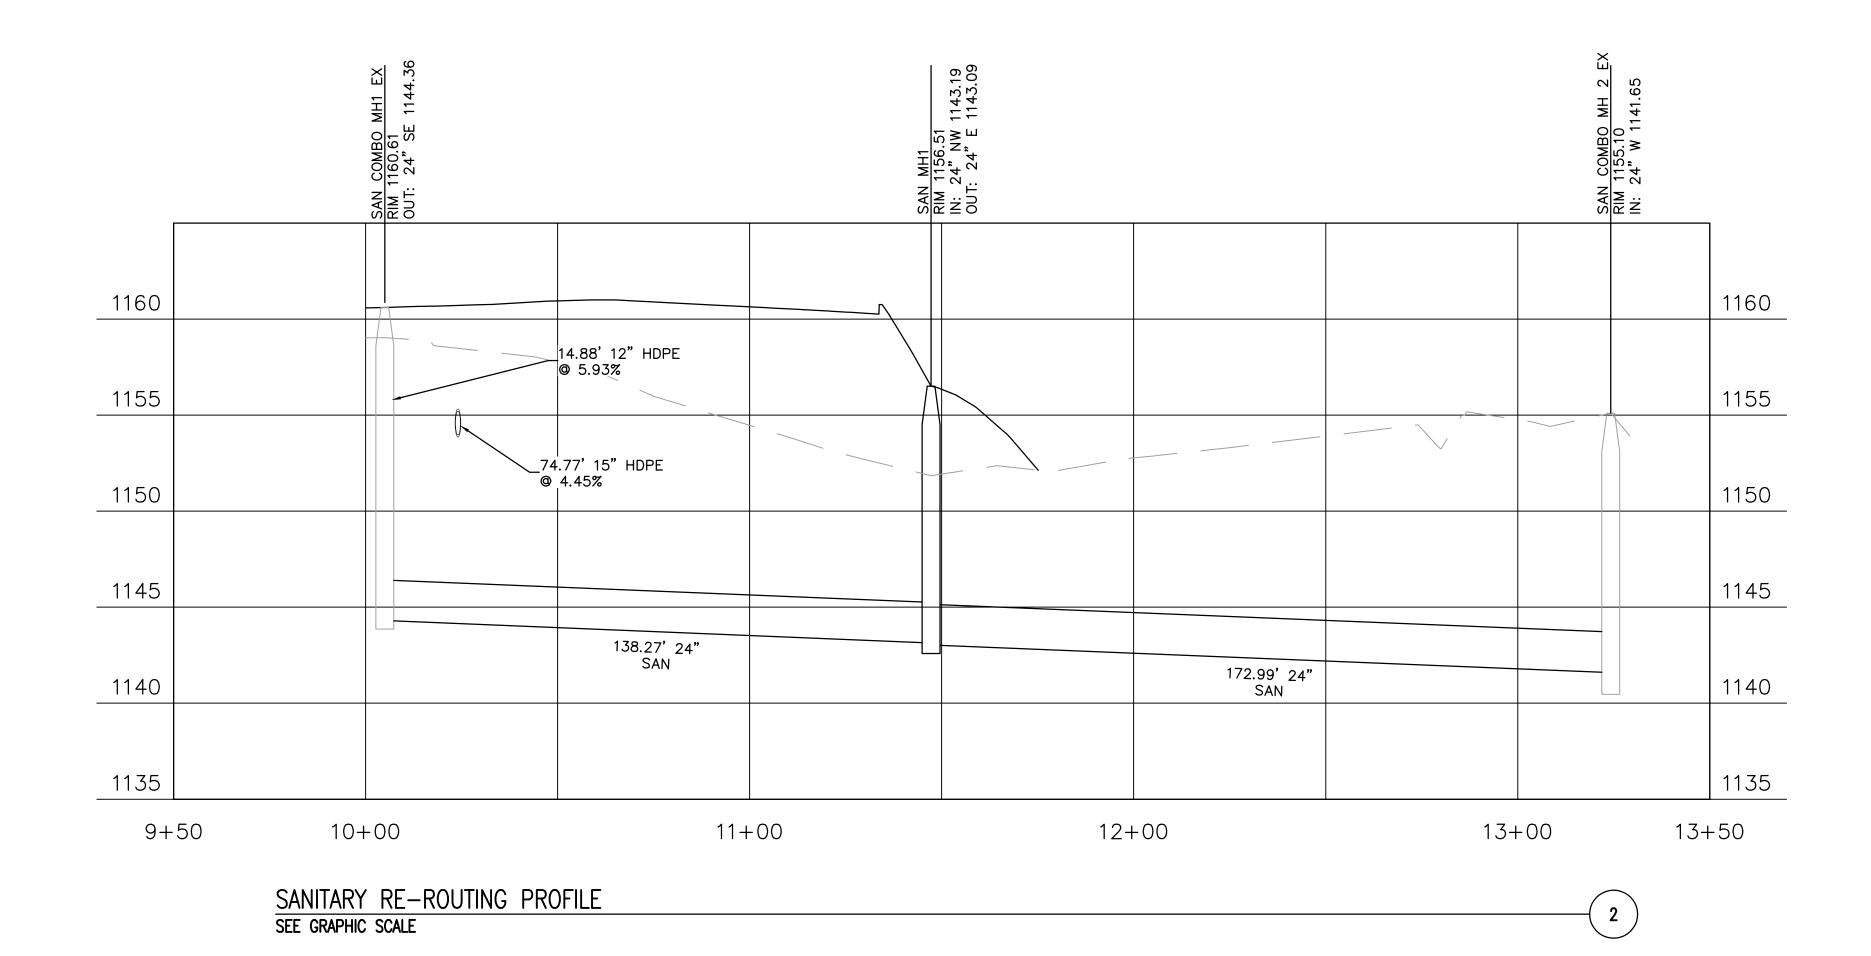

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REDIT SWING GROUP ENGINEERS & SURVEYORS 4314 OLD WILLIAM PENN HWY SUITE 101 MONROEVILLE, PA 15146

OFFICE: 724.325.1215

PROFESSION L

MANTHEW E. SMITH

ENGINEER

PE-053534-E

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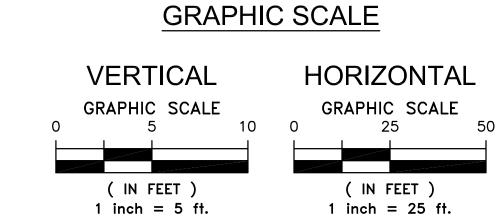
Northview Heights Midrise 246 Penfort Street Pittsburgh, PA 15214


SANITARY PROFILES

EXISTING GRADE

PROPOSED GRADE

LEGEND



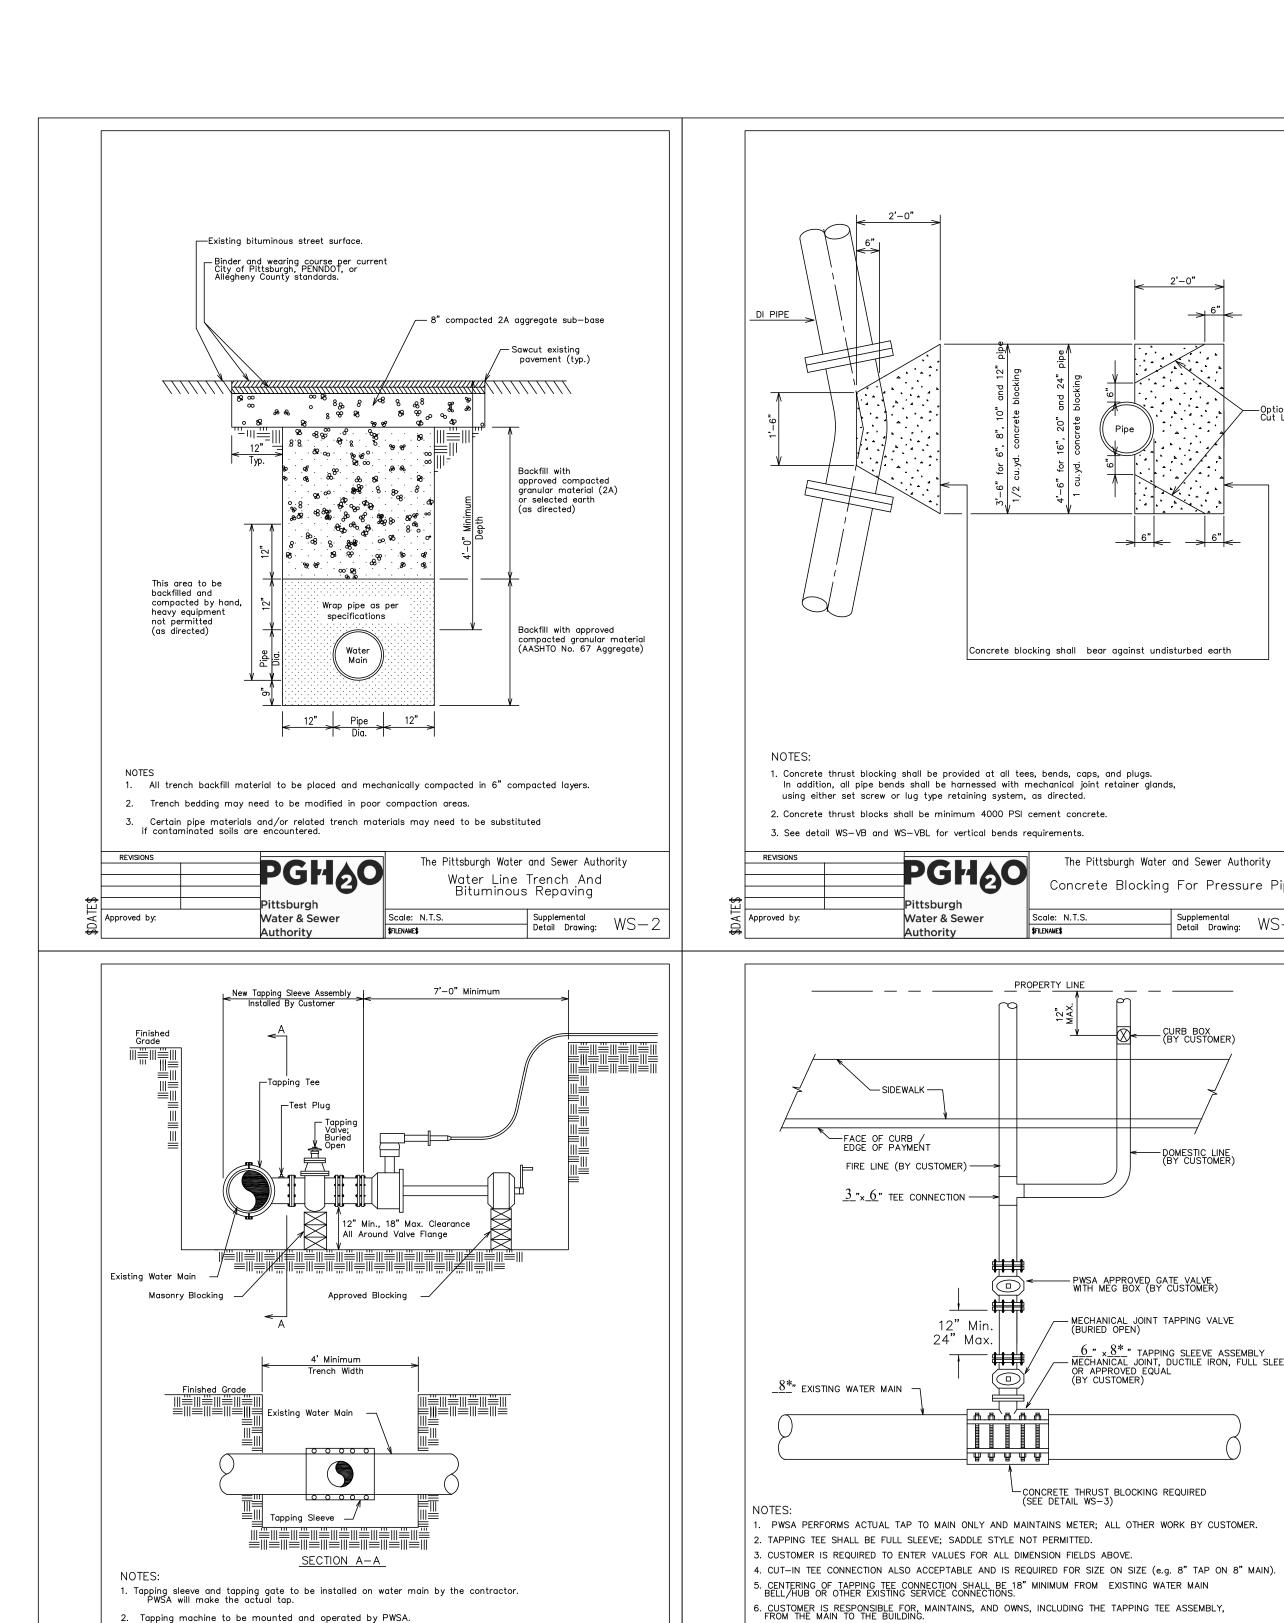

3. Excavation and shoring required as per current OSHA standards.

5. All valves must be "right turn to open".

Approved by:

4. Contractor must supply equipment to lower tapping machine in to trench.


Water & Sewer

PGH₂O

The Pittsburgh Water and Sewer Authority

Trench Requirements For 4" Through 12" Live Water Tap

Supplemental
Detail Drawing: WS—B

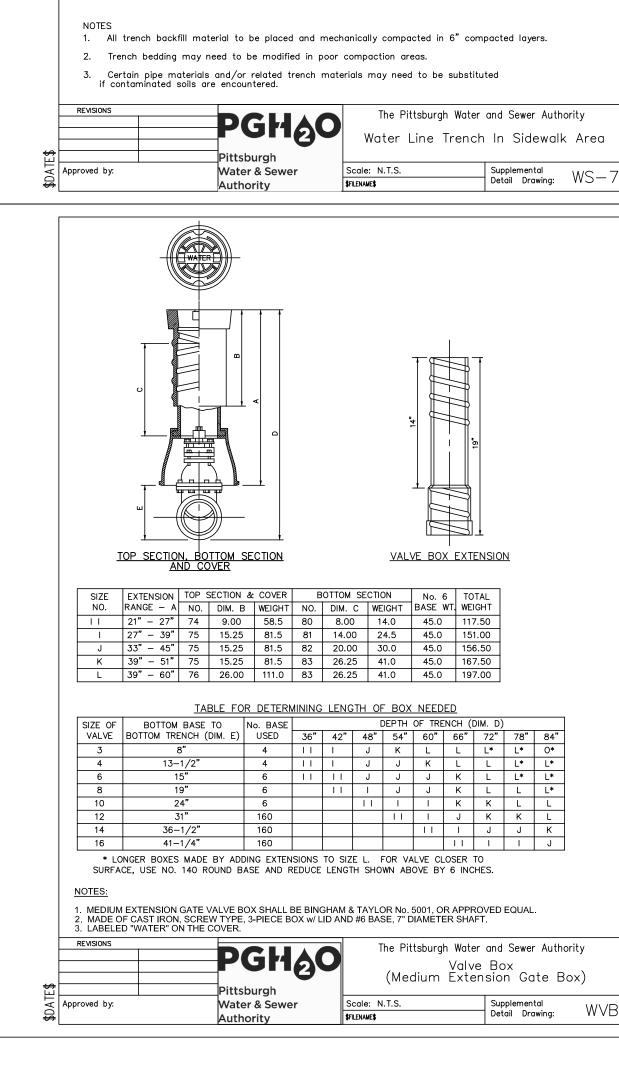

—Street pavement as per City of Pittsburgh, PENNDOT, or Allegheny County standards

optional, as per City of Pittsburgh standards

This area to be backfilled and compacted by hand

Concrete blocking shall bear against undisturbed earth

The Pittsburgh Water and Sewer Authority

Concrete Blocking For Pressure Pipe

DOMESTIC LINE (BY CUSTOMER)

- PWSA APPROVED GATE VALVE WITH MEG BOX (BY CUSTOMER)

-CONCRETE THRUST BLOCKING REQUIRED (SEE DETAIL WS-3)

— MECHANICAL JOINT TAPPING VALVE (BURIED OPEN)

 $\frac{6}{\text{MECHANICAL}}$ Tapping sleeve assembly mechanical joint, ductile iron, full sleeve or approved equal (by customer)

Single Service Connection (4" And larger)

Supplemental
Detail Drawing: WS—C1

Supplemental
Detail Drawing: WS—

: Wrap pipe as per

Water Main

Pipe | 12" | Pipe | 12" |

FINISHED GRADE CURB

MECHANICAL JOINT GATE VALVE -WITH RETAINER GLANDS

Approved by:

/ IMPROVED ROAD SURFACE (FOR UNIMPROVED ROAD, SEE NOTE BELOW)

-BURIED OPEN

The Pittsburgh Water and Sewer Authority

Service Connection 4" Through 8'

Detail Drawing: WS-A

(SEE DETAIL WVB)

VARIES

NOTES:

1. ALL PIPING TO BE RESTRAINED WITH RODDING AND/OR RETAINER GLANDS.
2. ALL FITTINGS SHALL HAVE THRUST BLOCKS (SEE DETAIL WS-3).
3. STANDARD GATE BOX LID: TWO NOTCH OPENINGS REQUIRED. DIAMETER TO MATCH BOX.
4. GATE BOX EXTENSION: GATE BOX EXTENSION RINGS ARE NOT TO BE USED IN NEW WORK.
5. A MAXIMUM OF 3 EXTENSION RINGS CAN BE USED PER EXISTING GATE BOX.
6. MEG BOX MATERIAL SHALL BE CAST IRON.
7. IF MEG BOX IS LOCATED IN AN UNIMPROVED AREA, THEN A 30"x30"x 8"D CONCRETE PAD APRON CENTERED AROUND THE MEG BOX IS REQUIRED.
8. ALL VALVES MUST BE "RIGHT TURN TO OPEN".
9. PRIVATE SERVICE LINE MATERIAL AND EQUIPMENT SHALL CONFORM TO ALLEGHENY COUNTY PLUMBING CODE, ARTICLE XV.

Water & Sewer

Authority

74", 6" OR 8" SERVICE LINE AS REQUIRED

-Finished surface to match existing or as

- 4" min. compacted AASHTO No. 57 approved aggregate

—Saw-cut existing sidewalk

Backfill with approved compacted granular material (2A) or selected earth

(as directed)

Backfill with

Aggregate)

granular material (AASHTO No. 67

specified for desired sidewalk type

*CONTRACTOR TO CONFIRM EXISTING PIPE SIZE

Water & Sewer

8. ALL VALVES MUST BE "RIGHT TURN TO OPEN".

Approved by:

7. ADDITIONAL BACKFLOW PREVENTION (RPZ TYPE) REQUIRED INTERNALLY ON COMMERCIAL OR HIGH HAZARD PROPERTIES.


9. PRIVATE SERVICE LINE MATERIAL AND EQUIPMENT SHALL CONFORM TO ALLEGHENY COUNTY PLUMBING CODE, ARTICLE XV.

Fukui Architects Pc

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OFFICE: 724.325.1215



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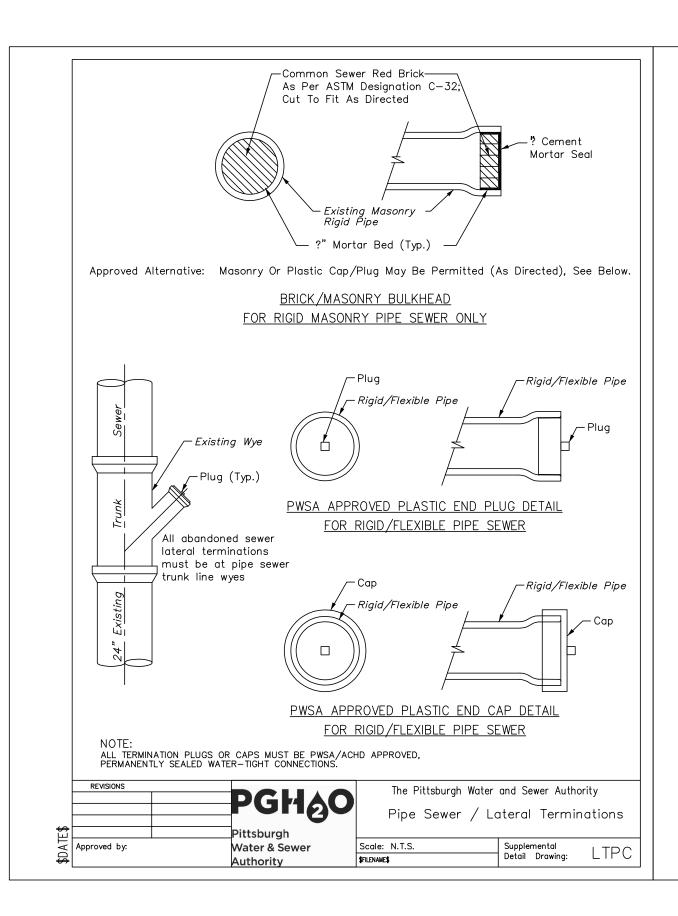
drawing title

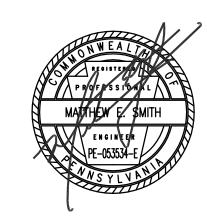
PWSA DETAILS 1 OF 2


As Not	ted
date	
December	3rd, 202
no.	of.


Sheet No.

C552



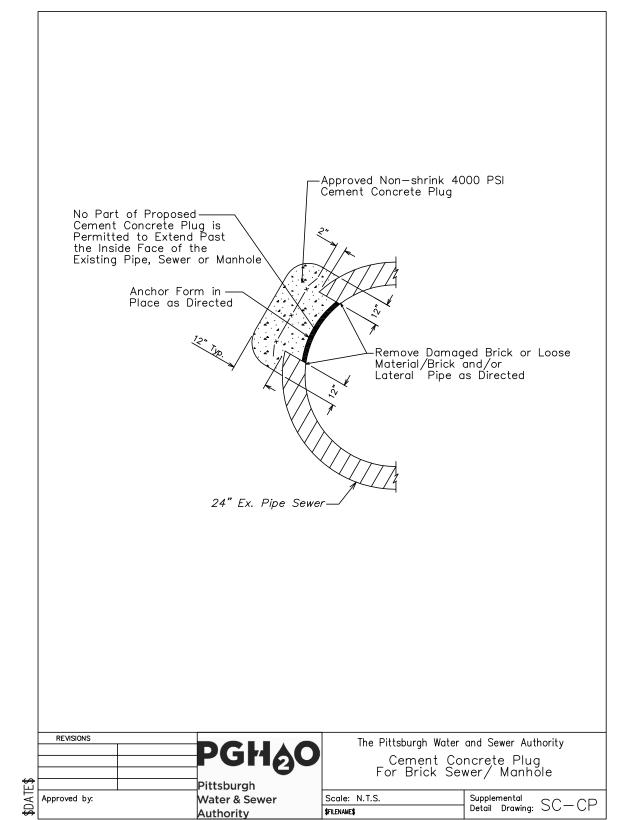

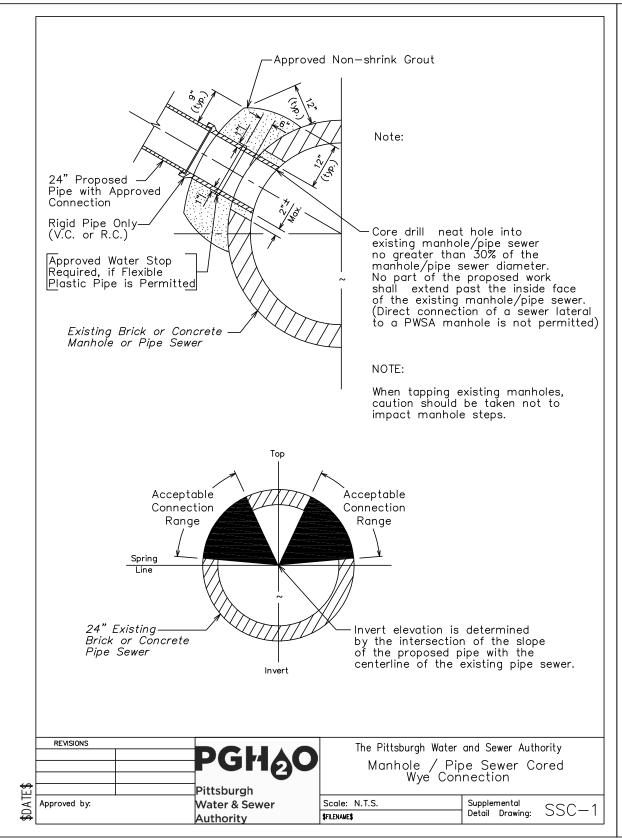

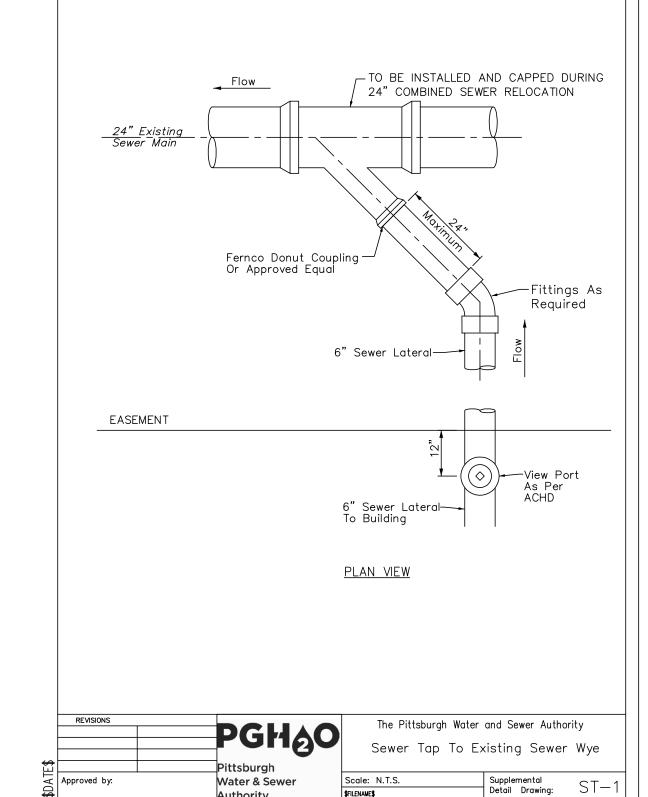

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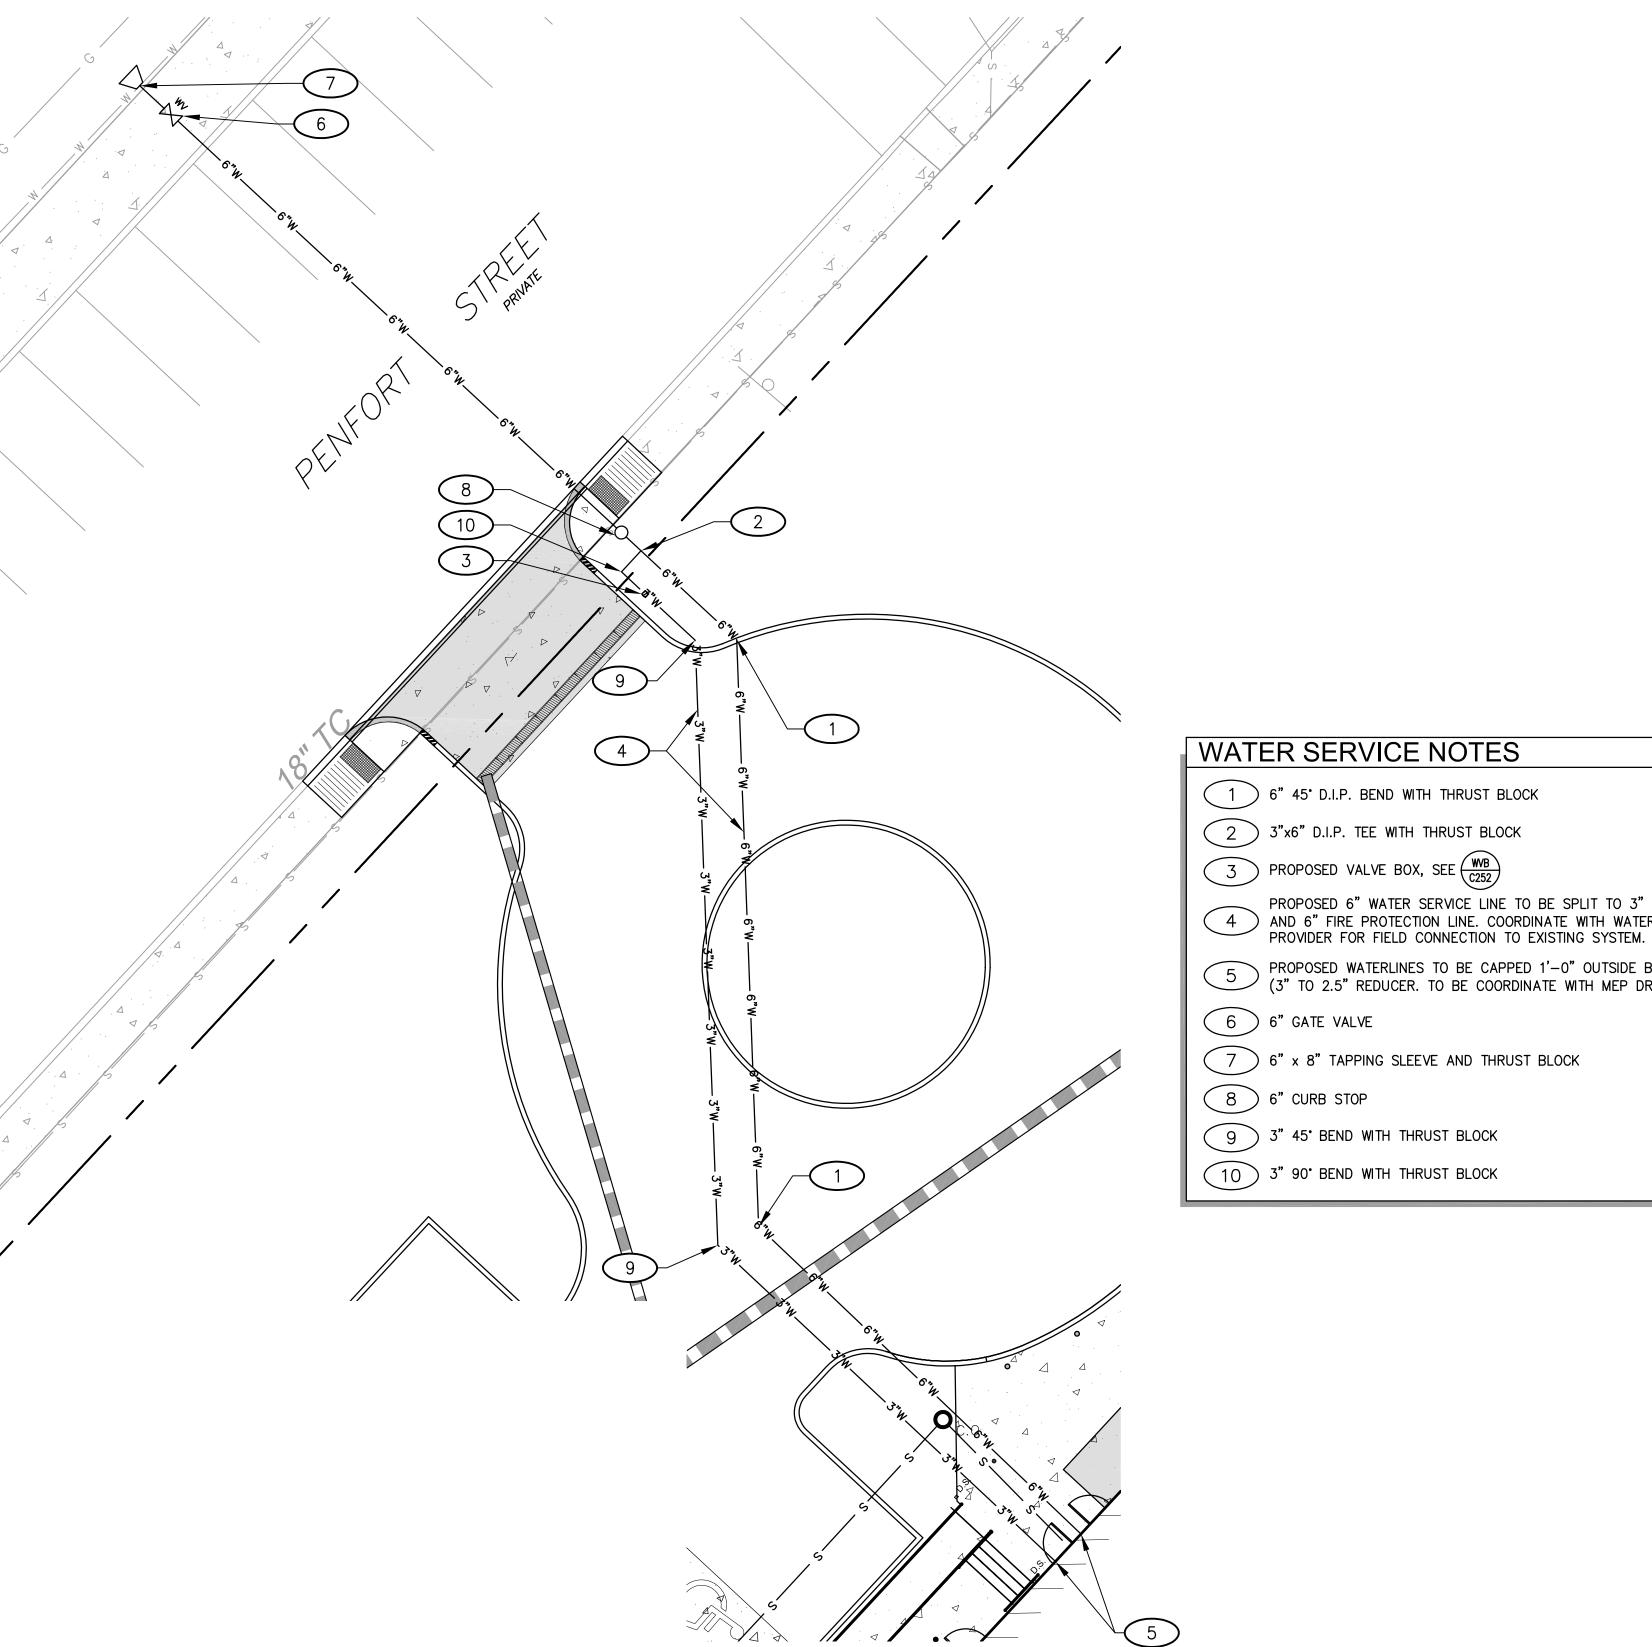
drawing title

PWSA DETAILS 2 OF 2

As Noted December 3rd, 2023

C553

Sheet No.



PROPOSED 6" WATER SERVICE LINE TO BE SPLIT TO 3" DOMESTIC (4) AND 6" FIRE PROTECTION LINE. COORDINATE WITH WATER SERVICE

PROPOSED WATERLINES TO BE CAPPED 1'-0" OUTSIDE BUILDING (3" TO 2.5" REDUCER. TO BE COORDINATE WITH MEP DRAWINGS)

WATER SERVICE LINE ENLARGEMENT SCALE: AS NOTED

Know what's **below. Call** before you dig. PA ONE CALL SERIAL No. 20212440672 AS PER CALL FOR MAPS BY RED SWING GROUP SEPTEMBER 1st 202

Fukui Architects Pc


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drawing title


WATER SERVICE ENLARGEMENT **PLAN**



(IN FEET)


1 inch = 10 ft.

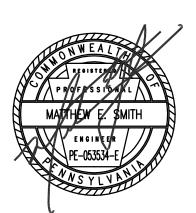

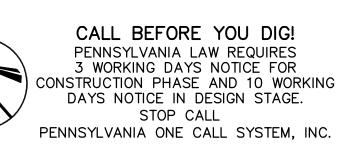

Sheet No. As Noted December 3rd, 2023

C554 Project #2040

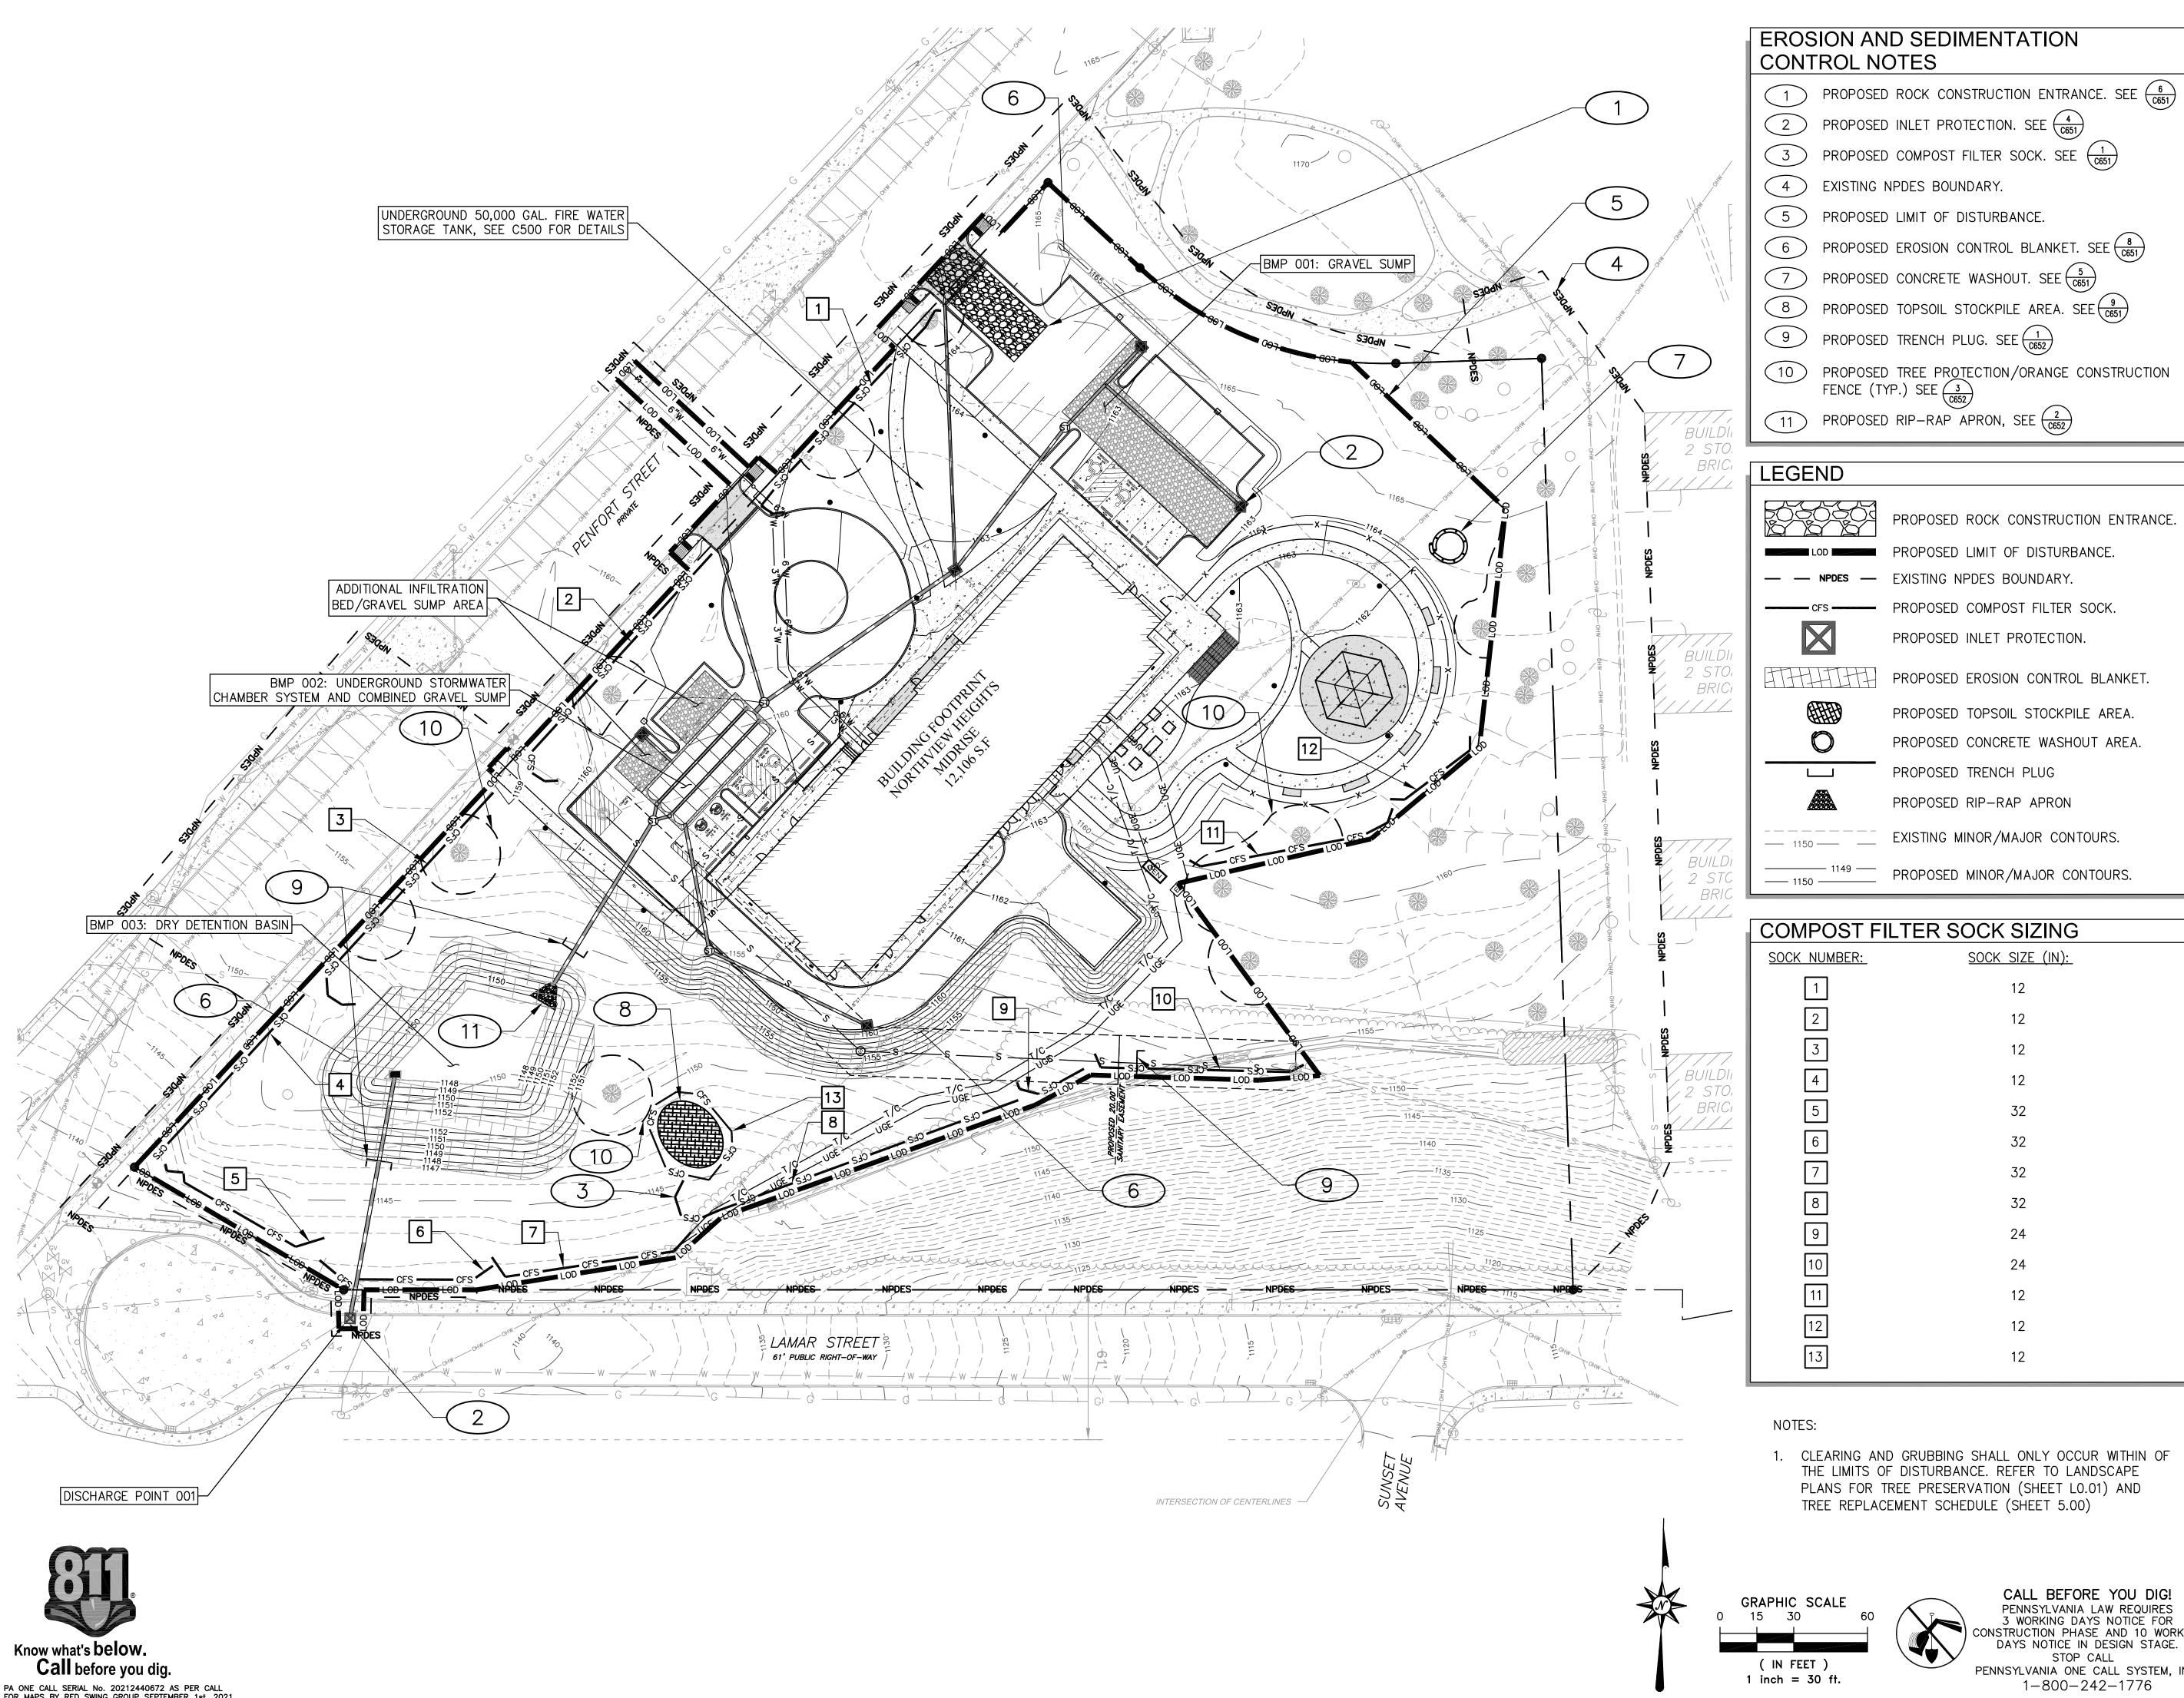

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project title

COMPOST FILT	TER SOCK SIZING	
SOCK NUMBER:	SOCK SIZE (IN):	
1	12	
2	12	
3	12	
4	12	
5	32	
6	32	
7	32	
8	32	
9	24	
10	24	
11	12	
12	12	
13	12	

PROPOSED ROCK CONSTRUCTION ENTRANCE.

PROPOSED LIMIT OF DISTURBANCE.

PROPOSED COMPOST FILTER SOCK.

PROPOSED EROSION CONTROL BLANKET.

PROPOSED TOPSOIL STOCKPILE AREA.

PROPOSED CONCRETE WASHOUT AREA.

EXISTING MINOR/MAJOR CONTOURS.

PROPOSED MINOR/MAJOR CONTOURS.

PROPOSED INLET PROTECTION.

PROPOSED TRENCH PLUG

PROPOSED RIP-RAP APRON

Owner:

HACP 200 Ross Street Pittsburgh,PA,15219

Client:


Allies & Ross Management and Development Corporation (ARMDC) 200 Ross Street Pittsburgh, PA 15219


Project Location:

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drawing title

EROSION AND SEDIMENTATION CONTROL PLAN



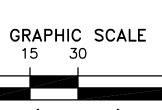

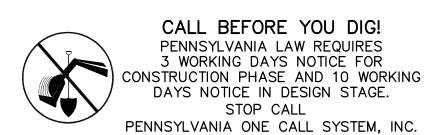1-800-242-1776

Sheet No. As Noted December 3rd, 2023

C600 Project #2040

GENERAL SEEDING SPECIFICATIONS

HE PENNSYLVANIA DEPARTMENT OF ENVIRONMENTAL PROTECTION RECOMMENDS USING THE PENN STATE "EROSION CONTROL AND CONSERVATION PLANTINGS ON NONCROPLAND" MANUAL AS A REFERENCE FOR SELECTION OF SPECIES, SEED SPECIFICATIONS, MIXTURES, LIMING AND FERTILIZING, TIME OF SEEDING, AND SEEDING METHODS. SPECIFICATIONS FOR THESE ITEMS MAY ALSO BE OBTAINED FROM THE PENNSYLVANIA DEPARTMENT OF TRANSPORTATION PUBLICATION 408, SECTION 804 OR BY CONTACTING THE APPLICABLE COUNTY CONSERVATION

VEGETATED AREAS WILL BE CONSIDERED PERMANENTLY STABILIZED WHEN A UNIFORM 70% ÆGETATIVE COVER OF EROSION RESISTANT PERENNIAL SPECIES IS ACHIEVED, OR THE DISTURBED AREA IS COVERED WITH AN ACCEPTABLE BEST MANAGEMENT PRACTICE ("BMP") WHICH PERMANENTLY MINIMIZES ACCELERATED EROSION AND SEDIMENTATION. UNTIL SUCH TIME AS THIS STANDARD IS ACHIEVED. INTERIM STABILIZATION MEASURES AND TEMPORARY EROSION AND SEDIMENT CONTROL BMPs THAT ARE USED TO TREAT PROJECT RUNOFF MAY IOT BE REMOVED.

TEMPORARY SEEDING SPECIFICATIONS

<u>PRELIMINARY PREPARATION:</u> ALL AREAS THAT WILL BE SEEDED MUST BE LOOSENED USING MECHANICAL MEANS. SOIL MUST BE LOOSENED TO A DEPTH OF AT LEAST TWO-INCHES.

<u>IME AND FERTILIZER:</u> APPLY 1 TON OF AGRICULTURAL GRADE LIMESTONE PER ACRE AND ERTILIZER AS INDICATED BY THE SOIL TEST. IN THE ABSENCE OF A SOIL TEST. APPLY AGRICULTURAL GRADE LIMESTONE AT A RATE OF 1 TON PER ACRE, AND APPLY FERTILIZER A 500 POUNDS OF 10-10-10 FERTILIZER PER ACRE (E.G., 166.67 POUNDS NITROGEN (N), 166.67 POUNDS PHOSPHOROUS (P_2O_5), AND 166.67 POUNDS POTASSIUM (K_2O) PER ACRE. WORK LIME AND FERTILIZER INTO SOIL WHERE POSSIBLE. LIME AND FERTILIZER DATA WAS OBTAINED FROM THE PADEP EROSION AND SEDIMENT CONTROL BEST MANAGEMENT PRACTICE (BMP) MANUAL, TABLE 11.2.

SEED: ALL SEED MUST BEAR A GUARANTEED STATEMENT OF ANALYSIS AND MUST BE PROPORTIONED BY WEIGHT WITH THE MINIMUM PURITY, READY GERMINATION, AND TOTAL GERMINATION OUTLINED BELOW. SEED DATA WAS OBTAINED FROM THE PADEP EROSION AND SEDIMENT CONTROL BEST MANAGEMENT PRACTICE (BMP) MANUAL, TABLES 11.3 AND 11.4.

SPECIES	PURITY (%)	READY GERMINATION (%)	TOTAL GERMINATION (%)	PURE LIVE SEED SEEDING RATE ¹ (LBS/ACRE)
SPRING-SUMMER				
SPRING OATS, OR	98	85	85	64
ANNUAL RYEGRASS	95	85	85	10
SUMMER-FALL				
ANNUAL RYEGRASS, OR	95	85	85	10
WINTER RYE, OR	98	85	85	90
WINTER WHEAT	98	85	85	112

1- PURE LIVE SEED (PLS) IS THE PRODUCT OF THE PERCENTAGE OF PURE SEED TIMES PERCENTAGE GERMINATION DIVIDED BY 100. FOR EXAMPLE, TO SECURE THE ACTUAL PLANTING RATE FOR ANNUAL RYEGRASS, DIVIDE THE PLS SEEDING RATE OF 10 LBS/ACRE BY THE PLS AS SHOWN ON THE SEED TAG. THUS, IF THE PLS CONTENT OF A GIVEN SEEDLOT IS 60%, DIVIDE 10 PLS (LBS/ACRE) BY 0.60 TO OBTAIN 16.7 LBS OF SEED REQUIRED TO PLANT ONE ACRE. ALL MIXTURES IN THIS TABLE ARE SHOWN IN TERMS OF

MULCH: ALL SEEDED AREAS MUST BE IMMEDIATELY MULCHED TO PROMOTE ADEQUATE VEGETATIVE COVER. USE CLEAN OAT OR WHEAT STRAW, FREE OF WEEDS, NOT CHOPPED O FINELY BROKEN. THE STRAW MUST BE FREE FROM MATURE SEED-BEARING STALKS OR ROOTS OF PROHIBITED OR NOXIOUS WEEDS AS DEFINED BY THE PENNSYLVANIA SEED ACT O

APPLY MULCH AT A RATE OF 3 TONS PER ACRE (I.E., 140 POUNDS PER 1,000 SQUARE FEET OR 1,240 POUNDS PER 1,000 SQUARE YARDS). THE MULCH MUST BE ANCHORED IMMEDIATELY AFTER APPLICATION. A TRACTOR-DRAWN IMPLEMENT MAY BE USED TO ANCHOR THE MULCH INTO THE SOIL. THIS METHOD IS LIMITED TO SLOPES SHALLOWER THAN OR EQUAL TO 3:1 AND THE EQUIPMENT MUST BE OPERATED ON THE CONTOUR.

STEEP SLOPE SEEDING SPECIFICATIONS

STEEP SLOPE SEEDING MIXTURE (FOR USE ON GRADES AT 3:1 OR GREATER SLOPES): ALL SLOPES GREATER THAN 3:1 SHALL BE COVERED WITH AN EROSION CONTROL LANKET IN ADDITION TO RECEIVING A GRASS SEEDING MIXTURE.

WHEN CONDITIONS PERMIT, NATIVE STEEP SLOPE MIX WITH ANNUAL RYEGRASS (ERNST MIX ERNMX-181 OR APPROVED EQUIVALENT) CAN BE UTILIZED ON STEEP SLOPES. REFER TO LANDSCAPE ARCHITECT PLANS AND PROJECT SPECIFICATIONS FOR SEEDING LOCATIONS AND ADDITIONAL INFORMATION ON SEEDING MIXES AND PLANTING.

ONCE A WEEK AND AFTER

EVERY RUNOFF EVENT

EVERY RUNOFF EVENT

ONCE A WEEK AND AFTER

UMPED WATER FILTER | DAILY AND AFTER EACH USE | BAG IS HALF FULL

EVERY RUNOFF EVENT

OMPOST FILTER SOCK ONCE A WEEK AND AFTER

ROCK CONSTRUCTION DAILY AND AFTER EACH

RUNOFF EVENT

RUNOFF EVENT

DAILY AND AFTER EACH

WEEKLY AND AFTER EACH

VEGETATIVE COVERAGE IS

RUNOFF EVENT UNTIL 70% BLANKETS

CONTROL MEASURE

NLET PROTECTION

NTRANCE

ONCRETE

WASHOUT AREA

ROSION CONTROL

EGETATION

ONSITE SEDIMENT CONTROL PLAN MAINTENANCE SCHEDULE

BARE SOIL PATCHES

RUNOFF ESCAPING

AROUND BARRIER

SEDIMENT LEVEL

FLOW CAPACITY

MISSING MATERIAL

LOST AND/OR DISLODGED

WASHOUT IS DAMAGED OR

ACCUMULATED MATERIALS

DAMAGED OR DISPLACED

EXCEED 50% OF CAPACITY

BUILDUP

STONES

l ROADWAYS

I FAKING

SEDIMENT AT TOE OF SLOPE CHECK FOR TOE OF SLOPE DIVERSION AND INSTALL IF NEEDED.

RESEED, FERTILIZE AND MULCH BARE AREAS.

SEDIMENT BUILD-UP REDUCING ONCE FULL OF SEDIMENT (I.E. SEDIMENT LEVEL TO TOP OF MAT OR VISIBLE

LOODING AROUND OR BELOW REMOVE ACCUMULATED SEDIMENT; OR CONVERT SEDIMENT BARRIER TO AN

SEDIMENT DEPOSITED IN PAVED AT THE END OF EACH CONSTRUCTION DAY, ALL SEDIMENT DEPOSITED ON

OUTLET SUCH AS A SEDIMENT TRAP.

RILLS AND GULLIES FORMING FILL RILLS AND REGRADE GULLIED SLOPES.

REPLACE BAG.

FUTURE USE.

4 CALENDAR DAYS

BAG IS CLOGGED OR FLOW IS REPLACE BAG.

PERMANENT SEEDING SPECIFICATIONS

PRELIMINARY PREPARATION: GRADE AS NECESSARY TO BRING SUBGRADE TO A TRUE, SMOOTH LOPE PARALLEL TO FINISH GRADE LEAVING ROOM FOR TOPSOIL PLACEMENT. PLACE TOPSOIL OVER SPECIFIED AREAS IN ACCORDANCE WITH PROJECT PLANS AND SPECIFICATIONS. TOPSOIL SHOULD BE PLACED AT A GREATER THICKNESS THAN SPECIFIED TO ALLOW FOR SETTLEMENT AND LIGHT ROLLING. THE FINAL COVER MUST CONFORM TO THE PROPOSED LINES, GRADES AND ELEVATIONS, REFER TO LANDSCAPE ARCHITECTURAL PLANS AND PROJEC SPECIFICATIONS FOR SEEDING LOCATIONS AND ADDITIONAL INFORMATION ON SEEDING MIXES AND PLANTING.

<u>LIME AND FERTILIZER:</u> PLACE LIME AND FERTILIZE AS SPECIFIED IN THE PROJECT SPECIFICATIONS.

THE FERTILIZER AND LIMESTONE MUST BE THOROUGHLY ANCORPORATED INTO THE SOIL BY MECHANICAL MEANS (E.G., ROTOTILLING) TO THE MINIMUM DEPTH SPECIFIED FOR THE

HE ENTIRE SURFACE MUST THEN BE REGRADED AND ROLLED. ALL AREAS THAT WILL BE SEEDED MUST BE LOOSENED USING MECHANICAL MEANS. SOIL MUST BE LOOSENED TO A DEPTH OF AT LEAST TWO INCHES.

<u>SEED:</u> SEEDING OPERATIONS SHALL BE PERFORMED IN ACCORDANCE WITH PROJECT SPECIFICATIONS.

ALL SEED MUST BEAR A GUARANTEED STATEMENT OF ANALYSIS AND MUST BE 100% PROPORTION BY WEIGHT WITH THE MINIMUM PURITY, READY GERMINATION, AND TOTAL GERMINATION OUTLINED BELOW OR BY PROJECT SPECIFICATIONS.

UNDERSTORY PLANTING PLAN AREA DESIGNATION*	SEED MIX	MIX SUPPLIER
DETENTION BASIN	ERNMX-183	ERNST SEEDS
NO-MOW COVER	PDOT-L (PennDOT)	ERNST SEEDS
LAWN	"TALL FESCUE PLUS"	EH GRIFFITH
STEEP SLOPE	ERNMX-181	ERNST SEEDS

*REFER TO LANDSCAPE ARCHITECTURAL PLAN SHEET L5.02 PLANTING PLAN - UNDERSTORY FOR DESIGNATED SEEDING AREAS.

MULCH: SEEDED AREAS MUST BE IMMEDIATELY MULCHED TO PROMOTE ADEQUATE VEGETATIVE COVER. USE CLEAN OAT OR WHEAT STRAW, FREE OF WEEDS, NOT CHOPPED OR FINELY BROKEN. ALTERNATIVE MULCHES MAY BE USED IN ACCORDANCE WITH THE PROJECT SPECIFICATION. THE STRAW MUST BE FREE FROM MATURE SEED-BEARING STALKS OR ROOTS OF PROHIBITED OR NOXIOUS WEEDS AS DEFINED BY THE PENNSYLVANIA SEED ACT OF 1947.

APPLY MULCH AT A RATE OF 3 TONS PER ACRE (I.E., 140 POUNDS PER 1,000 SQUARE FEET OR 1,240 POUNDS PER 1,000 SQUARE YARDS). THE MULCH MUST BE ANCHORED OR OTHERWISE BONDED WITH ASPHALT EMULSION IN ACCORDANCE WITH PROJECT SPECIFICATIONS MMEDIATELY AFTER APPLICATION. A TRACTOR—DRAWN IMPLEMENT MAY BE USED TO ANCHOR THE MULCH INTO THE SOIL. THIS METHOD IS LIMITED TO SLOPES SHALLOWER THAN OR EQUAL TO 3:1 AND THE EQUIPMENT MUST BE OPERATED ON THE CONTOUR.

FURTHER NOTES

EROSION AND SEDIMENTATION CONTROLS MUST BE CONSTRUCTED, STABILIZED, AND FUNCTIONAL BEFORE SITE DISTURBANCE WITHIN THE CONTRIBUTORY DRAINAGE AREAS OF THOSE CONTROLS.

AFTER FINAL SITE STABILIZATION IS ACHIEVED, TEMPORARY EROSION AND SEDIMENTATION CONTROLS MUST BE REMOVED. AREAS DISTURBED DURING REMOVAL OF THE CONTROLS MUST BE IMMEDIATELY STABILIZED. FINAL STABILIZATION IS DEFINED AS THE ACHIEVEMENT OF A MINIMUM UNIFORM 70% VEGETATIVE COVER OF EROSION RESISTANT PERENNIAL SPECIES HAS BEEN ACHIEVED ON ALL CONTRIBUTORY DRAINAGE AREAS.

SEDIMENT MUST BE REMOVED FROM INLET PROTECTION AFTER EACH RUNOFF EVENT.

ANY DISTURBED AREA ON WHICH ACTIVITY HAS CEASED AND WHICH WILL REMAIN EXPOSED FOR MORE THAN 4 DAYS MUST BE TEMPORARILY STABILIZED. DISTURBED AREAS THAT ARE EITHER AT FINISHED GRADE OR WILL NOT BE DISTURBED WITHIN ONE YEAR MUST BE STABILIZED IN ACCORDANCE WITH PERMANENT SEEDING SPECIFICATIONS.

POSSIBLE REMEDIES (TO BE PERFORMED

WITHIN 24 HOURS OR AS SOON AS SAFELY PRACTICAL.)

SECURELY ANCHOR WITH PROPER STAPLES. EXTEND BARRIER AS NEEDED.

WITHIN TOP OF MAT), INLET FILTER SHALL BE CLEANED PER DETAIL

EXCAVATED SEDIMENT TRAP; OR REROUTE RUNOFF TO A MORE SUITABLE

REPLACE MISSING STONES SO AS TO MAINTAIN SPECIFIED DIMENSIONS.

PAVED ROADWAYS SHALL BE RETURNED TO THE CONSTRUCTION SITE.

REMOVE ACCUMULATED MATERIALS AND REPLACE PLASTIC LINERS.

DEACTIVATE THE WASHOUT AND REPAIR OR REPLACE IT IMMEDIATELY FOR

DAMAGED OR DISPLACED BLANKETS SHALL BE RESTORED OR REPLACED WITHIN

REPAIR OR REPLACE PROTECTION MATERIALS AS NEEDED.

REMOVE SEDIMENT WHEN LEVEL REACHES HALF (1/2) OR MORE THE HEIGHT

CONSTRUCTION SEQUENCE

THE OVERALL SITE-WORK GENERALLY CONSISTS OF EARTHMOVING ACTIVITIES OVER APPROXIMATELY 2.95 +/- ACRES OF DISTURBED AREA TO PERFORM THE CONSTRUCTION OF THE MID-RISE APARTMENT COMPLEX, WHICH INCLUDES STORMWATER MANAGEMENT FACILITIES, NEW UTILITY INSTALLATION, LANDSCAPING, AND ASSOCIATED GRADING. THE CONSTRUCTION IS PROPOSED TO PROCEED IN THE FOLLOWING MANNER:

- AT LEAST SEVEN (7) DAYS BEFORE STARTING EARTH DISTURBANCE ACTIVITIES. THE OPERATOR SHALL INVITE CONTRACTORS INVOLVED IN PROPOSED EARTH DISTURBANCE ACTIVITIES, THE LANDOWNER, ALL APPROPRIATE MUNICIPAL OFFICIALS, AND A REPRESENTATIVE OF THE LOCAL CONSERVATION DISTRICT TO SCHEDULE AN ON-SITE PRE-CONSTRUCTION MEETING.
- AT LEAST 3 DAYS BEFORE STARTING EARTH DISTURBANCE ACTIVITIES, CONTRACTORS INVOLVED IN PROPOSED EARTH DISTURBANCE SHALL NOTIFY THE PENNSYLVANIA ONE CALL SYSTEM, INC. AT 1-800-242-1776 FOR BURIED UTILITY LOCATIONS.
- . STAKE OUT THE LIMIT OF DISTURBANCE FOR THE ACTIVE PORTION OF THE PROJECT. INSTALL TEMPORARY ROCK CONSTRUCTION ENTRANCE AS SHOWN ON THE PLAN.
- INSTALL ALL COMPOST FILTER SOCK PROTECTION AS SHOWN ON THE PLAN.

INSTALL INLET PROTECTION AROUND EXISTING SITE INLETS.

- TREES THAT ARE TO BE PROTECTED DURING CONSTRUCTION, AS SHOWN ON THE PLANS, SHALL BE TEMPORARILY PROTECTED WITH STANDARD SNOW FENCE OR ORANGE CONSTRUCTION FENCE IN ACCORDANCE WITH DETAILS SHOWN ON LANDSCAPE PLANS. SEE LANDSCAPE PLANS FOR
- 3. SET UP DESIGNATED TOPSOIL STOCKPILE AREA TO STORE STRIPPED TOPSOIL THROUGH SITE GRADING TO BE UTILIZED FOR RE-VEGETATION AND STABILIZATION.
- . PROCEED WITH SITE DEMOLITION AND HAUL-OFF OPERATIONS. 10. AS THE CONSTRUCTION PAD AREA IS CLEARED, BEGIN EARTHWORK ACTIVITIES TO BRING SITE TO ROUGH GRADE ELEVATIONS PER GEOTECHNICAL
- RECOMMENDATIONS. FILL SLOPE STABILIZATION SHOULD OCCUR IN 15 TO 25 FOOT VERTICAL INCREMENTS. NO MORE THAN 15,000 SQ FT OF DISTURBED AREA WHICH IS TO BE STABILIZED BY VEGETATION SHOULD REACH FINAL GRADE BEFORE INITIATING SEEDING AND MULCHING. DISTURBED SLOPES GREATER THAN 3:1 MUST BE COVERED WITH EROSION CONTROL BLANKETS AS SPECIFIED. 1. INSTALL CONCRETE WASHOUT FACILITY.
- 12. INSTALL PUMPED WATER FILTER BAG WHERE NECESSARY.

FOUNDATION AREAS MUST BE REMOVED VIA A PUMP AND FILTER BAG.

13. BEGIN AND COMPLETE INSTALLATION OF WALL(S) AS NECESSARY TO BRING SITE TO/NEAR FINAL GRADE ELEVATIONS.

14. BUILDING CONSTRUCTION MAY COMMENCE AFTER AREAS REACH FINAL GRADE ELEVATIONS AND THE CONCRETE WASHOUT FACILITY IS INSTALLED. IMPORTANT: OPEN FOUNDATION AREAS MUST BE PROTECTED FROM ACCUMULATING STORMWATER RUNOFF. STORMWATER THAT ACCUMULATES IN OPEN

- 15. INSTALL SANITARY SEWER LATERALS IF APPLICABLE. LIMIT DAILY TRENCH EXCAVATION AND SANITARY LINE INSTALLATION TO THE LENGTH OF PIPE PLACEMENT, BEDDING, AND BACKFILLING THAT CAN BE COMPLETED THE SAME DAY (WEATHER PERMITTING)
- 6. COMMENCE INSTALLING SITE STORM PIPES AND STRUCTURES ENSURING NO WATER ENTERS THE STRUCTURES UNTIL AREAS TRIBUTARY TO THE STRUCTURES ARE STABILIZED. STORM PIPES AND STRUCTURES SHALL BE INSTALLED STARTING FROM THE DOWN GRADIENT END AND WORKING IN AN UP-GRADIENT MANNER. INSTALL FILTER INLET PROTECTION IN ALL NEW INLETS AS THEY ARE INSTALLED. LIMIT DAILY TRENCH EXCAVATION AND STORM LINE INSTALLATION TO THE LENGTH OF PIPE PLACEMENT, BEDDING, AND BACKFILLING THAT CAN BE COMPLETED THE SAME DAY (WEATHER PERMITTING). TRENCH SPOILS SHALL BE USED UP-GRADIENT OF UTILITY TRENCH AS A TEMPORARY BERM TO DIVERT UPHILL RUNOFF FROM
- CRITICAL STAGE: CONSTRUCTION OF THE DRY EXTENDED DETENTION BASIN BMP.
- IMPORTANT: STORMWATER RUNOFF IS NOT TO BE DIRECTED TO UNPROTECTED STORMWATER CONVEYANCE SYSTEMS UNTIL THE SITE IS AT FINAL GRADE AND STABILIZED.
- 7. CONSTRUCT THE DETENTION BASIN EMBANKMENT, INCOMING HEADWALL/RIPRAP APRON, AND INSTALL THE OUTLET STRUCTURE IN ACCORDANCE WITH THE PROJECT PLAN AND DETAILS. APPLY PERMANENT STABILIZATION MEASURES TO ALL DISTURBED SURFACES DURING CONSTRUCTION OF THE DETENTION BASIN AS SOON AS PRACTICABLE IN ACCORDANCE WITH PROJECT PLANS AND DETAILS.

IMPORTANT: THE INSTALLATION OF THE DETENTION BASIN OUTLET STRUCTURE/PIPE IS A CRITICAL STAGE OF THE STORMWATER MANAGEMENT PLAN. THE CONTRACTOR SHALL CONTACT THE PROJECT ENGINEER ONE WEEK PRIOR TO EXPECTED OUTLET CONSTRUCTION SO THAT THE INSTALLATION CAN

CRITICAL STAGE: CONSTRUCTION OF THE GRAVEL SUMP AND UNDERGROUND STORMWATER CHAMBER SYSTEM BMPS

18. CONSTRUCTION OF INFILTRATION BEDS FOR THE TWO (2) GRAVEL SUMPS CAN COMMENCE.

A. EXCAVATE TO THE BOTTOM SPECIFIED FOR EACH SYSTEM IN THE PROJECT PLANS AND DETAILS TAKING CARE TO MINIMIZE COMPACTION IN THE BOTTOM OF THE EXCAVATIONS INSOFAR AS POSSIBLE. REMOVE UNSUITABLE MATERIALS INCLUDING BUT NOT LIMITED TO OLD FOUNDATIONS, LARGE COBBLES/BOULDERS, CONSTRUCTION DEBRIS LEFT FROM DEMOLITION OF FORMER STRUCTURES, ETC. SURFACES WITHIN THE INFILTRATION BED THAT ARE COMPACTED DURING CONSTRUCTION SHALL BE LOOSENED/SCARIFIED TO PROMOTE INFILTRATION PRIOR TO CONTINUING WITH GRAVEL/CHAMBER INSTALLATION.

B. PLACE SPECIFIED GEOTEXTILE IN BOTTOM OF EXCAVATION IN A MANNER THAT WILL ALLOW ENTIRE SYSTEM TO BE ENCAPSULATED ONCE CONSTRUCTED IN ACCORDANCE WITH PROJECT DETAILS. INSTALL PERFORATED UNDERDRAIN PIPE WRAPPED IN FABRIC WITH CLOSED VALVE IN OUTLET STRUCTURE TO ALLOW FOR FUTURE MAINTENANCE.

C. BACKFILL EXCAVATIONS WITH SPECIFIED DRAINAGE AGGREGATE TO THE ELEVATION OF THE INVERT OF THE UNDERGROUND CHAMBER SYSTEM AND/OR PERFORATED OUTLET PIPES. INSTALL CHAMBERS AND PERFORATED OUTLET PIPES IN ACCORDANCE WITH PROJECT PLANS AND DFTAILS AND MANUFACTURER'S INSTRUCTIONS. THE ENGINEER OR THEIR REPRESENTATIVE SHALL BE ALLOWED TO INSPECT THE OUTLET STRUCTURES AND OUTLET PIPES DURING THIS CRITICAL STAGE.

D. INSTALL PERFORATED INLET PIPES AND STRUCTURES, AND INSPECTION PORTS/CLEANOUTS AS NECESSARY AS CONTINUING TO BACKFILI THE EXCAVATIONS. FULLY ENCAPSULATE EACH GRAVEL SUMP SYSTEM IN FABRIC PRIOR TO CONTINUING BACKFILLING AND/OR CONSTRUCTING ABOVE SYSTEMS.

IMPORTANT: THE INSTALLATION OF THE UNDERGROUND GRAVEL SUMP OUTLET STRUCTURES/PIPES ARE CRITICAL STAGES OF THE STORMWATER MANAGEMENT PLAN. THE CONTRACTOR SHALL CONTACT THE PROJECT ENGINEER ONE WEEK PRIOR TO EXPECTED OUTLET CONSTRUCTION SO THAT THE INSTALLATION CAN BE OBSERVED.

- 19. INSTALL BUILDING UTILITY SERVICE LINES AND CONDUITS. LIMIT DAILY TRENCH EXCAVATION AND UTILITY LINE INSTALLATION TO THE LENGTH OF PIPE PLACEMENT, BEDDING, AND BACKFILLING THAT CAN BE COMPLETED THE SAME DAY (WEATHER PERMITTING). EXISTING PAVEMENT AND/OR SIDEWALK IN PATH OF UTILITY TRENCHING SHALL BE SAW-CUT AND/OR CONCRETE PANELS REMOVED TO NEAREST JOINT INSOFAR AS POSSIBLE. 20. BACKFILL AND RESTORE UTILITY TRENCHES WITHIN EXISTING ROADWAYS AS SOON AS PRACTICABLE.
- 20. FINE GRADE AREAS IN PREPARATION FOR PERMANENT SURFACING. 21. POUR AND APPROPRIATELY TOOL CONCRETE CURBING AND PADS.
- 22. PLACE NEW CONCRETE/PAVEMENT SURFACES. INSTALL SITE FEATURES SUCH AS BIKE RACKS, GAZEBO, SIDEWALKS, ETC.. REMAINING AREA SHALL RECEIVE PERMANENT SEEDING/PLANTING IN ACCORDANCE WITH THE LANDSCAPE PLAN, AND SEEDED AREAS ARE TO BE MULCHED PER PROJECT

THE SITE WILL BE CONSIDERED STABILIZED WHEN A MINIMUM UNIFORM 70% VEGETATIVE COVER OF EROSION RESISTANT PERENNIAL SPECIES IS ACHIEVED. WHEN SITE WORK IS COMPLETE AND THE SITE IS STABILIZED, REMOVE TEMPORARY EROSION AND SEDIMENT CONTROL BMPS, INCLUDING, BUT NOT LIMITED TO, COMPOST FILTER SOCKS, INLET PROTECTION, THE ROCK CONSTRUCTION ENTRANCE, AND THE CONCRETE WASHOUT FACILITY. DISTURBANCE CAUSED AS A RESULT OF EROSION AND SEDIMENT CONTROL BMP REMOVAL SHALL BE IMMEDIATELY VEGETATED AND STABILIZED.

UTILITY TRENCH CONSTRUCTION SEQUENCE:

EXPOSED TRENCH EXCAVATIONS HAVE HIGH POTENTIAL FOR ACCELERATED EROSION AND SEDIMENT POLLUTION. SINCE THESE EXCAVATIONS ARE TYPICALLY LOCATED AT LOWER ELEVATIONS ALONG OR ACROSS EARTH DISTURBANCE SITES, OPEN TRENCHES SERVE TO CONCENTRATE SEDIMENT-LADEN RUNOFF AND CONVEY IT TO SITE BOUNDARIES OR WATERWAYS. AN EFFECTIVE MEASURE TO REDUCE EROSION AND SEDIMENTATION DURING UTILITY CONSTRUCTION IS TO LIMIT THE SPECIFIC SCHEDULE AND SCOPE OF WORK ACTIVITIES AS FOLLOWS DURING CONSTRUCTION:

- LIMIT ADVANCE CLEARING AND GRUBBING OPERATIONS TO A DISTANCE OF TWO TIMES THE LENGTH OF PIPE INSTALLATION THAT CAN BE COMPLETED IN ONE DAY (WEATHER PERMITTING).
- WORK CREWS AND EQUIPMENT FOR TRENCHING, PLACEMENT OF PIPE, PLUG CONSTRUCTION AND BACKFILLING WILL BE SELF-CONTAINED AND SEPARATE FROM CLEARING AND GRUBBING, SITE RESTORATION AND STABILIZATION OPERATIONS.
- LIMIT DAILY TRENCH EXCAVATION TO THE LENGTH OF PIPE PLACEMENT, PLUG INSTALLATION AND BACKFILLING THAT CAN BE COMPLETED THE SAME DAY (WEATHER PERMITTING). TRENCH PLUGS WILL BE SPACED AND CONSTRUCTED IN ACCORDANCE WITH THE TRENCH PLUG DETAIL ON THE PLAN SHEETS.
- WATER THAT ACCUMULATES IN THE OPEN TRENCH WILL BE COMPLETELY REMOVED BY PUMPING WATER TO A CONTROL FACILITY OR FILTER BAG FOR THE REMOVAL OF SEDIMENT. WHEN THE FILTER BAG IS ½-FULL IT SHOULD BE REPLACED. ACCUMULATED SEDIMENT SHALL BE MIXED WITH SOIL AND PROPERLY DISPOSED OF ON THE SITE IF POSSIBLE OR DISPOSED OF AT AN OFFSITE AREA. THE CONTRACTOR SHALL BE RESPONSIBLE FOR DISPOSING OF EXCESS MATERIAL OFF—SITE AT A DEP APPROVED FACILITY. OFFSITE DUMPING FACILITIES SHALL HAVE AN APPROVED EROSION
- & SEDIMENT CONTROL PLAN. ON THE DAY FOLLOWING PIPE PLACEMENT AND TRENCH BACKFILLING, THE DISTURBED AREA WILL BE GRADED TO APPROXIMATE FINAL CONTOUR, AND THE APPROPRIATE TEMPORARY EROSION CONTROL MEASURE OR FACILITY WILL BE INSTALLED. SEEDING AND MULCHING OF DISTURBED AREAS WILL BE PERFORMED AT THE END OF EACH WORK WEEK.

IN CERTAIN SITUATIONS, TRENCHES CANNOT BE BACKFILLED UNTIL THE PIPE IS HYDROSTATICALLY TESTED, OR ANCHORS AND OTHER PERMANENT FEATURES ARE INSTALLED. IN THESE SITUATIONS, THE REQUIREMENTS LISTED ABOVE WILL REMAIN IN EFFECT WITH THE FOLLOWING EXCEPTIONS: DAILY BACKFILLING OF THE TRENCH MAY BE DELAYED FOR SIX DAYS. PRESSURE TESTING AND THE COMPLETE BACKFILLING OF THE OPEN TRENCH MUST BE COMPLETED BY THE SEVENTH WORKING DAY.

2. IF DAILY BACKFILLING IS DELAYED, THE DISTURBED AREA WILL BE GRADED TO APPROXIMATE FINAL CONTOUR, APPROPRIATE TEMPORARY EROSION CONTROLS WILL BE INSTALLED, AND THE AREAS SEEDED AND MULCHED WITHIN THE NEXT TWO CALENDAR DAYS.

MAINTENANCE PROGRAM

MAINTENANCE OF TEMPORARY CONTROLS: MAINTAIN TEMPORARY CONTROL MEASURES THROUGHOUT THE PROJECT PERIOD AS OUTLINED IN THE "MAINTENANCE SCHEDULE" SHOWN ON THE EROSION AND SEDIMENTATION CONTROL PLANS AND NARRATIVE.

IT SHALL BE THE RESPONSIBILITY OF THE PERMITTEE TO PERFORM INSPECTIONS OF ALL TEMPORARY AND PERMANENT EROSION AND SEDIMENTATION CONTROL MEASURES TO ENSURE THAT THEY ARE WORKING PROPERLY. THESE INSPECTIONS MUST BE CONDUCTED WEEKLY, AND DURING OR IMMEDIATELY AFTER EVERY RUNOFF EVENT. THE INSPECTION WILL INCLUDE, BUT NOT BE LIMITED TO:

1) INSPECT ALL CONTROLS AND REPAIR OR REPLACE AS NEEDED.

2) INSPECT ALL SLOPES FOR SIGNS OF EROSION AND/OR SEDIMENTATION, AND REPAIR AS NEEDED.

AN ADEQUATE SUPPLY OF ADDITIONAL EROSION/SEDIMENTATION CONTROL MATERIALS (E.G., STRAW BALES, EROSION NETTING, PLASTIC COVERING, WIRE MESH, SAND AND BURLAP SANDBAGS, ROCKS AND GRAVEL) MUST BE STOCKPILED ON-SITE. THESE SUPPLIES MUST BE USED FOR EMERGENCY REPAIRS TO/OR REPAIRS OF EXISTING SOIL EROSION AND SEDIMENTATION CONTROLS.

THE OWNER/DEVELOPER WILL MAINTAIN PERMANENT CONTROL FACILITIES.

EXCEPTIONS:

<u>CLEANING FREQUENCY AND ULTIMATE DISPOSAL OF WASTE:</u> CLEANING FREQUENCIES ARE SPECIFIED WITHIN THE MAINTENANCE SCHEDULE. SILT AND SEDIMENT REMOVED FROM ALL CONTROL MEASURES SHOULD BE MIXED WITH SOIL DURING EARTHWORK AND PROPERLY DISPOSED OF ON-SITE.

EROSION AND SEDIMENTATION CONTROL NOTES

EROSION AND SEDIMENTATION CONTROL NOTES:

- 1) A COPY OF THE APPROVED EROSION AND SEDIMENTATION CONTROL PLANS, NOTES, AND DETAILS DRAWINGS (STAMPED/SIGNED AND DATED BY THE REVIEWING AGENCY) MUST BE AVAILABLE AT THE PROJECT SITE AT ALL TIMES.
- 2) ALL EARTH DISTURBANCE ACTIVITIES SHALL GENERALLY PROCEED IN ACCORDANCE WITH THE CONSTRUCTION SEQUENCE PROVIDED. BEFORE IMPLEMENTING ANY REVISIONS TO THE APPROVED ESCP OR REVISIONS TO OTHER PLANS THAT MAY AFFECT OR IMPACT THE EFFECTIVENESS OF THE APPROVED E&S CONTROL PLAN, THE OPERATOR MUST RECEIVE APPROVAL OF THE REVISIONS FROM THE LOCAL CONSERVATION DISTRICT
- 3)IN ADDITION TO THE PERMIT APPLICANT, INDIVIDUALS OR PARTIES WANTING TO CONDUCT INTRUSIVE EARTH DISTURBANCE ACTIVITIES ARE REQUIRED TO BE ADDED TO THE NPDES PERMIT AS A CO-PERMITTEE (IF NPDES APPLICABLE).
- 4) AT LEAST THREE (3) DAYS BEFORE STARTING ANY EARTH DISTURBANCE ACTIVITIES, ALL CONTRACTORS INVOLVED IN THOSE ACTIVITIES SHALL NOTIFY THE PENNSYLVANIA ONE CALL SYSTEM INC. AT 1-800-242-1776 FOR BURIED UTILITIES LOCATION.
- 5) AT LEAST SEVEN (7) DAYS BEFORE STARTING ANY EARTH DISTURBANCE ACTIVITIES, THE OPERATOR SHALL INVITE ALL CONTRACTORS INVOLVED IN THOSE ACTIVITIES. THE LANDOWNER, ALL APPROPRIATE MUNICIPAL OFFICIALS, AND A REPRESENTATIVE OF THE LOCAL CONSERVATION DISTRICT TO SCHEDULE AN ON-SITE PRE-CONSTRUCTION MEETING.
- 6)IMPORTANT: IMMEDIATELY UPON DISCOVERING UNFORESEEN CIRCUMSTANCES POSING THE POTENTIAL FOR ACCELERATED EROSION AND/OR POLLUTION, THE OPERATOR SHALL IMPLEMENT APPROPRIATE BMPS TO MINIMIZE THE POTENTIAL FOR EROSION AND SEDIMENT POLLUTION AND NOTIFY THE LOCAL CONSERVATION DISTRICT AND/OR THE REGIONAL PENNSYLVANIA DEPARTMENT OF ENVIRONMENTAL PROTECTION (PADEP)
- 7)THE OPERATOR SHALL REMOVE FROM THE SITE, RECYCLE OR DISPOSE OF ALL BUILDING MATERIALS AND CONSTRUCTION WASTES IN ACCORDANCE WITH THE DEPARTMENT'S SOLID WASTE MANAGEMENT REGULATIONS AT 25 PA CODE 260.1 ET SEQ., 271.1 ET SEQ. AND 287.1 ET SEQ. NO BUILDING MATERIALS, WASTES, OR UNUSED BUILDING MATERIALS SHALL BE BURNED, BURIED, DUMPED OR DISCHARGED AT THE SITE. THE FOLLOWING DEFINE WHAT SHOULD BE CONSIDERED "CONSTRUCTION WASTE" AND "CLEAN FILL":
 - A. CONSTRUCTION WASTE INCLUDES BUT IS NOT LIMITED TO, EXCESS SOIL MATERIALS, BUILDING MATERIALS, CONCRETE WASH WATER, SANITARY WASTES, ETC. THAT COULD ADVERSELY IMPACT WATER QUALITY.
 - B. CLEAN FILL UNCONTAMINATED, NON-WATER-SOLUBLE, NON-DECOMPOSABLE, INERT, SOLID MATERIAL. THIS INCLUDES SOIL, ROCK, STONE DREDGED MATERIAL, USED ASPHALT, AND BRICK, BLOCK, OR CONCRETE FROM CONSTRUCTION AND DEMOLITION ACTIVITIES THAT IS SEPARATE FROM OTHER WASTE AND IS RECOGNIZABLE AS SUCH. IT DOES NOT INCLUDE MATERIALS PLACED IN OR ON THE SURFACE WATERS UNLESS OTHERWISE AUTHORIZED, MILLED ASPHALT, OR ASPHALT THAT HAS BEEN PROCESSED FOR RE-USE.
- 8) ALL PARTIES RESPONSIBLE FOR THE EXCAVATION OF SITE MATERIALS OR THE IMPORT OF FILL MATERIALS ARE RESPONSIBLE TO ENSURE THAT "ENVIRONMENTAL DUE DILIGENCE" IN THE DETERMINATION OF CLEAN FILL MATERIAL IS EITHER REMOVED FROM THE SITE OR USED AS FILL FOR THE SITE. ANY MATERIAL IDENTIFIED AS HAZARDOUS MUST BE DISPOSED IN ACCORDANCE WITH ALL APPLICABLE STATE AND FEDERAL GUIDELINES AND REGULATIONS.
- A. ENVIRONMENTAL DUE DILIGENCE INVESTIGATIVE TECHNIQUES, INCLUDING, BUT NOT LIMITED TO, VISUAL PROPERTY INSPECTIONS, ELECTRONIC DATA BASE SEARCHES, REVIEW OF OWNERSHIP AND USE HISTORY OF PROPERTY, SANBORN MAPS, ENVIRONMENTAL QUESTIONNAIRES, TRANSACTION SCREENS, ANALYTICAL TESTING, ENVIRONMENTAL ASSESSMENTS OR AUDITS.
- 9) BEFORE DISPOSING OF SOIL OR RECEIVING BORROW FOR THE SITE, THE OPERATOR MUST ASSURE THAT EACH SPOIL OR BORROW AREA HAS AN ESCP APPROVED BY THE LOCAL CONSERVATION DISTRICT OF THE DEP. AND WHICH IS BEING IMPLEMENTED AND MAINTAINED ACCORDING TO CHAPTER 102 REGULATIONS. THE OPERATOR SHALL ALSO NOTIFY THE LOCAL CONSERVATION DISTRICT IN WRITING OF ALL RECEIVING SPOIL AND BORROW AREAS WHEN THEY HAVE BEEN IDENTIFIED.
- 10) THE ROCK CONSTRUCTION ENTRANCE WILL BE THE ONLY ENTRANCE USED BY CONSTRUCTION VEHICLES. NO CONSTRUCTION VEHICLES SHALL BE PERMITTED TO ENTER AREAS OUTSIDE OF THE LIMIT OF DISTURBANCE BOUNDARIES AS SHOWN ON THE E&S PLAN DRAWING.
- 11) THE CONTRACTOR SHALL TAKE ALL APPROPRIATE ACTIONS NECESSARY TO PREVENT TRUCKS FROM DEPOSITING SEDIMENT ON THE PUBLIC STREETS. SEDIMENT TRACKED ONTO PUBLIC ROADWAYS OR SIDEWALKS SHALL BE RETURNED TO THE CONSTRUCTION SITE BY THE END OF EACH WORK DAY AND DISPOSED OF IN THE MANNER DESCRIBED IN THIS PLAN. IN NO CASE SHALL THE SEDIMENT BE WASHED, SHOVELED, OR SWEPT INTO ANY ROADSIDE DITCH, STORM SEWER, OR SURFACE WATER.
- 12) REMOVE ALL DEMOLITION MATERIALS TO A SUITABLE DISPOSAL SITE IN A RESPONSIBLE MANNER. THE CONTRACTOR SHALL BE RESPONSIBLE FOR DISPOSING OF ALL EXCESS MATERIAL OFF-SITE TO AN APPROVED FACILITY (AS PER NOTE 8, AND SEE NOTE 7 FOR THE DEFINITION OF CONSTRUCTION WASTES).
- 13) CLEARING, GRUBBING, AND TOPSOIL STRIPPING SHALL BE LIMITED TO BE WITHIN THE IDENTIFIED DISTURBANCE LIMITS. THE CONTRACTOR SHALL BE RESPONSIBLE FOR DISPOSING OF ALL EXCESS MATERIAL OFF-SITE TO AN APPROVED FACILITY (AS PER NOTE 8 AND SEE NOTE 7 FOR THE DEFINITION OF CONSTRUCTION WASTES).
- 4) IMPORTANT: STORMWATER RUNOFF IS NOT TO BE DIRECTED TO UNPROTECTED STORMWATER MANAGEMENT SYSTEMS, STORMWATER CONVEYANCE SYSTEMS, OR INFILTRATION BED AREAS UNTIL THE SITE IS AT FINAL GRADE AND STABILIZED.
- 15) STOCKPILE HEIGHTS MUST NOT EXCEED 15 FEET. STOCKPILE SIDE SLOPES MUST BE 3H:1V MAXIMUM.
- 16) DURING UTILITY LINE CONSTRUCTION, EXCAVATE UTILITY LINE TRENCHES ONLY AS REQUIRED. LIMIT ADVANCE EXCAVATION TO A DISTANCE EQUAL TO TWO TIMES THE LENGTH OF PIPE INSTALLATION THAT CAN BE COMPLETED IN ONE DAY. LIMIT DAILY TRENCH EXCAVATION TO THE LENGTH OF PIPE PLACEMENT, PLUG INSTALLATION AND BACKFILLING THAT CAN BE COMPLETED THE SAME DAY. TRENCH PLUGS, AS SHOWN ON THE DRAWINGS, ARE TO BE INSTALLED PER PADEP CHAPTER 102 REQUIREMENTS. WATER, WHICH ACCUMULATES IN THE OPEN TRENCH, WILL BE COMPLETELY REMOVED BY PUMPING INTO A FILTER BAG IN ACCORDANCE WITH PADEP CHAPTER 102 REQUIREMENTS. ON THE DAY FOLLOWING PIPE PLACEMENT AND TRENCH BACKFILLING, THE DISTURBED AREA WILL BE GRADED TO FINAL GRADE, AND SEEDED AND MULCHED
- 17) FILTREXX SILTSOXX™, INLETSOXX™, RUNOFF DIVERSION SOXX™, AND ANY OTHER FILTREXX BMPS EMPLOYED AS PART OF THE ESCP FOR THE PROJECT MUST FOLLOW THE MANUFACTURER'S DISPOSAL/RECYCLING INSTRUCTIONS FOR EACH SPECIFIC BMP UTILIZED THROUGHOUT THE PROJECT'S CONSTRUCTION AND EARTHMOVING OPERATIONS.
- 18) DURING FOUNDATION CONSTRUCTION, PUMP WATER ACCUMULATED IN OPEN TRENCHES INTO FILTER BAGS IN ACCORDANCE WITH PADEP CHAPTER 102 REQUIREMENTS. REFER TO DETAIL 7 ON C603. WHEN THE FILTER BAG IS 1/2-FULL IT SHOULD BE REPLACED. ANY ACCUMULATED SEDIMENTATION WILL BE MIXED WITH SOIL AND PROPERLY DISPOSED OF ON THE SITE IF POSSIBLE OR DISPOSED OF AT AN OFFSITE AREA. THE CONTRACTOR SHALL BE RESPONSIBLE FOR DISPOSING OF ALL EXCESS MATERIAL OFF-SITE TO AN APPROVED FACILITY (AS PER NOTE 8).
- 19) IMPORTANT: A LOG SHOWING DATES THAT E&S BMPS WERE INSPECTED, AS WELL AS ANY DEFICIENCIES FOUND AND THE DATE THAT THEY WERE CORRECTED, SHALL BE MAINTAINED ON THE SITE AND BE MADE AVAILABLE TO REGULATORY AGENCY OFFICIALS AT THE TIME OF INSPECTION.
- 20) ALL SEDIMENT REMOVED FROM BMPS SHALL BE DISPOSED OF IN ACCORDANCE WITH NOTE 8.
- 21) ALL GRADED AREAS SHALL BE PERMANENTLY STABILIZED UPON REACHING FINAL GRADE. CUT SLOPES IN COMPETENT BEDROCK AND ROCK FILLS NEED NOT BE VEGETATED. 22) AREAS WHICH ARE TO RECEIVE TOPSOIL SHALL BE SCARIFIED TO A MINIMUM DEPTH OF 4 INCHES PRIOR TO PLACEMENT OF TOPSOIL. AREAS
- TO BE VEGETATED SHALL HAVE A MINIMUM 4 INCHES OF TOPSOIL IN PLACE PRIOR TO SEEDING AND MULCHING, FILL OUTSLOPES SHALL HAVE A MINIMUM OF 2 INCHES OF TOPSOIL. 23) UNTIL THE SITE IS STABILIZED, ALL E&S BMPS MUST BE MAINTAINED PROPERLY. MAINTENANCE MUST INCLUDE INSPECTIONS OF ALL E&S BMPS AFTER EACH RUNOFF EVENT AND ON A WEEKLY BASIS. ALL PREVENTATIVE AND REMEDIAL MAINTENANCE WORK, INCLUDING CLEAN OUT,
- REPAIR, REPLACEMENT, REGARDING, RESEEDING, REMULCHING AND RENETTING MUST BE PERFORMED IMMEDIATELY. IF E&S BMPS FAIL TO PERFORM AS EXPECTED, REPLACEMENT BMPS, OR MODIFICATIONS OF THOSE INSTALLED WILL BE REQUIRED. 24) UPON COMPLETION OF ANY EARTH DISTURBANCE ACTIVITY OR ANY STAGE OR PHASE OF AN ACTIVITY, THE SITE SHALL BE IMMEDIATELY SEEDED, MULCHED OR OTHERWISE PROTECTED FROM ACCELERATED EROSION AND SEDIMENTATION. DURING NON-GERMINATING MONTHS, MULCH
- OR PROTECTIVE BLANKETING SHALL BE APPLIED AS DESCRIBED IN THE PLAN. AREAS NOT AT FINISHED GRADE, WHICH WILL BE REACTIVATED WITHIN 1 YEAR, MAY BE STABILIZED IN ACCORDANCE WITH THE TEMPORARY STABILIZATION SPECIFICATIONS. THOSE AREAS WHICH WILL NOT BE REACTIVATED WITHIN 1 YEAR SHALL BE STABILIZED IN ACCORDANCE WITH THE PERMANENT STABILIZATION SPECIFICATIONS.
- 25) EROSION AND SEDIMENTATION CONTROL BMPS SHALL BE IMPLEMENTED AND MAINTAINED UNTIL PERMANENT STABILIZATION OF ALL TRIBUTARY AREAS HAS BEEN ACHIEVED. FOR AN EARTH DISTURBANCE ACTIVITY OR ANY STAGE OF AN ACTIVITY TO BE CONSIDERED PERMANENTLY STABILIZED, THE DISTURBED AREAS SHALL BE COVERED BY ONE OF THE FOLLOWING:
- A. A MINIMUM UNIFORM 70% VEGETATIVE COVER OF EROSION RESISTANT PERENNIAL SPECIES HAS BEEN ACHIEVED.
- B. AN ACCEPTABLE BMP THAT PERMANENTLY MINIMIZES ACCELERATED EROSION AND SEDIMENTATION.
- 26) AFTER FINAL SITE STABILIZATION HAS BEEN ACHIEVED, TEMPORARY E&S BMPS MUST BE REMOVED OR CONVERTED TO PERMANENT POST CONSTRUCTION STORMWATER MANAGEMENT BMPS. AREAS DISTURBED DURING REMOVAL OR CONVERSION OF THE BMPS MUST BE STABILIZED IMMEDIATELY. IN ORDER TO ENSURE RAPID RE-VEGETATION OF DISTURBED AREAS, SUCH REMOVAL/CONVERSION SHOULD BE DONE ONLY DURING GERMINATING SEASON.
- 27) UPON COMPLETION OF ALL EARTH DISTURBANCE ACTIVITIES AND PERMANENT STABILIZATION OF ALL DISTURBED AREAS, THE OWNER AND/OR OPERATOR SHALL CONTACT THE LOCAL CONSERVATION DISTRICT TO SCHEDULE A FINAL INSPECTION.
- 28) IMPORTANT: FAILURE TO CORRECTLY INSTALL E&S BMPS, FAILURE TO PREVENT SEDIMENT-LADEN RUNOFF FROM LEAVING THE CONSTRUCTION SITE, OR FAILURE TO TAKE IMMEDIATE CORRECTIVE ACTION TO RESOLVE FAILURE OF E&S BMPS MAY RESULT IN ADMINISTRATIVE, CIVIL, AND/OR CRIMINAL PENALTIES INSTITUTED BY THE PENNSYLVANIA DEPARTMENT OF ENVIRONMENTAL PROTECTION AS DEFINED IN SECTION 602 OF THE PENNSYLVANIA CLEAN STREAMS LAW. THE CLEAN STREAMS LAW PROVIDES FOR UP TO \$10,000 PER DAY IN CIVIL PENALTIES, UP TO \$10,000 IN SUMMARY CRIMINAL PENALTIES, AND UP TO \$25,000 IN MISDEMEANOR CRIMINAL PENALTIES FOR EACH VIOLATION.

TILL PLACEMENT NOTES:

-) ALL FILLS SHALL BE COMPACTED AS REQUIRED TO REDUCE EROSION, SLIPPAGE, SETTLEMENT, SUBSIDENCE OR OTHER RELATED PROBLEMS. FILL INTENDED TO SUPPORT BUILDINGS, STRUCTURES AND CONDUITS, ETC. SHALL BE COMPACTED IN ACCORDANCE WITH LOCAL REQUIREMENTS
- 2) ALL FILLS SHALL BE PLACED IN COMPACTED LAYERS NOT TO EXCEED 8 INCHES IN THICKNESS.
- 3) FILL MATERIALS SHALL BE FREE OF FROZEN PARTICLES, BRUSH, ROOTS, SOD, OR OTHER FOREIGN OR OBJECTIONABLE MATERIALS THAT WOULD INTERFERE WITH OR PREVENT CONSTRUCTION OF SATISFACTORY FILLS.
- 4) FROZEN MATERIALS OR SOFT, MUCKY, OR HIGHLY COMPRESSIBLE MATERIALS SHALL NOT BE INCORPORATED INTO FILLS.
- 5) FILL SHALL NOT BE PLACED ON SATURATED OR FROZEN SURFACES. 6) REFER TO GEOTECHNICAL REPORT FOR ADDITIONAL EARTHWORK RECOMMENDATION.

Fukui Architects Pc

205 Ross Street

Pittsburgh, Pennsylvania 15219

ph 412.281.6001 fx 412.281.6002 © 2023 Fukui Architects, Pc

> **ENGINEERS & SURVEYORS** 4314 OLD WILLIAM PENN HWY SUITE 101

> > MONROEVILLE, PA 15146 OFFICE: 724.325.1215

> > > general notes

- Any conflicts in the drawings or between new and existing construction shall be referred to the Architect.
- 2. Contractor shall verify all dimensions and existing conditions in the field and shall advise Fukui Architects, **Pc** of any discrepancies between, additions to, deletions from, or alterations to any and all conditions prior to proceeding with any phase of work. Do not scale
- **3.** All work shall be installed in accordance with applicable codes and regulations.
- 4. Contractor shall be responsible for the patching, repairing and preparations of all existing floor, wall, and ceiling surfaces as required to receive scheduled finishes.
- 5. All items shown on drawings are finished construction assemblies. Contractor shall provide and install all material required for finished assemblies. **6.** All reports, plans, specifications, computer files, field
- data, notices, and other documents and instruments prepared by the Architect as instruments of service shall remain the property of the Architect. The Architect shall retain all common law statutory, and other reserved rights, including the copyright thereto.

revisions

<u>project title</u>

Owner:

HACP 200 Ross Street

Pittsburgh,PA,15219

Client:

Allies & Ross Management and Development Corporation (ARMDC) 200 Ross Street

Project Location:

CONTROL NOTES

Pittsburgh, PA 15219


Northview Heights Midrise 246 Penfort Street Pittsburgh, PA 15214

EROSION AND SEDIMENTATION

As Noted December 3rd, 2023

Sheet No.

MAINTENANCE OF PERMANENT CONTROLS:

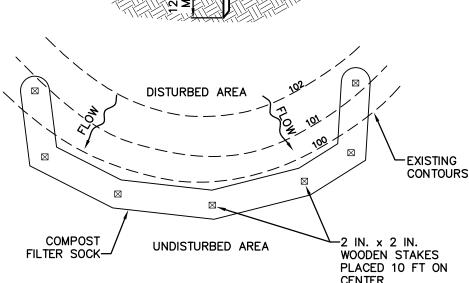

SOCK FABRIC SHALL MEET STANDARDS OF TABLE 4.1 OF THE PA DEP EROSION CONTROL MANUAL. COMPOST SHALL MEET THE STANDARDS OF TABLE 4.2 OF THE PA DEP EROSION

COMPOST FILTER SOCK SHALL BE PLACED AT EXISTING LEVEL GRADE. BOTH ENDS OF THE BARRIER SHALL BE EXTENDED AT LEAST 8 FEET UP SLOPE AT 45 DEGREES TO THE MAIN BARRIER ALIGNMENT. MAXIMUM SLOPE LENGTH ABOVE ANY BARRIER SHALL NOT EXCEED THAT SPECIFIED FOR THE SIZE OF THE SOCK AND THE SLOPE OF ITS TRIBUTARY AREA. TRAFFIC SHALL NOT BE PERMITTED TO CROSS COMPOST FILTER SOCKS.

ACCUMULATED SEDIMENT SHALL BE REMOVED WHEN IT REACHES 1/2 THE ABOVE GROUND HEIGHT OF THE BARRIER AND DISPOSED IN THE MANNER DESCRIBED ELSEWHERE IN THE PLAN. COMPOST FILTER SOCKS SHALL BE INSPECTED WEEKLY AND AFTER EACH RUNOFF EVENT. DAMAGED SOCKS SHALL BE REPAIRED ACCORDING TO MANUFACTURER'S SPECIFICATIONS OR REPLACED WITHIN 24 HOURS OF INSPECTION.

BIODEGRADABLE COMPOST FILTER SOCKS SHALL BE REPLACED AFTER 6 MONTHS; PHOTODEGRADABLE SOCKS AFTER 1 YEAR. POLYPROPYLENE SOCKS SHALL BE REPLACED ACCORDING TO MANUFACTURER'S RECOMMENDATIONS.

UPON STABILIZATION OF THE AREA TRIBUTARY TO THE SOCK, STAKES SHALL BE REMOVED. THE SOCK MAY BE LEFT IN PLACE AND VEGETATED OR REMOVED. IN THE LATTER CASE, THE MESH SHALL BE CUT OPEN AND THE MULCH SPREAD AS A SOIL SUPPLEMENT.

STANDARD CONSTRUCTION DETAIL #4-1

COMPOST FILTER SOCK

NOT TO SCALE

1. BEFORE COVERING, MAKE SURE GRATE AND SURROUNDING AREA ARE FREE OF ANY DEBRIS OR GRIT SO MAGNETIC BOTTOM CAN FULLY CONTACT

INSTRUCTIONS

- 2. LAY IFM OVER GRADE. SLIGHTLY ADJUST TO FIND SNUGGEST CONTACT OF MAGNETIC BOTTOM.
- 3. REMOVE AT LEAST ONE RED OVERFLOW PLUG IF GRATE IS AT LOW POINT OF STREET. IN THE EVENT OF FLOODING, PULL THE SECOND PLUG TO DE-WATER THE STREET.
- 4. THOROUGHLY CLEAN OFF SEDIMENT, LEAVES, AND OTHER DEBRIS AFTER EVERY RAIN EVENT.
- 5. ONCE FULL OF SEDIMENT, IFM SHOULD BE SWAPPED OUT FOR CLEANING USING A GARDEN HOSE OR POWER WASHER.
- 6. IF UNIT IS RUN OVER AFTER AND BEGINNING TO COMPRESS IT SHOULD BE DISCARDED.
- 7. IN SNOWY REGIONS IFM MAY BE SCRAPED OFF BY PLOW TRUCKS - USE PRODUCT ACCORDINGLY.
- 8. FILTERING FIBER IS COMPOSTABLE COCONUT COIR; . MAGNETICS ARE RUBBER WITH FERROUS OXIDE.
- 9. CALL MKB COMPANY AT (888) 587-0777 TO FIND

DIAMOND SOCK INLET FILTER MAT (TYPE-M 2x4 INLET) EDGING FOR INCREASED -HYDRAULIC FLOW OVERFLOW PLUGS -WEDGE OR SQUARE CURB -

AND INLET GRATE SYSTEM

TYPICAL 27x51 STEEL FRAME

THE REGIONAL DISTRIBUTÒR IN YOUR AREA. TOP HOLES AND SERRATED **GUTTER LINE**


INLET FILTER PROTECTION NOT TO SCALE

-MAXIMUM DEPTH OF CONCRETE WASHOUT WATER IS 50% OF -2"x2"x36" WOODEN FILTER RING HEIGHT STAKES PLACED 24" DIAMETER COMPOST 5' O.C. FILTER SOCK

NOTES:

COMPOST FILTER SOCK-

1. INSTALL ON FLAT GRADE FOR OPTIMUM PERFORMANCE 2. 18" DIAMETER FILTER SOCK MAY BE STACKED ONTO DOUBLE 24" DIAMETER SOCKS IN PYRAMIDAL

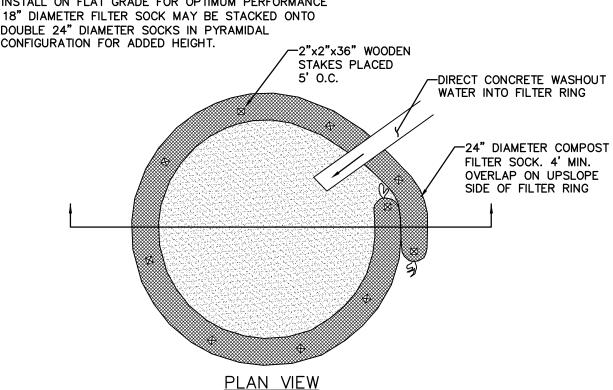

SECTION VIEW

A SUITABLE IMPERVIOUS GEOMEMBRANE SHALL BE PLACED AT THE LOCATION OF THE WASHOUT PRIOR TO INSTALLING THE SOCKS. ADAPTED FROM FILTREXX

CONCRETE WASHOUT DETAIL NOT TO SCALE


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Fukui Architects Pc

205 Ross Street




general notes

- Any conflicts in the drawings or between new and existing construction shall be referred to the Architect.
- 2. Contractor shall verify all dimensions and existing conditions in the field and shall advise Fukui Architects, **Pc** of any discrepancies between, additions to, deletions from, or alterations to any and all conditions prior to proceeding with any phase of work. Do not scale
- 3. All work shall be installed in accordance with applicable codes and regulations.
- **4.** Contractor shall be responsible for the patching, repairing and preparations of all existing floor, wall, and ceiling surfaces as required to receive scheduled finishes.
- 5. All items shown on drawings are finished construction assemblies. Contractor shall provide and install all material required for finished assemblies.
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including the copyright thereto. revisions
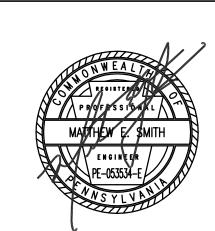
<u>project title</u>

-MOUNTABLE BERM (6 IN. MIN.)* EXISTING ROADWAY GEOTEXTILE-`PIPE AS NECESSARY MIN 8" AASHTO #1 GROUND

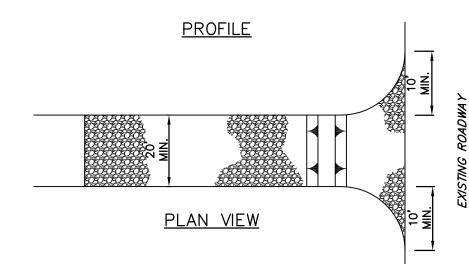

* MOUNTABLE BERM USED TO PROVIDE PROPER COVER FOR PIPE

SHALL BE SIZED APPROPRIATELY FOR SIZE OF DITCH BEING CROSSED.

REMOVE TOPSOIL PRIOR TO INSTALLATION OF ROCK CONSTRUCTION ENTRANCE. EXTEND ROCK OVER FULL WIDTH OF ENTRANCE.

RUNOFF SHALL BE DIVERTED FROM ROADWAY TO A SUITABLE SEDIMENT REMOVAL BMP PRIOR TO ENTERING ROCK CONSTRUCTION ENTRANCE. MOUNTABLE BERM SHALL BE INSTALLED WHEREVER OPTIONAL CULVERT PIPE IS USED AND PROPER PIPE COVER AS SPECIFIED BY MANUFACTURER IS NOT OTHERWISE PROVIDED. PIPE

MAINTENANCE: ROCK CONSTRUCTION ENTRANCE THICKNESS SHALL BE CONSTANTLY MAINTAINED TO THE SPECIFIED DIMENSIONS BY ADDING ROCK. A STOCKPILE SHALL BE MAINTAINED ON SITE FOR THIS PURPOSE, ALL SEDIMENT DEPOSITED ON PAVED ROADWAYS SHALL BE REMOVED AND RETURNED TO THE CONSTRUCTION SITE IMMEDIATELY. IF EXCESSIVE AMOUNTS OF SEDIMENT ARE BEING DEPOSITED ON ROADWAY, EXTEND LENGTH OF ROCK CONSTRUCTION ENTRANCE BY 50 FOOT INCREMENTS UNTIL CONDITION IS ALLEVIATED OR INSTALL WASH RACK. WASHING THE ROADWAY OR SWEEPING THE DEPOSITS INTO ROADWAY DITCHES, SEWERS, CULVERTS, OR OTHER DRAINAGE COURSES IS NOT ACCEPTABLE.

STANDARD CONSTRUCTION DETAIL #3-1

ROCK CONSTRUCTION ENTRANCE

NOT TO SCALE

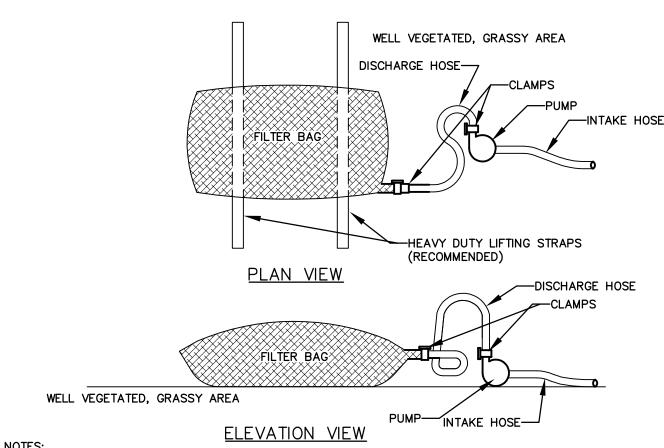


TABLE 4.1

Compost Sock Fabric Minimum Specifications

5 mil HDPE | 5 mil HDPE

degradable

6 months

Sock fabrics composed of burlap may be used on projects lasting 6 months or less.

TABLE 4.2

Compost Standards

Material Type

Sock Diameters

Strength

Ultraviolet

Original

Strength

(ASTM G-155)

Minimum

Functional

Filtrexx & JMD

COMPOST STANDARDS

NOT TO SCALE

NOT TO SCALE

FOLLOWING STANDARDS:

Longevity

Stability %

mil HDPE

Characteristics | degradable | degradable

23% at

1000 hr

months

Inner Containment Netting

Outer Filtration Mesh

Organic Matter Content

Organic Portion

Moisture Content

Particle Size

Soluble Salt Concentration

23% at

1000 hr

9 months

COMPOST SOCK FABRIC MINIMUM SPECIFICATIONS

| Multi-Filament | Multi-Filament

(MFPP)

degradable

44 psi

100% at

HDPE biaxial net
Continuously wound

Fusion-welded junctures /4" x 3/4" Max. aperture size

Composite Polypropylene Fabric

(Woven layer and non-woven fleece

mechanically fused via needle punch)

3/16" Max. aperture size

25% - 100% (dry weight basis)

Fibrous and elongated

5.5 - 8.5

30% - 60%

5.0 dS/m (mmhos/cm) Maximum

30% - 50% pass through 3/8" sieve

1000 hr.

Polypropylene | Polypropylene

(HDMFPP)

degradable

1/8"

202 psi

100% at

2 years

1000 hr.

LOW VOLUME FILTER BAGS SHALL BE MADE FROM NON-WOVEN GEOTEXTILE MATERIAL SEWN WITH HIGH STRENGTH, DOUBLE STITCHED "J" TYPE SEAMS. THEY SHALL BE CAPABLE OF TRAPPING PARTICLES LARGER THAN 150 MICRONS. HIGH VOLUME FILTER BAGS SHALL BE MADE FROM WOVEN GEOTEXTILES THAT MEET THE

PROPERTY	TEST METHOD	MINIMUM STANDARD
AVG. WIDE WIDTH STRENGTH	ASTM D-4884	60 LB/IN
GRAB TENSILE	ASTM D-4632	205 LB
PUNCTURE	ASTM D-4833	110 LB
MULLEN BURST	ASTM D-3786	350 PSI
UV RESISTANCE	ASTM D-4355	70%
AOS % RETAINED	ASTM D-4751	80 SIEVE

A SUITABLE MEANS OF ACCESSING THE BAG WITH MACHINERY REQUIRED FOR DISPOSAL PURPOSES SHALL BE PROVIDED. FILTER BAGS SHALL BE REPLACED WHEN THEY BECOME 1/2 FULL OF SEDIMENT. SPARE BAGS SHALL BE KEPT AVAILABLE FOR REPLACEMENT OF THOSE THAT HAVE FAILED OR ARE FILLED. BAGS SHALL BE PLACED ON STRAPS TO FACILITATE REMOVAL UNLESS BAGS COME WITH LIFTING STRAPS ALREADY ATTACHED.


BAGS SHALL BE LOCATED IN WELL-VEGETATED (GRASSY) AREA, AND DISCHARGE ONTO STABLE, EROSION RESISTANT AREAS. WHERE THIS IS NOT POSSIBLE, A GEÓTEXTILE UNDERLAYMENT AND FLOW PATH SHALL BE PROVIDED. BAGS MAY BE PLACED ON FILTER STONE TO INCREASE DISCHARGE CAPACITY. BAGS SHALL NOT BE PLACED ON SLOPES GREATER THAN 5%. FOR SLOPES EXCEEDING 5%, CLEAN ROCK OR OTHER NON-ERODIBLE AND NON-POLLUTING MATERIAL MAY BE PLACED UNDER THE BAG TO REDUCE SLOPE STEEPNESS.

FILTER SOCK SHALL BE INSTALLED BELOW BAGS LOCATED IN HQ OR EV WATERSHEDS, WITHIN 50 FEET OF ANY RECEIVING SURFACE WATER OR WHERE GRASSY AREA IS NOT AVAILABLE. THE PUMP DISCHARGE HOSE SHALL BE INSERTED INTO THE BAGS IN THE MANNER SPECIFIED BY THE MANUFACTURER AND SECURELY CLAMPED. A PIECE OF PVC PIPE IS RECOMMENDED FOR THIS PURPOSE.

NO DOWNSLOPE SEDIMENT BARRIER IS REQUIRED FOR MOST INSTALLATIONS. COMPOST BERM OR COMPOST

THE PUMPING RATE SHALL BE NO GREATER THAN 750 GPM OR 1/2 THE MAXIMUM SPECIFIED BY THE MANUFACTURER, WHICHEVER IS LESS. PUMP INTAKES SHALL BE FLOATING AND SCREENED. FILTER BAGS SHALL BE INSPECTED DAILY. IF ANY PROBLEM IS DETECTED, PUMPING SHALL CEASE IMMEDIATELY AND NOT RESUME UNTIL THE PROBLEM IS CORRECTED.

PUMPED WATER FILTER BAG

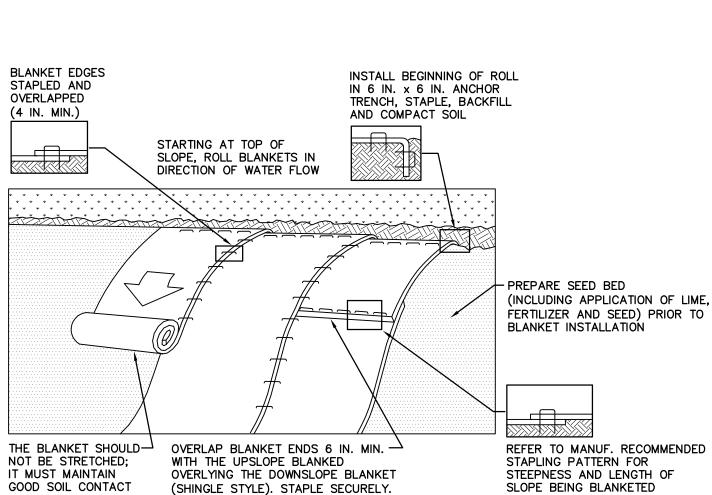

SEED AND SOIL AMENDMENTS SHALL BE APPLIED ACCORDING TO THE RATES IN THE PLAN DRAWINGS PRIOR TO INSTALLING THE BLANKET.

PROVIDE ANCHOR TRENCH AT TOE OF SLOPE IN SIMILAR FASHION AS AT TOP OF SLOPE.


SLOPE SURFACE SHALL BE FREE OF ROCKS, CLODS, STICKS, AND GRASS. BLANKET SHALL HAVE GOOD CONTINUOUS CONTACT WITH UNDERLYING SOIL THROUGHOUT ENTIRE LENGTH. LAY

BLANKET LOOSELY AND STAKE OR STAPLE TO MAINTAIN DIRECT CONTACT WITH SOIL. DO NOT STRETCH THE BLANKET SHALL BE STAPLED IN ACCORDANCE WITH THE MANUFACTURER'S RECOMMENDATIONS.

BLANKETED AREAS SHALL BE INSPECTED WEEKLY AND AFTER EACH RUNOFF EVENT UNTIL PERENNIAL VEGETATION IS ESTABLISHED TO A MINIMUM UNIFORM 70% COVERAGE THROUGHOUT THE BLANKETED AREA.

DAMAGED OR DISPLACED BLANKETS SHALL BE RESTORED OR REPLACED WITHIN 4 CALENDAR DAYS. STANDARD CONSTRUCTION DETAIL #11-1

EROSION CONTROL BLANKET INSTALLATION

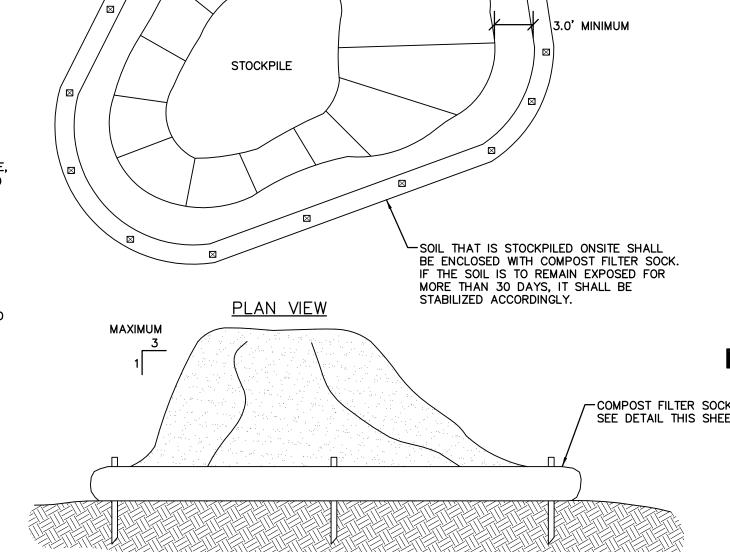

STOCKPILES SHALL BE LOCATED ONSITE PER THE APPROVED PLAN.

SECTION VIEW SOIL STOCKPILE AREA NOT TO SCALE

200 Ross Street Pittsburgh,PA,15219 **Client:** Allies & Ross Management and Development Corporation (ARMDC) 200 Ross Street Pittsburgh, PA 15219 **Project Location:** Northview Heights Midrise 246 Penfort Street

Owner:

HACP


EROSION AND SEDIMENTATION CONTROL DETAILS 1 OF 2

Pittsburgh, PA 15214

Sheet No. As Noted

December 3rd, 2023

C651 Project #2040

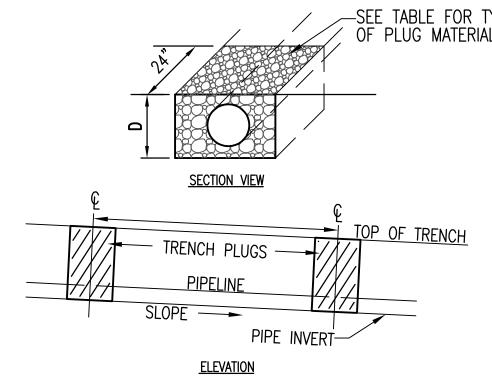


REQUIRED SPACING (L) AND MA	TERIAL FOR TRENCH PLUGS
TRENCH SLOPE (%)	L (FEET)	PLUG MATERIAL
0-5		NONE
5-15	500	EARTH FILLED SACKS **
15-25	300	EARTH FILLED SACKS **
25-35	200	EARTH FILLED SACKS **
35-100	100	EARTH FILLED SACKS **
OVER 100	50	CEMENT FILLED BAGS (WETTED) OR MORTARED STONE
** TOPSOIL MAY NOT	BE USED	TO FILL SACKS.

1. PIPELINES WITH JOINTS THAT ALLOW A MANUFACTURED LENGTH OF PIPE TO BE PLACED IN THE TRENCH WITH THE PIPE JOINT ASSEMBLED/MADE IN THE TRENCH REQUIRE AN OPEN PIPELINE TRENCH THAT IS ONLY SLIGHTLY LONGER THAN THE LENGTH OF PIPE BEING INSTALLED. THE TOTAL LENGTH OF EXCAVATED TRENCH OPEN AT ANY ONE TIME SHOULD NOT BE GREATER THAN THE TOTAL LENGTH OF PIPELINE/UTILITY LINE THAT CAN BE PLACED IN THE TRENCH AND BACK-FILLED IN ONE WORKING DAY. NO MORE THAN 50 LINEAL FEET OF OPEN TRENCH SHOULD EXIST WHEN PIPELINE/UTILITY LINE INSTALLATION CEASES AT THE END OF THE WORKDAY. SOIL SUPPLEMENTS, SEED AND MULCH SHOULD BE APPLIED WITHIN SEVEN DAYS AFTER THE PIPELINE/UTILITY LINE IS INSTALLED.

2. WATER WHICH ACCUMULATES IN THE OPEN TRENCH IS TO BE COMPLETELY REMOVED BY PUMPING, WITH THE USE OF FILTER BAGS; BEFORE PIPE PLACEMENT AND/OR BACKFILLING BEGINS.

UTILITY EXCAVATION TRENCH PLUGS

NOT TO SCALE

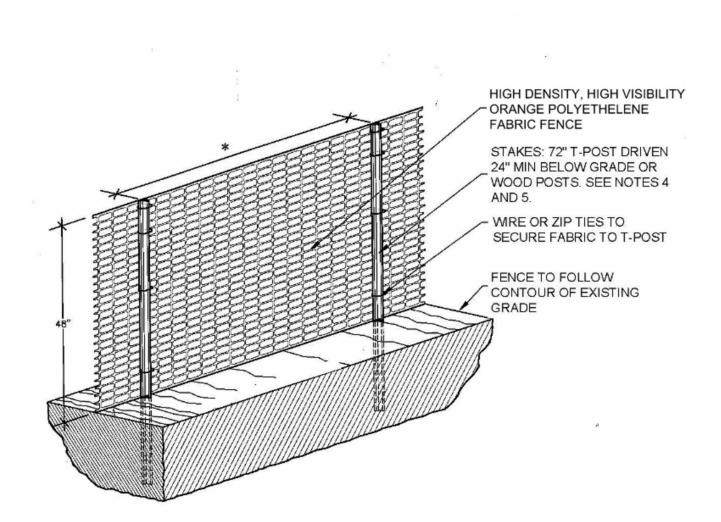

* 20' MAXIMUM SPACING


NOTES:

- PRESERVATION FENCE (AGENCY DISCRETION) SHALL BE USED IN LOCATIONS IDENTIFIED SOLEY BY THE ENGINEER AND IS NOT INTENDED FOR THE CONVENIENCE OF THE CONTRACTOR.
- PLACE FENCE OUTSIDE THE DRIP LINE OF TREES.
- FENCE FABRIC TO BE FASTENED SECURELY TO POSTS USING WIRE OR PLASTIC ZIP TIES. WHEN USING WOOD POSTS THE POSTS SHALL BE OF HARDWOOD WITH A WEDGE OR
- PENCIL TIP AT ONE END, 72" MIN. LENGTH, AND 2" X 2" NOMINAL CROSS SECTION. USE ONE 2" GALVANIZED WIRE STAPLE TO ATTACH FABRIC TO WOOD POSTS.
- 5. METAL T-POST SHALL HAVE A MINIMUM WEIGHT OF 0.85 LB/FT OF LENGTH.

ORANGE CONSTRUCTION FENCE

NOT TO SCALE



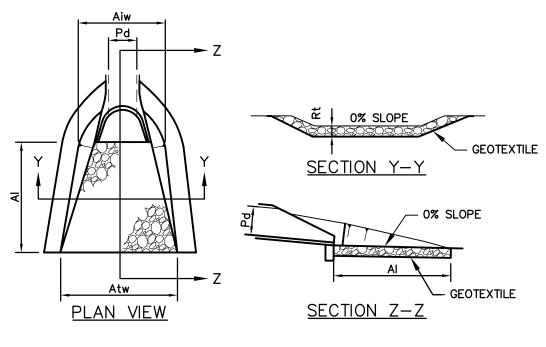

THICK. LENGTH WIDTH WIDTH
Rt Al Aiw Atw
(IN) (FT) (FT) (FT)

ALL APRONS SHALL BE CONSTRUCTED TO THE DIMENSIONS SHOWN. TERMINAL WIDTHS SHALL BE ADJUSTED AS NECESSARY TO MATCH RECEIVING CHANNELS. ALL APRONS SHALL BE INSPECTED AT LEAST WEEKLY AND AFTER EACH RUNOFF EVENT. DISPLACED RIPRAP WITHIN THE APRON SHALL BE REPLACED IMMEDIATELY. STANDARD CONSTRUCTION DETAIL #9-1

RIPRAP APRON AT PIPE OUTLET WITH FLARED END SECTION OR ENDWALL NOT TO SCALE

RIPRAP APRON AT PIPE OUTLET WITH FLARED END SECTION OR ENDWALL NOT TO SCALE


Fukui Architects Pc

205 Ross Street Pittsburgh, Pennsylvania 15219 ph 412.281.6001 fx 412.281.6002

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SUITE 101 MONROEVILLE, PA 15146 OFFICE: 724.325.1215



general notes
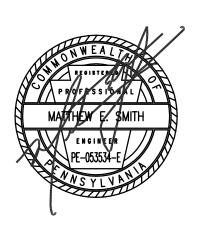
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- 2. Contractor shall verify all dimensions and existing conditions in the field and shall advise Fukui Architects, Pc of any discrepancies between, additions to, deletions from, or alterations to any and all conditions prior to proceeding with any phase of work. Do not scale
- 3. All work shall be installed in accordance with applicable codes and regulations.
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- 6. All reports, plans, specifications, computer files, field data, notices, and other documents and instruments prepared by the Architect as instruments of service shall remain the property of the Architect. The Architect shall retain all common law statutory, and other reserved rights, including the copyright thereto. revisions

project title

Owner:

HACP 200 Ross Street Pittsburgh,PA,15219

Client:

Allies & Ross Management and Development Corporation (ARMDC) 200 Ross Street Pittsburgh, PA 15219

Project Location:

Northview Heights Midrise 246 Penfort Street Pittsburgh, PA 15214

drawing title


EROSION AND SEDIMENTATION CONTROL DETAILS 2 OF 2


As Noted December 3rd, 2023


46 | 233 |


Sheet No.


C652 Project #2040

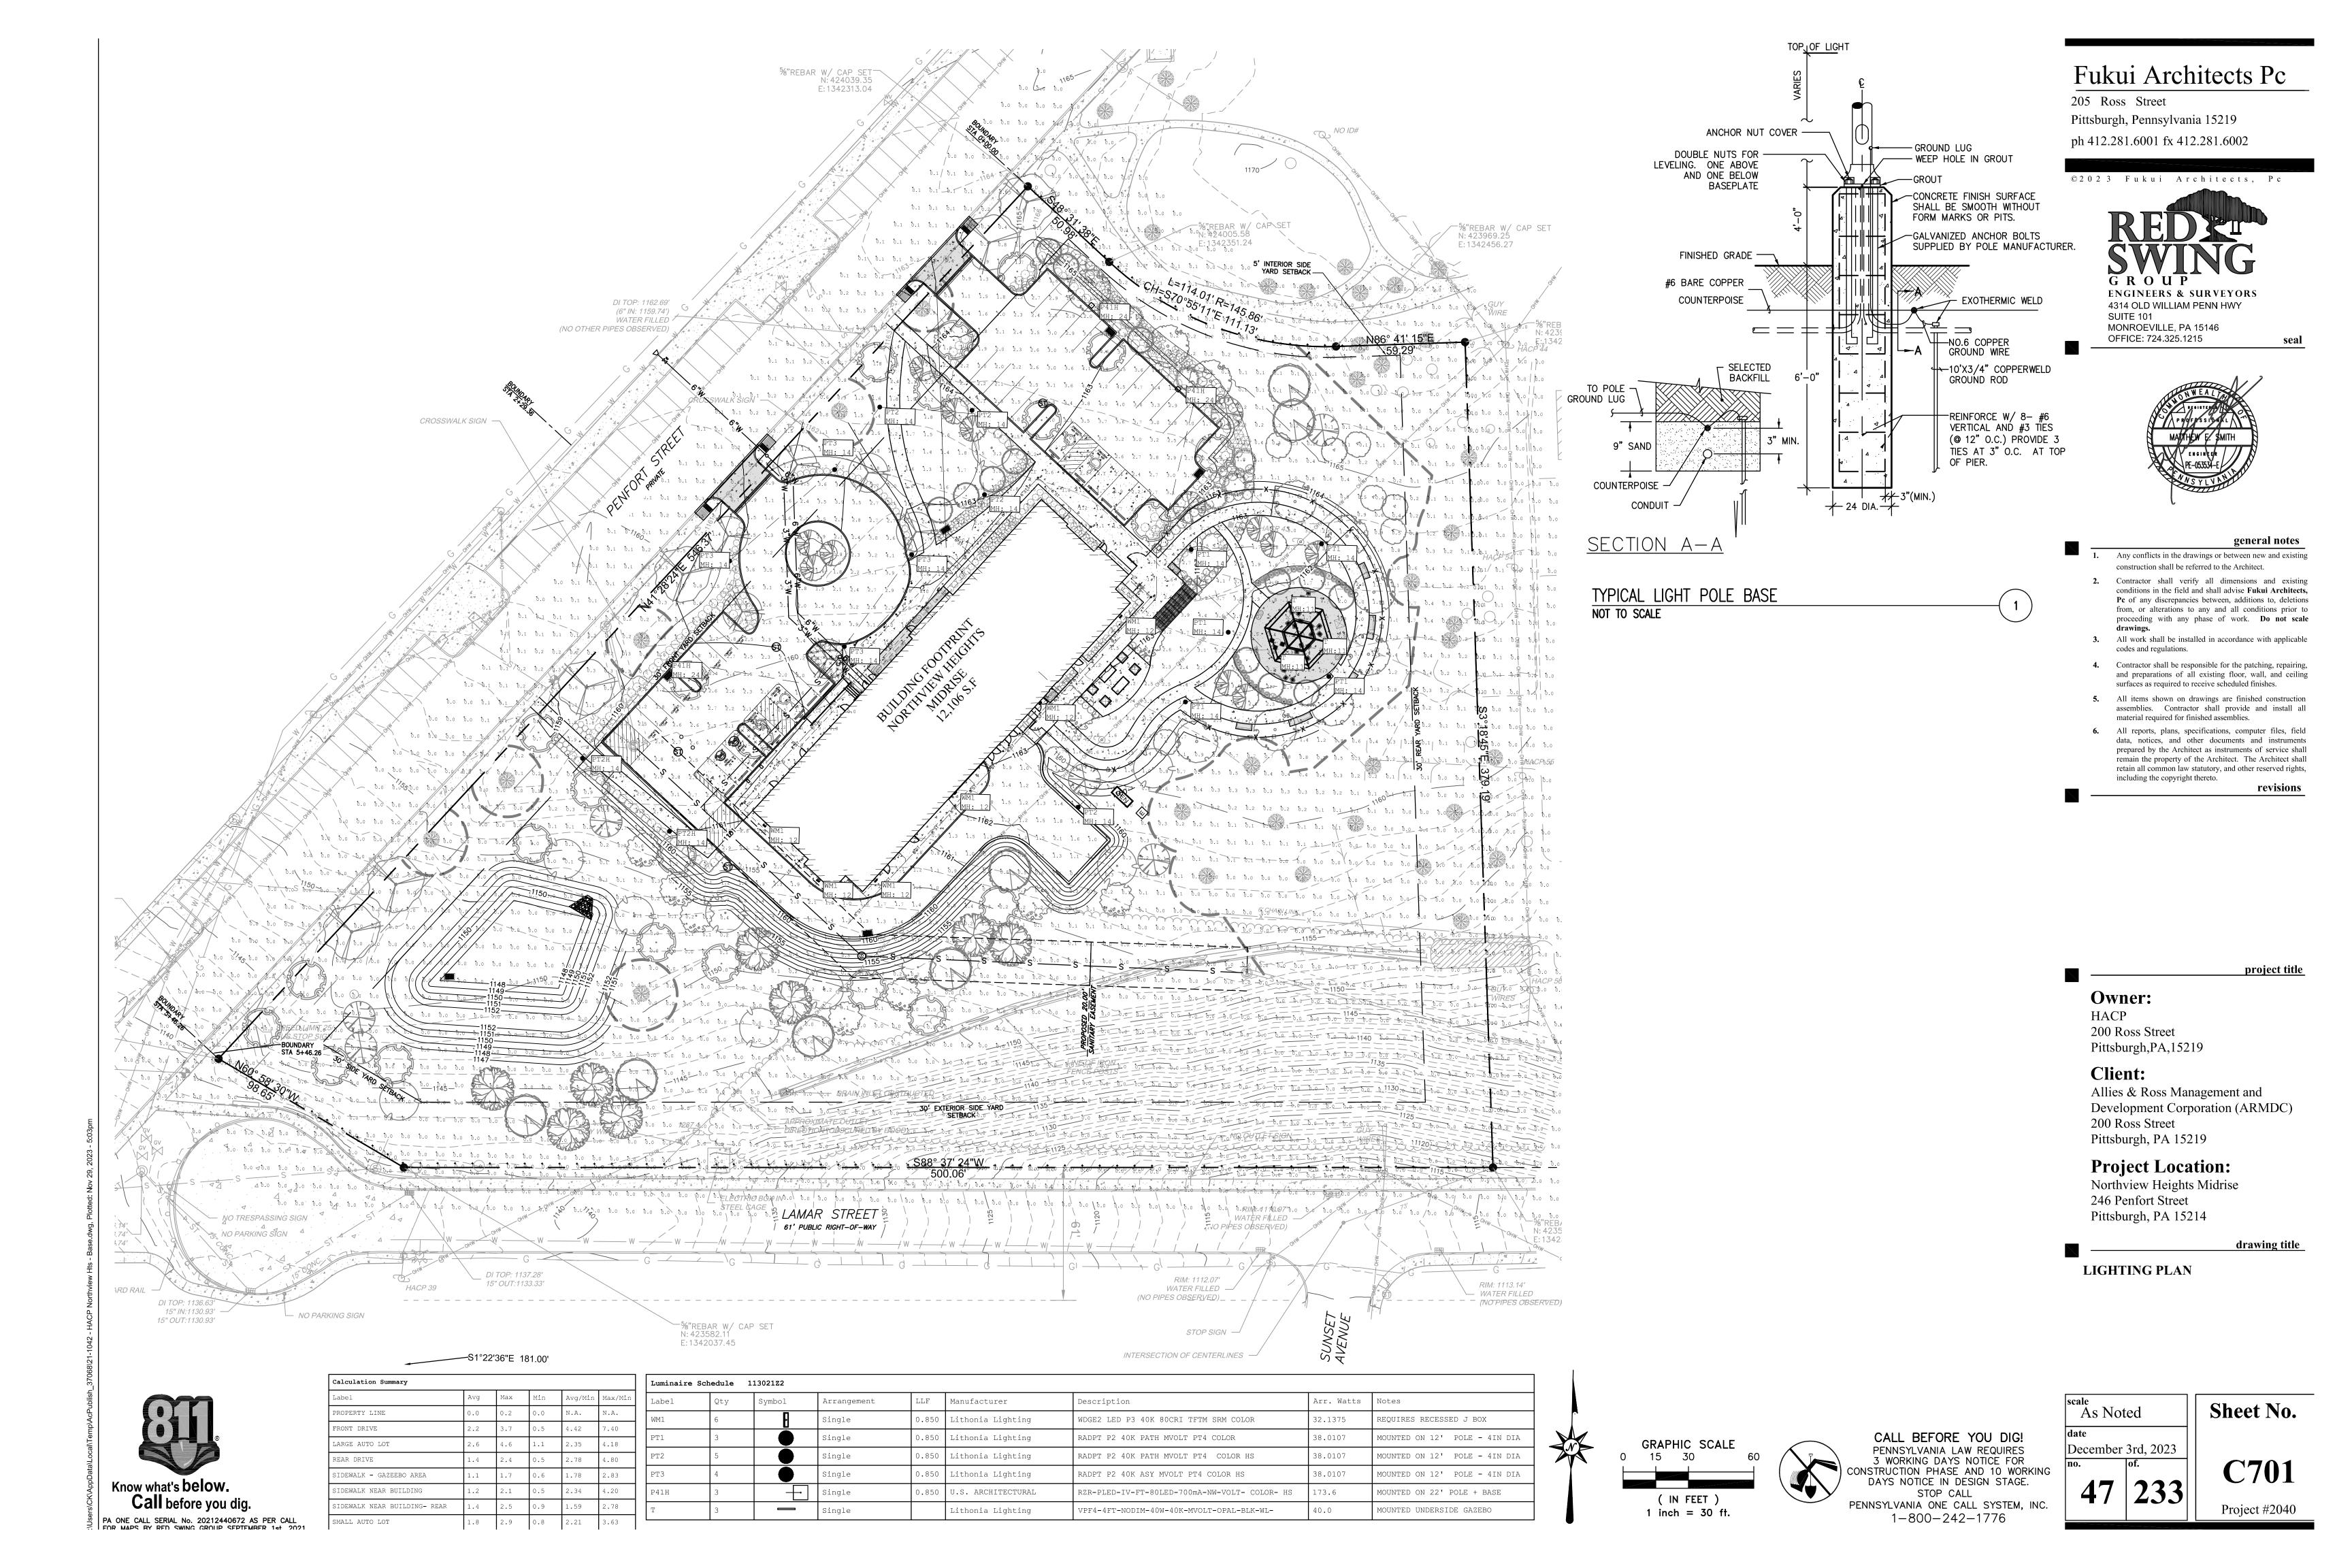

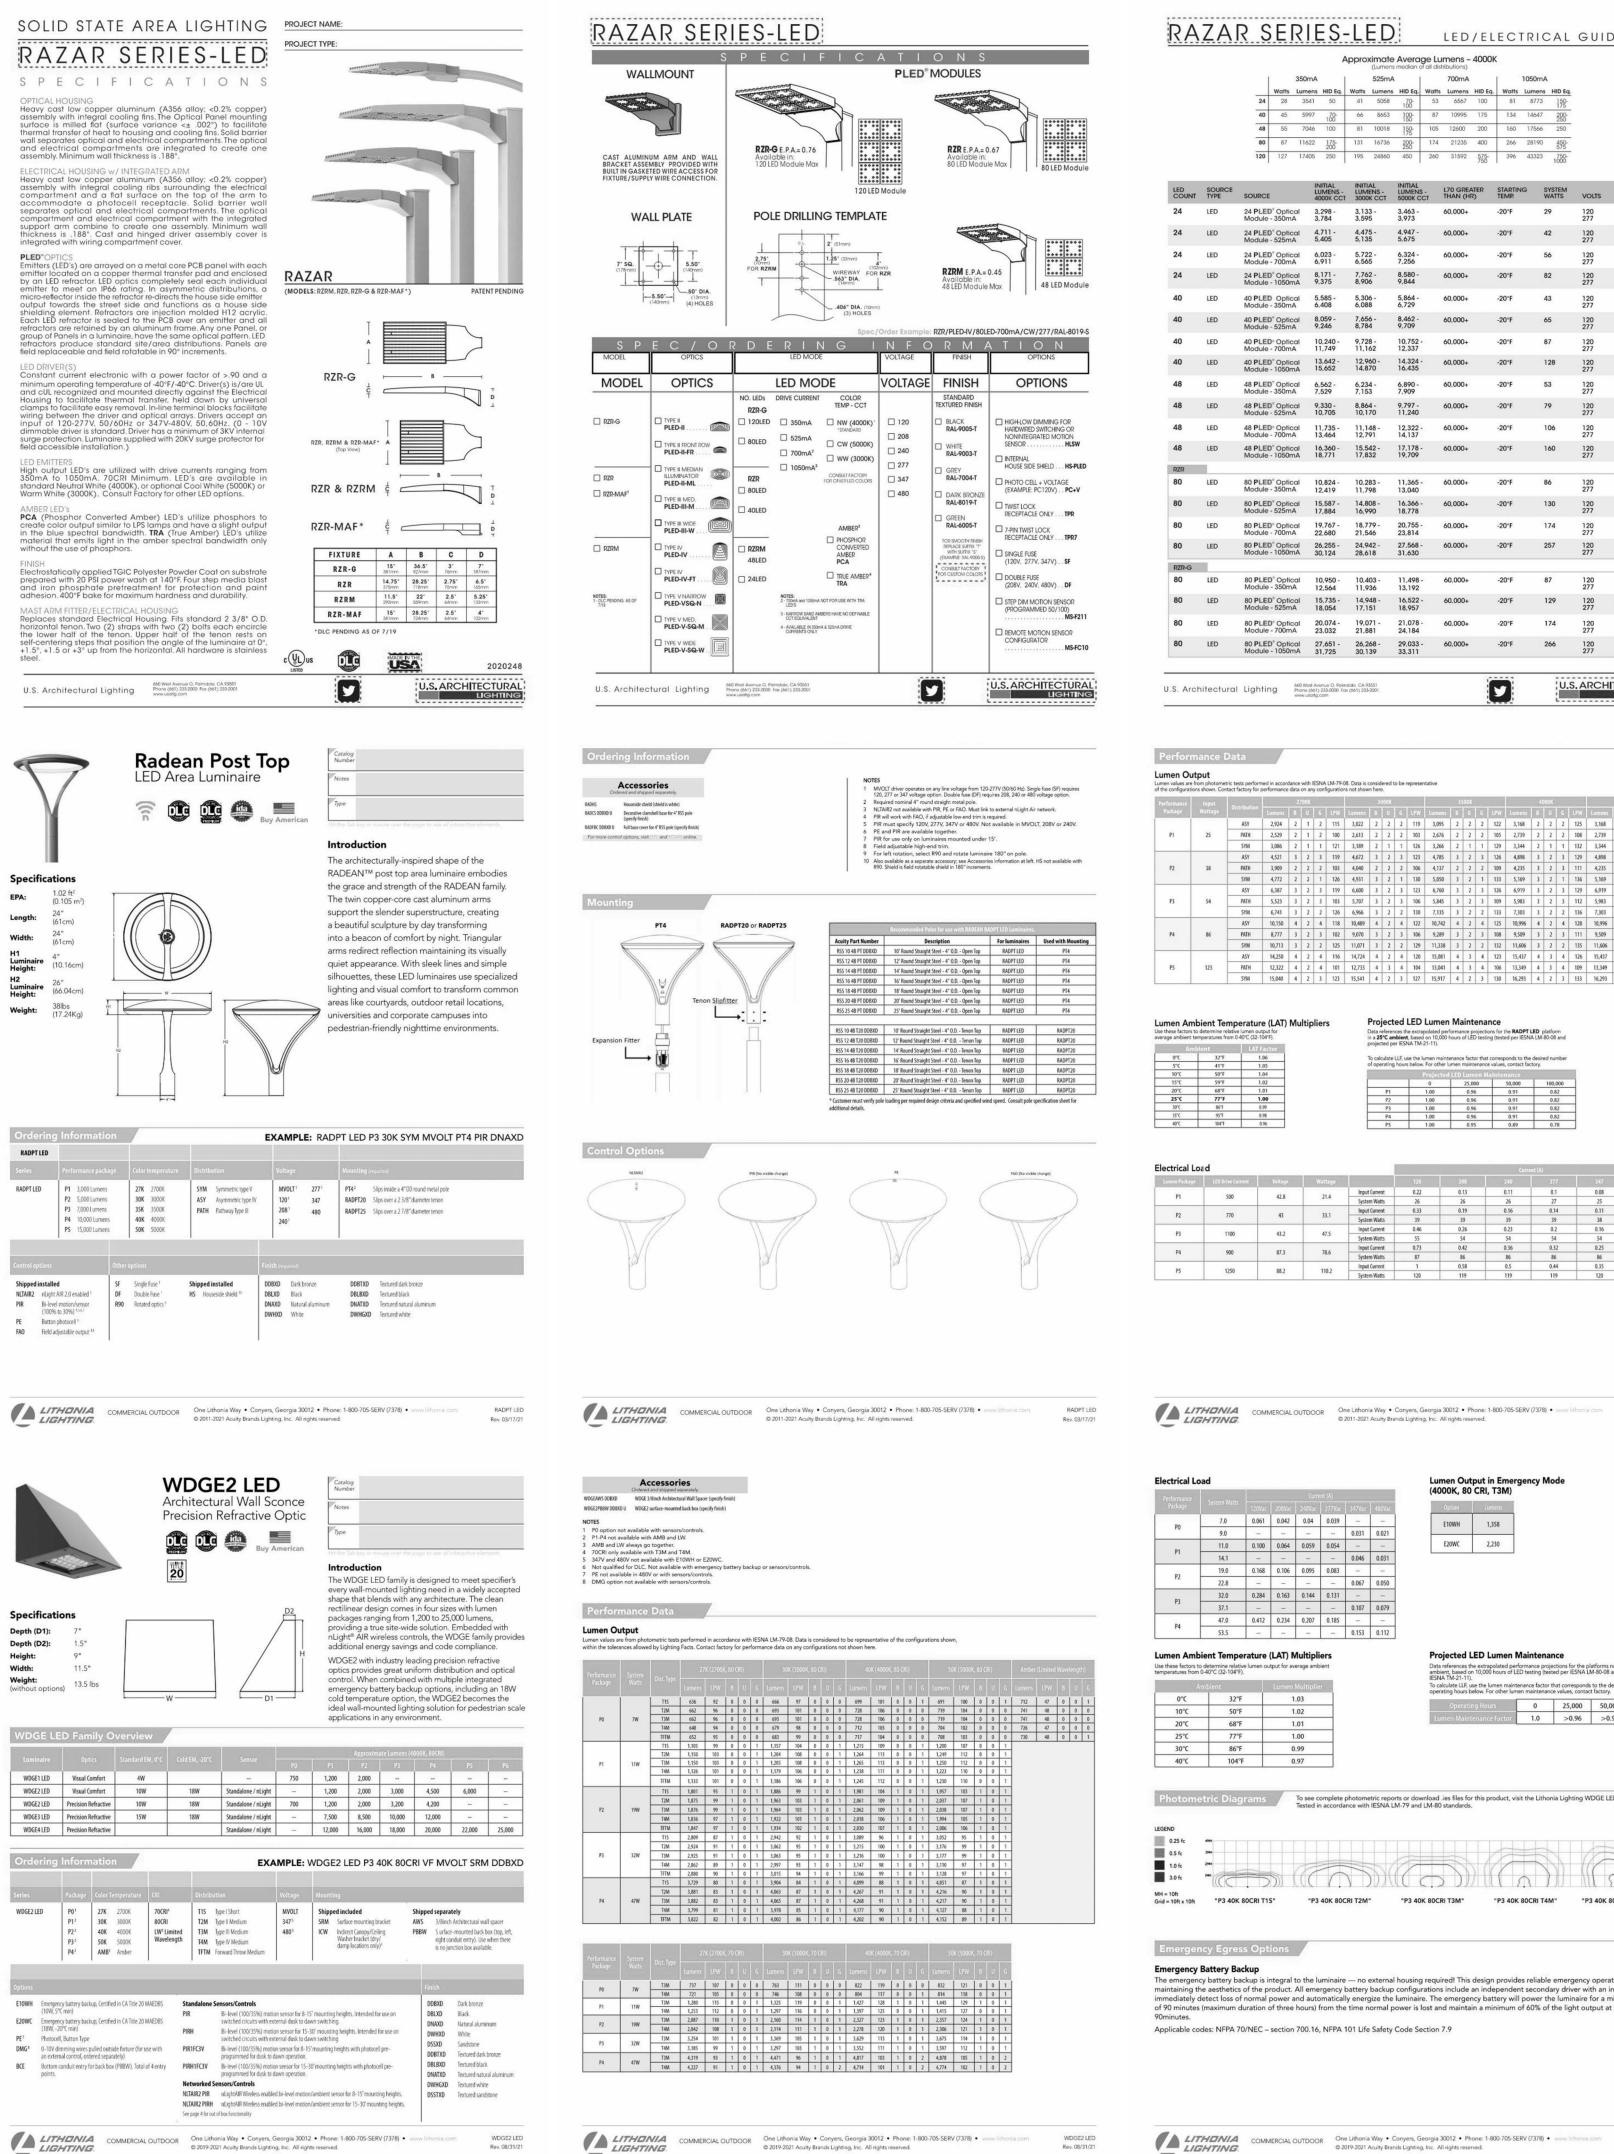

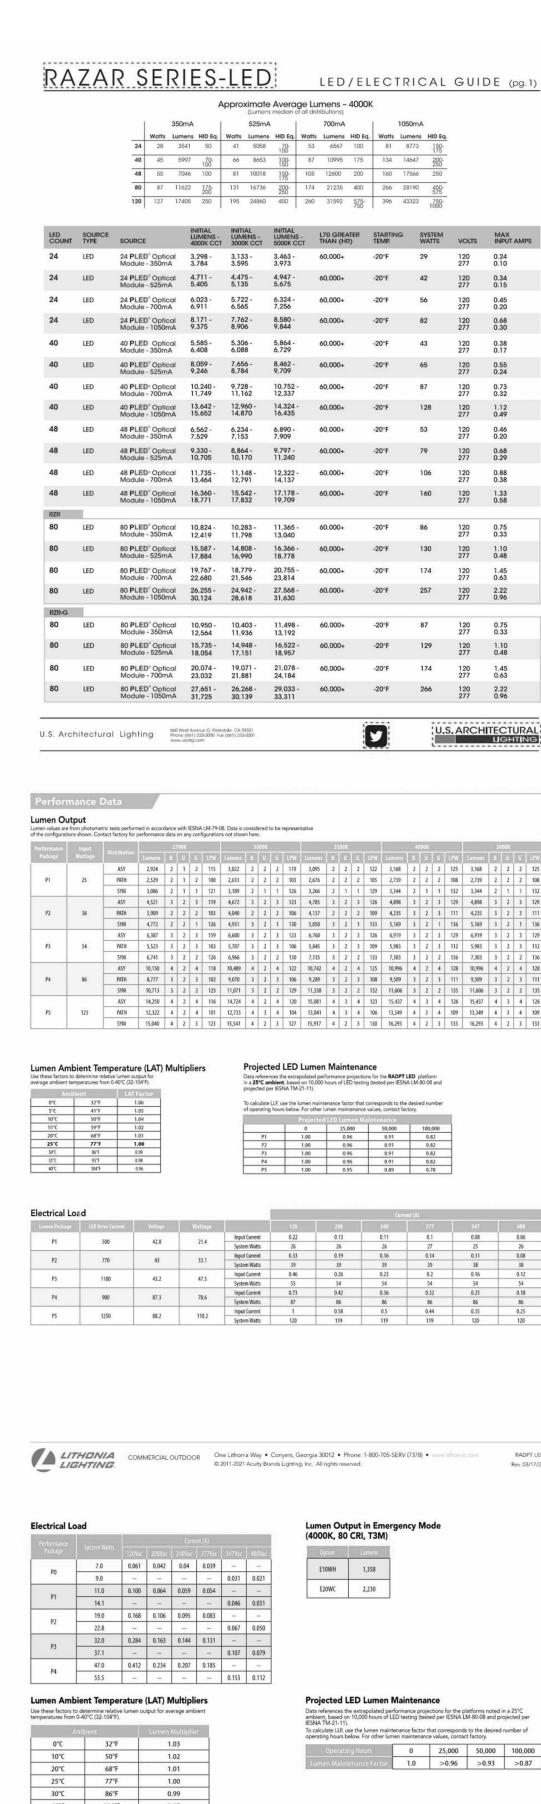

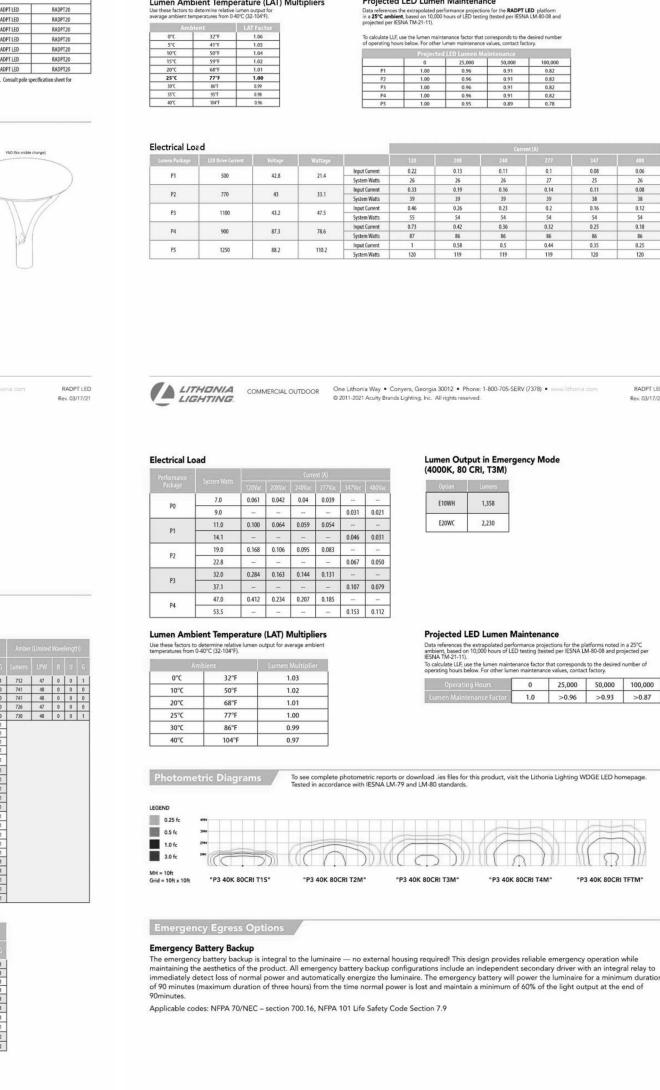

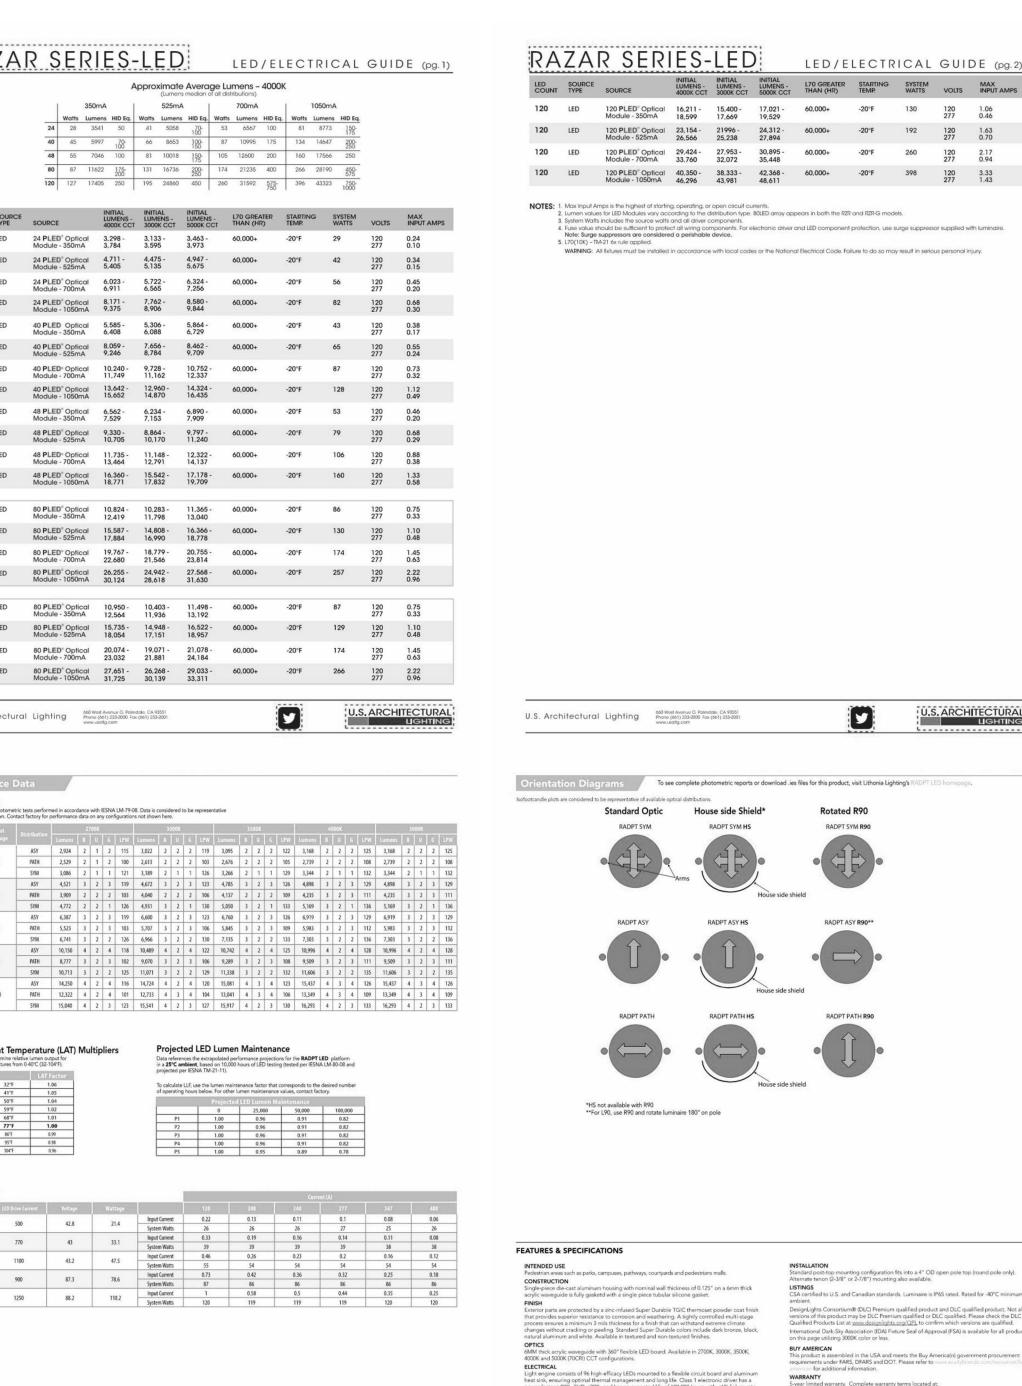





Motion/Ambient Sensor (PIR_, PIRH_) Motion/Ambeint sensor (Sensor Switch MSOD) is integrated into the the luminaire. The sensor provides both Motion and Daylight based dimming of the uminaire. For motion detection, the sensor utilizes 100% Digital Passive Infrared (PIR) technology that is tuned for walking size motion while p false tripping from the environment. The integrated photocell enables additional energy savings during daytime periods when there is sufficient dayligh


nounting heights between 8-15ft, while PIRH is optimized for 15-40ft mounting height.

Networked Control (NLTAIR2) nLight® AIR is a wireless lighting controls platform that allows for seamless integration of both indoor and outdoor luminaires. Five-tier security architecture, 900 MHz wireless communication and app (CLAIRITY™ Pro) based configurability combined together make nLight® AIR a secure, reliable

Optimize sensor coverage by either selecting PIR or PIRH option. PIR option comes with a sensor lens that is optimized to provide maximum coverage for

and easy to use platform.



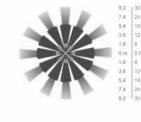

Motion/Ambient Sensor

H = 9" (Standalone controls)

1" (nLight AIR controls, 2" antenna will

AWS - 3/8inch Architectural Wall Spacer

CONSTRUCTION

The single-piece die-cast aluminum housing integrates secondary heat sinks to optimize thermal transfer from the internal light engine heat sinks and promote long life. The driver is mounted in direct contact with the casting for a low operating temperature and long life. The die-cast door frame is fully gasketed with a one-piece solid silicone gasket to keep out moisture and dust, providing an IP66 rating for the luminaire.


.ECTRICAL gpt engine consists of high-efficacy LEDs mounted to metal-core circuit boards to aximize heat dissipation and promote long life (up to L91/100,000 hours at 25°C). The ectronic driver has a power factor of >90%, THD <20%. Luminaire comes with built in

D = 0.38" H = 4.4"

W = 7.5 °

FEATURES & SPECIFICATIONS

be pointing down behind the sensor)

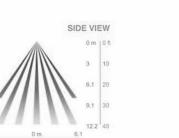

	TOP VI	EW
1111	6.1	20
	3	10
	0 m	O ft
	3	10
1111	6.1	20

	Dim Level High Level (when triggered					
PIR or PIRH	Motion - 3V (37% of full output) Photocell - 0V (turned off)	10V (100% output)	Enabled @ 5fc	5 min	5 min	Motion - 3 sec Photocell - 45 sec
PIR1FC3V, PIRH1FC3V Motion - 3V (37% of full output) Photocell - 0V (turned off)		10V (100% output)	Enabled @ 1fc	5 min	5 min	Motion - 3 sec Photocell - 45 sec
NLTAIR2 PIR, NLTAIR2 PIRH (out of box)	Motion - 3V (37% of full output) Photocell - 0V (turned off)	10V (100% output)	Enabled @ 5fc	7.5 min	5 min	Motion - 3 sec Photocell - 45 sec

LITHUNIA
COMMERCIAL OUTDOOR
One Lithonia Way • Conyers, Georgia 30012 • Phone: 1-800-705-SERV (7378) • www.lithonia.com
© 2019-2021 Acuity Brands Lighting, Inc. All rights reserved.

PBBW - Surface-Mounted Back Box

D = 1.75"

BUY AMERICAN

Use when there is no junction box available

Owner: HACP

200 Ross Street Pittsburgh,PA,15219

Client:

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Fukui Architects Pc

Pittsburgh, Pennsylvania 15219

ph 412.281.6001 fx 412.281.6002

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ENGINEERS & SURVEYORS

Any conflicts in the drawings or between new and existing

conditions in the field and shall advise Fukui Architects,

Pc of any discrepancies between, additions to, deletions

from, or alterations to any and all conditions prior to proceeding with any phase of work. Do not scale

and preparations of all existing floor, wall, and ceiling

assemblies. Contractor shall provide and install all

data, notices, and other documents and instruments

prepared by the Architect as instruments of service shall remain the property of the Architect. The Architect shall

retain all common law statutory, and other reserved rights,

project title

drawing title

construction shall be referred to the Architect.

2. Contractor shall verify all dimensions and existing

3. All work shall be installed in accordance with applicable

4. Contractor shall be responsible for the patching, repairing

surfaces as required to receive scheduled finishes.

5. All items shown on drawings are finished construction

6. All reports, plans, specifications, computer files, field

material required for finished assemblies.

including the copyright thereto.

codes and regulations.

4314 OLD WILLIAM PENN HWY

MONROEVILLE, PA 15146

OFFICE: 724.325.1215

SUITE 101

205 Ross Street

Project Location:


Northview Heights Midrise 246 Penfort Street Pittsburgh, PA 15214

LIGHTING DETAILS

Sheet No. As Noted December 3rd, 2023

C750

48 LITHDNIA COMMERCIAL OUTDOOR
One Lithonia Way • Conyers, Georgia 30012 • Phone: 1-800-705-SERV (7378) • www.lithonia.com

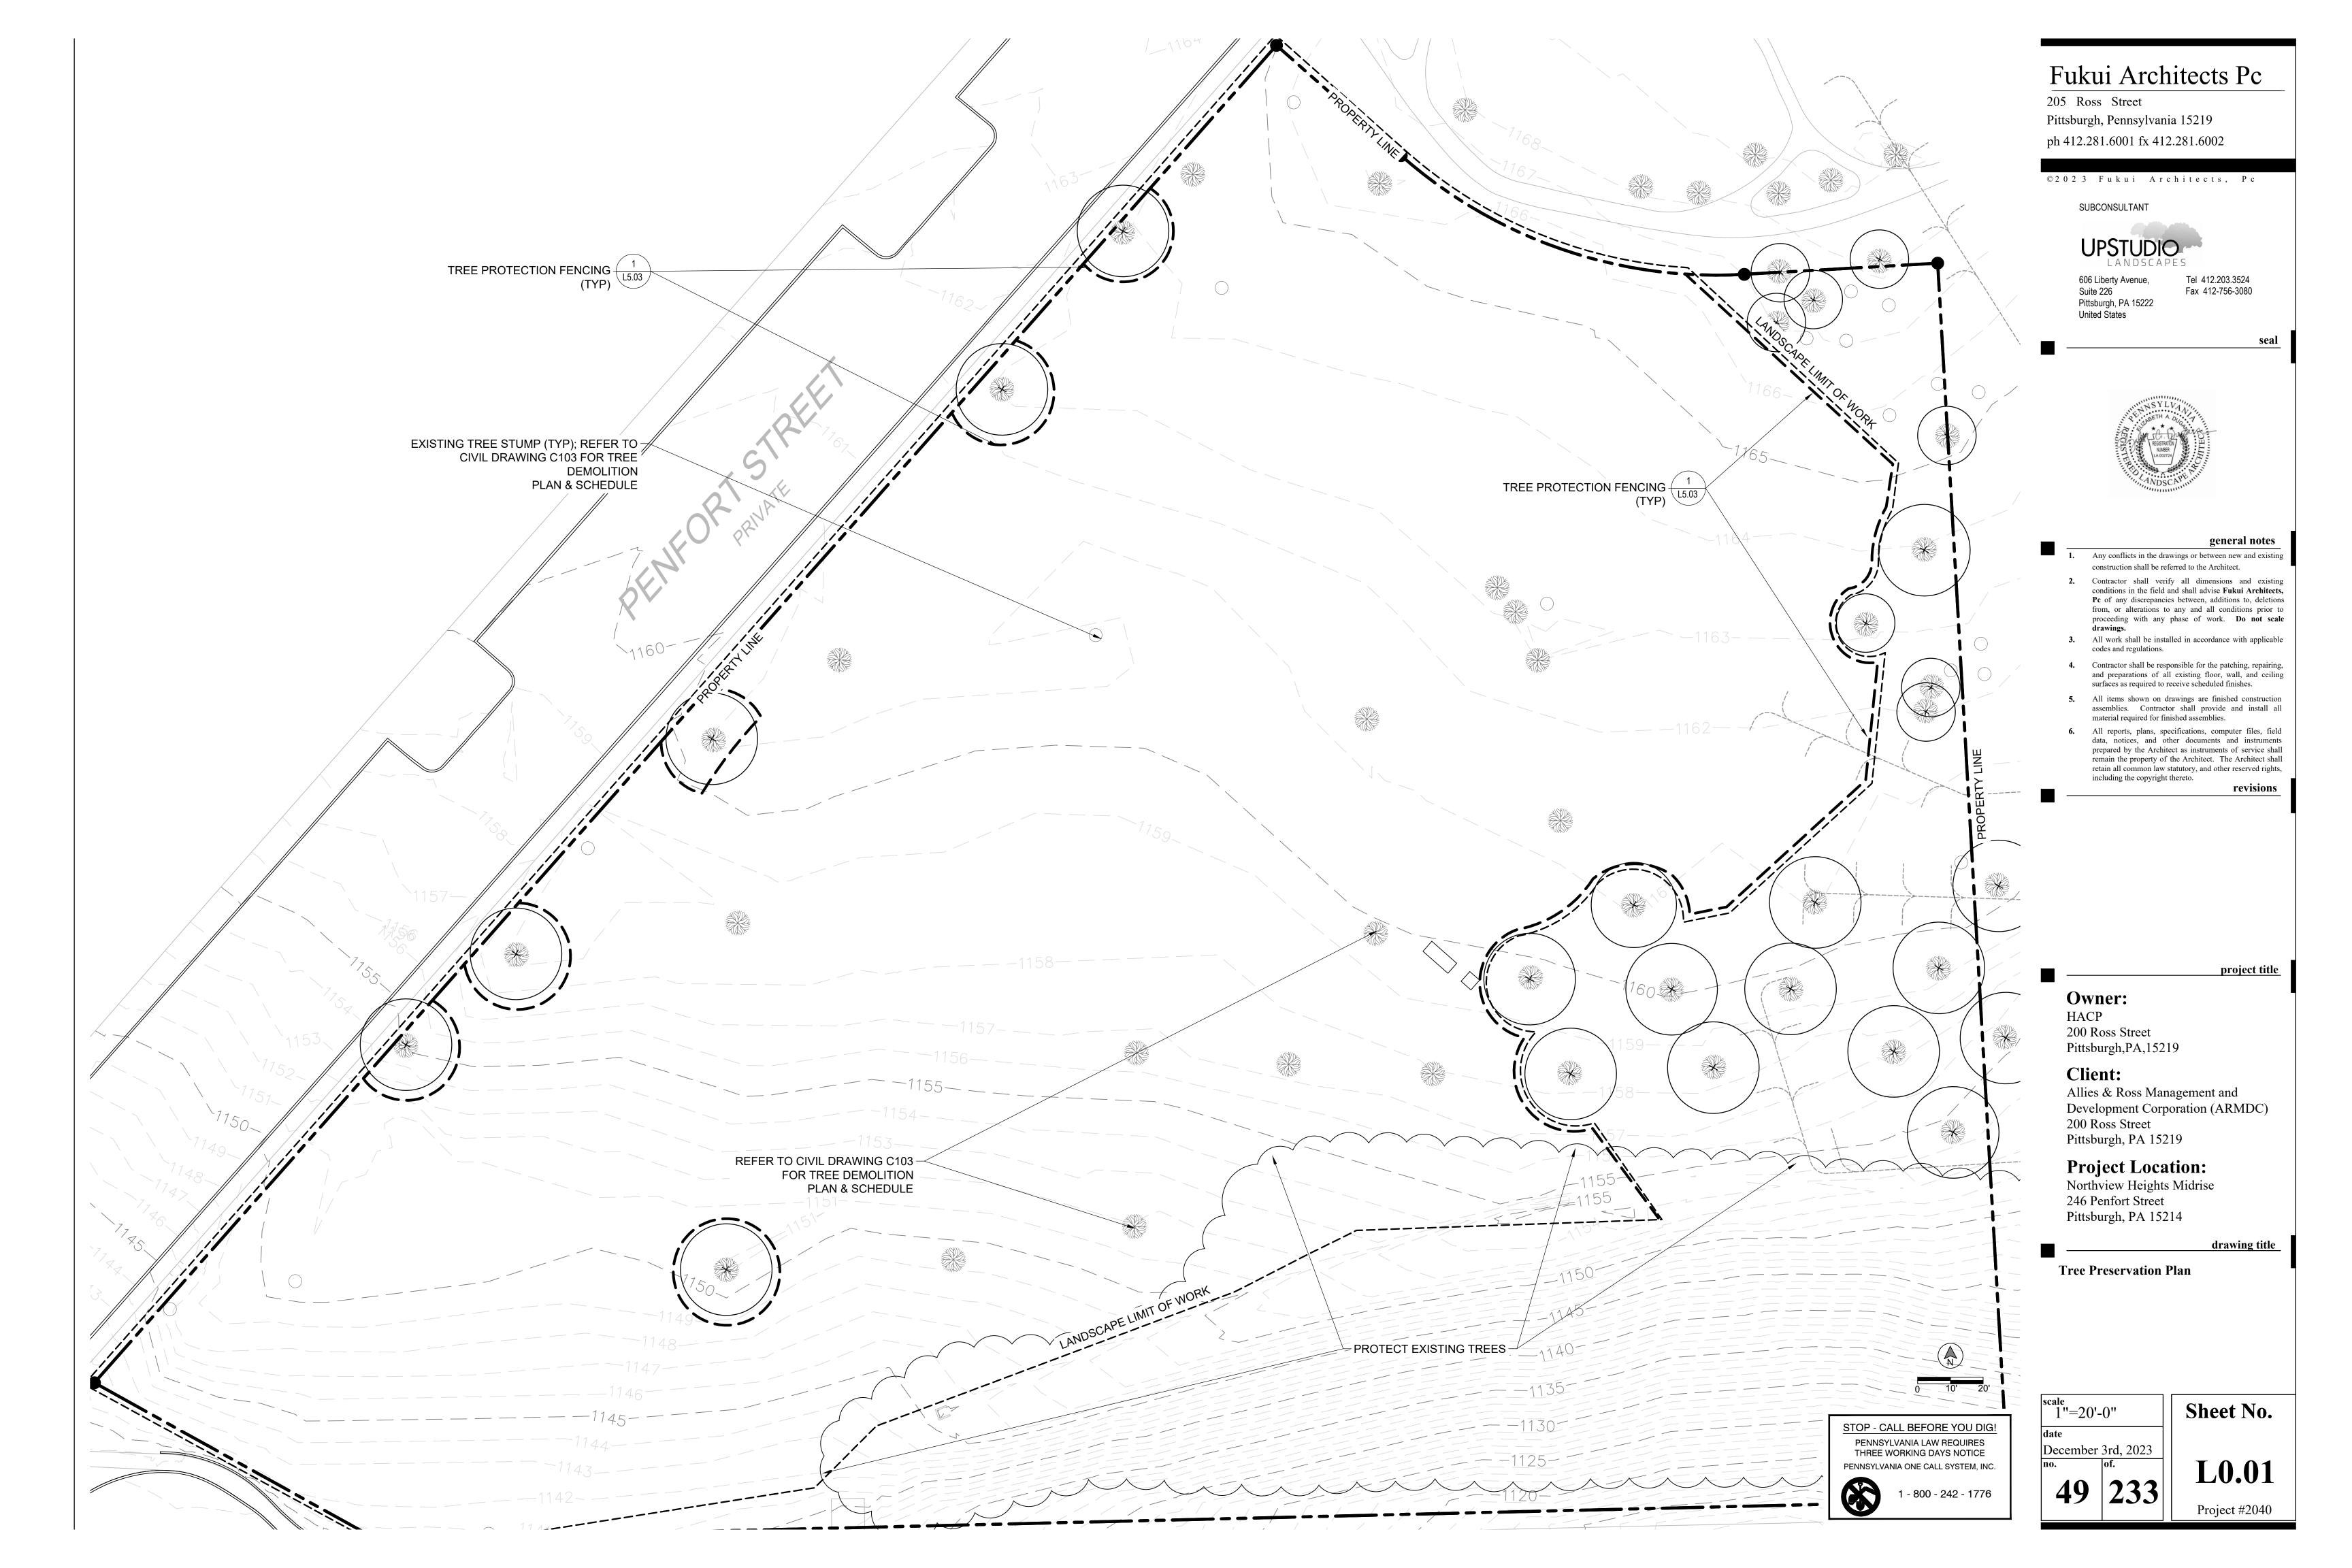

Site Furnishing Schedule

(i)	SITE FURNISHINGS SCHEDULE						
Code	Qty.	Туре	Manufacturer	Model, Color, etc.	Attachment	Detail	Notes
F-01	9	BACKED BENCH	KEYSTONE RIDGE DESIGNS	BESSEMER BENCH WITH BACK, 6FT, GLOSS BLACK POWDERCOAT	SURFACE MOUNT	REFER TO DETAIL 1 ON SHEET L4.00	REQUIRES STAINLESS STEEL ANCHOR BOLTS (NOT PROVIDED)
F-02	6	DUAL RECYCLE/LITTER RECEPTACLE		HARMONY DUAL RECYCLE/LITTER RECEPTACLE, 32 GALLON WITH ELEVATED LIDS AND PLASTIC LINER, GLOSS BLACK POWDERCOAT	SURFACE MOUNT	REFER TO DETAIL 2 ON SHEET L4.00	REQUIRES STAINLESS STEEL ANCHOR BOLTS (NOT PROVIDED)
F-03	3	BIKE RACK	KEYSTONE RIDGE DESIGNS	SONANCE 9 BIKE CAPACITY BIKE RACK, GLOSS BLACK POWDERCOAT	EMBED MOUNT	REFER TO DETAIL 3 ON SHEET L4.00	REQUIRES SUBSURFACE CONCRETE FOOTING PER MANUFACTUER'S SPECIFICATIONS
F-04	4	SQUARE RAISED PLANTERS	TOURNESOL SITE WORKS	WILSHIRE SQUARE FRP FIBERGLASS PLANTER, 36" X 36" X 30" HEIGHT WITHOUT TOE KICK, MODEL #WR-3600F, SMOOTH FINISH, WITH STANDARD DRAIN HOLES (DHC), WITH REINFORCED BOTTOM AND WATER RESISTANT PLATE (LSP-1212) (QUANTITY OF PLATES REQUIRED PER MANUFACTURER RECOMMENDATIONS)		REFER TO DETAIL 3 ON SHEET L4.04	COLOR PALETTE TO BE PROVIDED FOR ARCHITECT/OWNER SELECTION, REQUIRES CORROSION-RESISTANT ANCHORS (NOT PROVIDED)
F-05	2	4 SEAT DINING TABLE		EASTON 40" ROUND TABLE WITH UMBRELLA HOLE AND 4 SEATS WITH BACK, PERFORATED TABLE TOP, GLOSS BLACK POWDERCOAT		REFER TO DETAIL 4 ON SHEET L4.00	REQUIRES STAINLESS STEEL ANCHOR BOLTS (NOT PROVIDED)
F-06	3	5 SEAT DINING TABLE (ADA ACCESSIBLE)		ASTON 60" ROUND TABLE WITH UMBRELLA HOLE 5 SEATS WITH BACK AND NE ADA OPENING, PERFORATED TABLE TOP, GLOSS BLACK POWDERCOAT		REFER TO DETAIL 5 ON SHEET L4.00	REQUIRES STAINLESS STEEL ANCHOR BOLTS (NOT PROVIDED)
F-07	1	GROUP GRILL	PLAYWORLD	EDESTAL GROUP GRILL, STEEL WITH BLACK ENAMEL FINISH			MOUNT TO PAVING PER MANUFACTURER'S SPECIFICATIONS, REQUIRES STAINLESS STEEL ANCHOR BOLTS (NOT PROVIDED)
F-08	4	RECTANGULAR RAISED PLANTER	TOURNESOL SITE WORKS	VILSHIRE RECTANGULAR FRP FIBERGLASS PLANTER, 120" X 18" X 30" HEIGHT, MODEL WR-1201830, SMOOTH FINISH, WITH STANDARD DRAIN HOLES (DHC), WITH REINFORCED BOTTOM AND WATER RESISTANT PLATE (LSP-1212) QUANTITY OF PLATES REQUIRED PER MANUFACTURER RECOMMENDATIONS)		REFER TO DETAIL 3 ON SHEET L4.04	COLOR PALETTE TO BE PROVIDED FOR ARCHITECT/OWNER SELECTION, REQUIRES CORROSION-RESISTANT ANCHORS (NOT PROVIDED)
F-09	1	3 SEAT DINING TABLE (ADA ACCESSIBLE)		EASTON 40" ROUND TABLE WITH UMBRELLA HOLE AND 3 SEATS WITH BACK AND ONE ADA OPENING, PERFORATED TABLE TOP, GLOSS BLACK POWDERCOAT	SURFACE MOUNT	REFER TO DETAIL 2 ON SHEET L4.04	REQUIRES STAINLESS STEEL ANCHOR BOLTS (NOT PROVIDED)
F-10	1	ACCESSIBLE GRILL	PILOT ROCK	ACCESSIBLE PARK GRILL MODEL ASW-20 B18 S6, WITH WITH BOLT-DOWN BASE PLATE, AND 8"X16" SWIVEL SHELF ATTACHED ON BASE POST, HEAT RESISTANT BLACK ENAMEL PAINT	SURFACE MOUNT	REFER TO DETAIL 4 ON SHEET L4.05	REQUIRES STAINLESS STEEL ANCHOR BOLTS (NOT PROVIDED)
OUT	DOO	R SHELTERS					
F-11	Qty.	Type PAVILION	Manufacturer ICON	Model, Color, etc. OPEN AIR STEEL HEXAGON PAVILION STRUCTURE, MODEL # HX32-9M-P4 WITH MANUFACTURER PRE-DRILLED HOLES FOR ELECTRICAL WIRING (*PAVILION HAS LIGHTING- REFER TO ELECTRICAL SITE PLAN & SCHEDULE FOR INFORMATION), SURFACE MOUNT WITH BASE COVERS	SURFACE MOUNT	Detail REFER TO SHEET L4.01 AND L4.02 *REFER TO E010 FOR ELECTRICAL SITE PLAN AND E400 ELECTRICAL SCHEDULE FOR PAVILION LIGHTING	FOOTING PER MANUFACTUER'S SPECIFICATIONS, COLOR PALETTE TO
F-12	1	COVERED BIKE SHELTER	I ICON	MONOSLOPE BIKE SHELTER, MODEL # MC7.5X24M-P3, SURFACE MOUNT WITH BASE COVER	SURFACE MOUNT	REFER TO SHEET 14 03	REQUIRES SUBSURFACE CONCRETE
MANUF		ON SHELTER SYSTEM	IS, INC.	HTTPS://WWW.ICONSHELTERS.COM/		PHONE: 1-80	UTE 910 A, PA 15051
KEYSTONE RIDGE DESIGNS, INC.		NS, INC.	HTTPS://WWW.KEYSTONERIDGEDESIGNS.COM/		ADAM BENJAMIN TERRITORY MANAGER KEYSTONE RIDGE DESIGNS, INC. 670 MERCER RD BUTLER, PA 16001-1840 PHONE: (724) 284-1213 EXT 240 EMAIL: ADAMB@KEYSTONERIDGEDESIGNS.COM		
PILOT ROCK			WWW.PILOTROCK.COM		JEFFREY ASSOCIATES 897 ROUTE 910 INDIANOLA, PA 15051 PHONE: 1-800-221-8995 CHRIS@JEFFREYASSOCIATES.COM		
		PLAYWORLD		HTTPS://PLAYWORLD.COM/		PHONE: 1-80	UTE 910 A, PA 15051
		TOURNESOL SITEWO	DRKS	<u>WWW.TOURNESOL.COM</u>		PHONE (800	SITEWORKS
			Ql	NOTE: INSTALL SITE FURNISHINGS PER MANUFACTURER'S SPECIFICATION OF CONTRACTOR CONVENIENCE ONLY. CONTRACTOR TO VI		ANTITIES.	

GENERAL NOTES: PRIOR TO CONSTRUCTION:

- 1. CONTRACTOR SHALL OBTAIN ALL RELEVANT DRAWINGS, DETAILS AND SPECIFICATIONS PRIOR TO BEGINNING CONSTRUCTION.
- 2. CONTRACTOR SHALL VERIFY EXISTING FIELD CONDITIONS, REVIEW DRAWINGS AND PROPOSED WORK PRIOR TO CONSTRUCTION. ANY DISCREPANCIES SHALL BE BROUGHT TO THE ATTENTION OF THE LANDSCAPE ARCHITECT IMMEDIATELY.
- 3. CONTRACTOR SHALL PROTECT ALL EXISTING UTILITIES AND SITE IMPROVEMENTS THAT ARE NOTED TO REMAIN AND SHALL COORDINATE WITH PENNSYLVANIA ONE CALL SYSTEM, INC. TO VERIFY LOCATION OF ALL UTILITIES. CALL 1-800-242-1776.
- 4. CONTRACTOR SHALL REMOVE ALL VEGETATION WITHIN THE LIMIT OF WORK UNLESS OTHERWISE NOTED. DO NOT DISTURB OR REMOVE EXISTING TREES/VEGETATION DESIGNATED TO BE PROTECTED OR THOSE LOCATED OUTSIDE THE LIMIT OF WORK. REFER TO SHEET C103 IN CIVIL DRAWINGS FOR SITE DEMOLITION PLAN. REFER TO L0.01 FOR TREE PRESERVATION PLAN.
- THE CONTRACTOR SHALL PROTECT ALL UTILITIES AND APPURTENANCES (ABOVE AND BELOW GROUND) UNLESS OTHERWISE NOTED. IT IS THE CONTRACTOR'S RESPONSIBILITY TO VERIFY THE EXISTENCE OF EXISTING UTILITIES, STRUCTURES, AND PIPES PRIOR TO STARTING WORK. CONTRACTOR SHALL NOTIFY THE LANDSCAPE ARCHITECT IF ANY PROPOSED IMPROVEMENTS ARE IN CONFLICT WITH EXISTING FEATURES SO THAT LOCATION ADJUSTMENTS CAN BE MADE IF NECESSARY.
- 6. VERIFY LAYOUT OF LANDSCAPE ELEMENTS WITH LANDSCAPE ARCHITECT PRIOR TO COMMENCEMENT OF WORK AND ADJUST AS REQUIRED.
- 7. FOR REAR GARDEN WALKWAYS LOCATE CONTROL AND EXPANSION JOINTS AS SHOWN ON L3.02. PROVIDE EXPANSION JOINTS WHERE CONCRETE WALK ABUTS EXISTING AND PROPOSED BUILDINGS, SITE WALLS AND EXISTING PAVEMENTS. REFER TO CIVIL DRAWINGS FOR ALL OTHER SIDEWALKS.

Fukui Architects Pc

205 Ross Street
Pittsburgh, Pennsylvania 15219
ph 412.281.6001 fx 412.281.6002

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SUBCONSULTANT



606 Liberty Avenue, Tel 412.203.3524
Suite 226 Fax 412-756-3080
Pittsburgh, PA 15222
United States

se



general notes

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revisions

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HACP 200 Ross Street Pittsburgh,PA,15219

Client:

Allies & Ross Management and Development Corporation (ARMDC) 200 Ross Street Pittsburgh, PA 15219

Project Location:

Northview Heights Midrise 246 Penfort Street Pittsburgh, PA 15214

drawing title

Schedules

STOP - CALL BEFORE YOU DIG!

PENNSYLVANIA LAW REQUIRES
THREE WORKING DAYS NOTICE
PENNSYLVANIA ONE CALL SYSTEM, INC.


1 - 800 - 242 - 1776


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date
December 3rd, 2023


of.

L1.00
Project #2040


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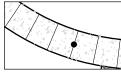
Legend

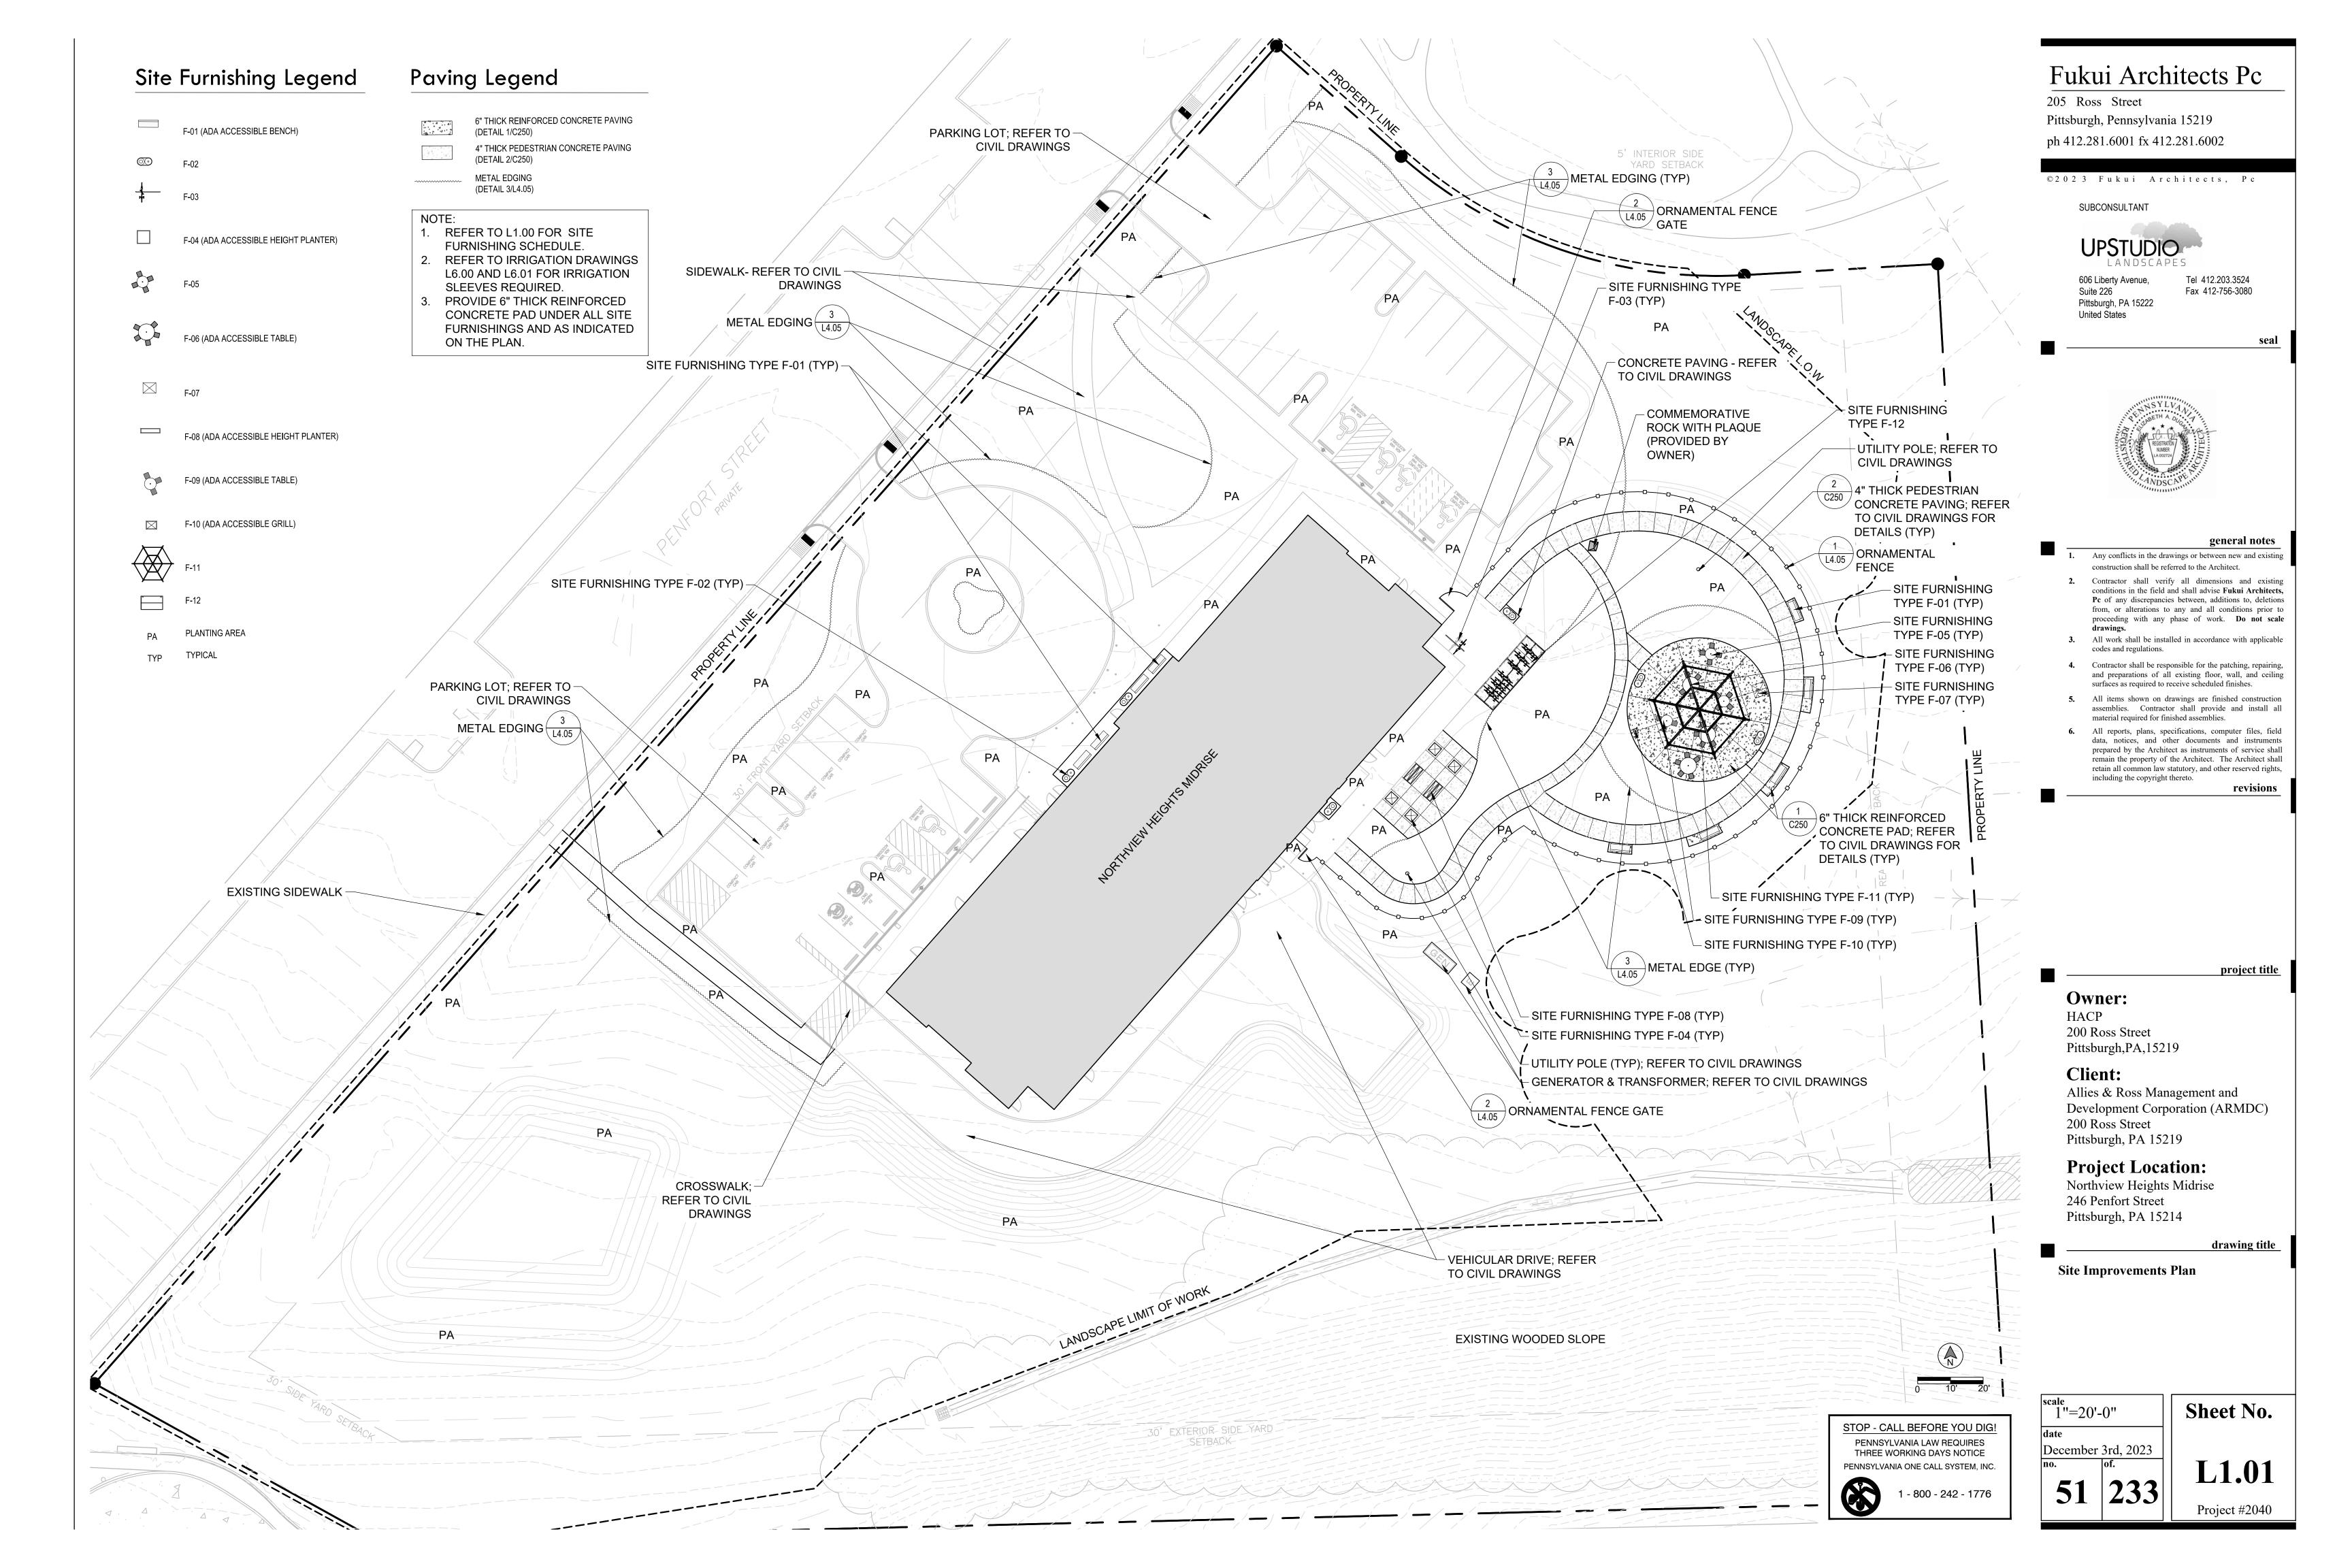

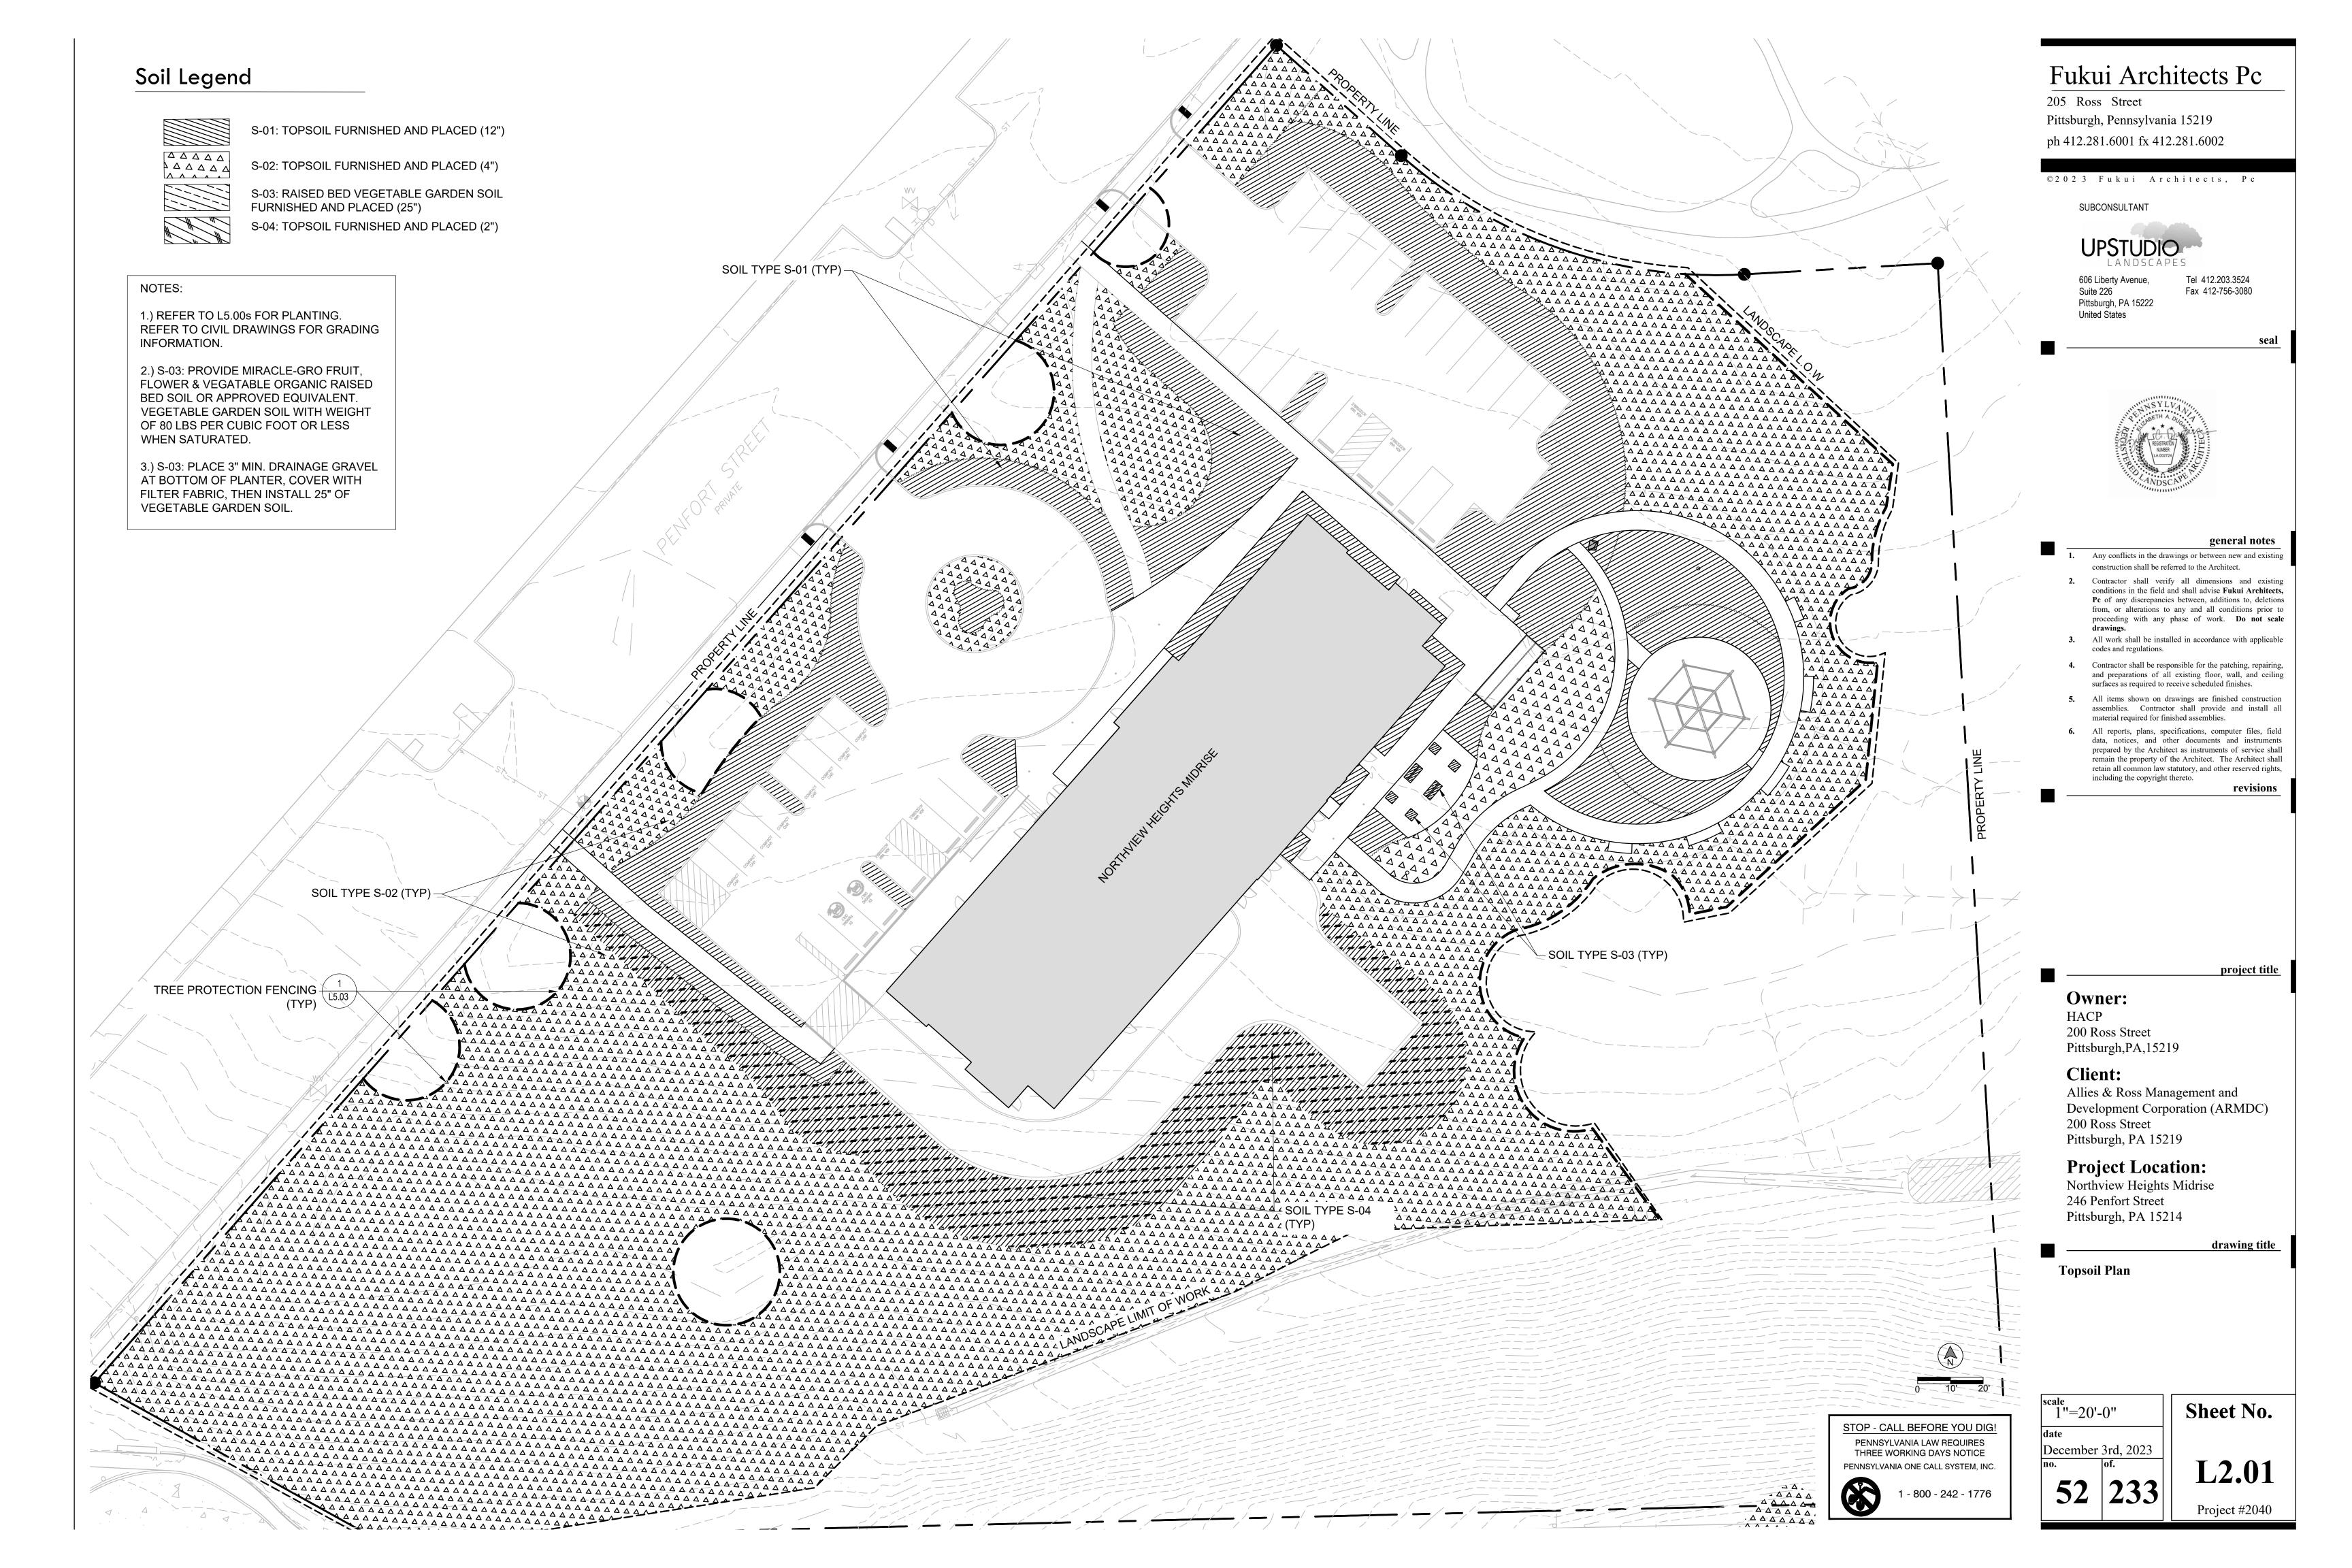CONTROL JOINT (5' SPACING TYP) REFER TO CIVIL DETAIL SHEET C201.

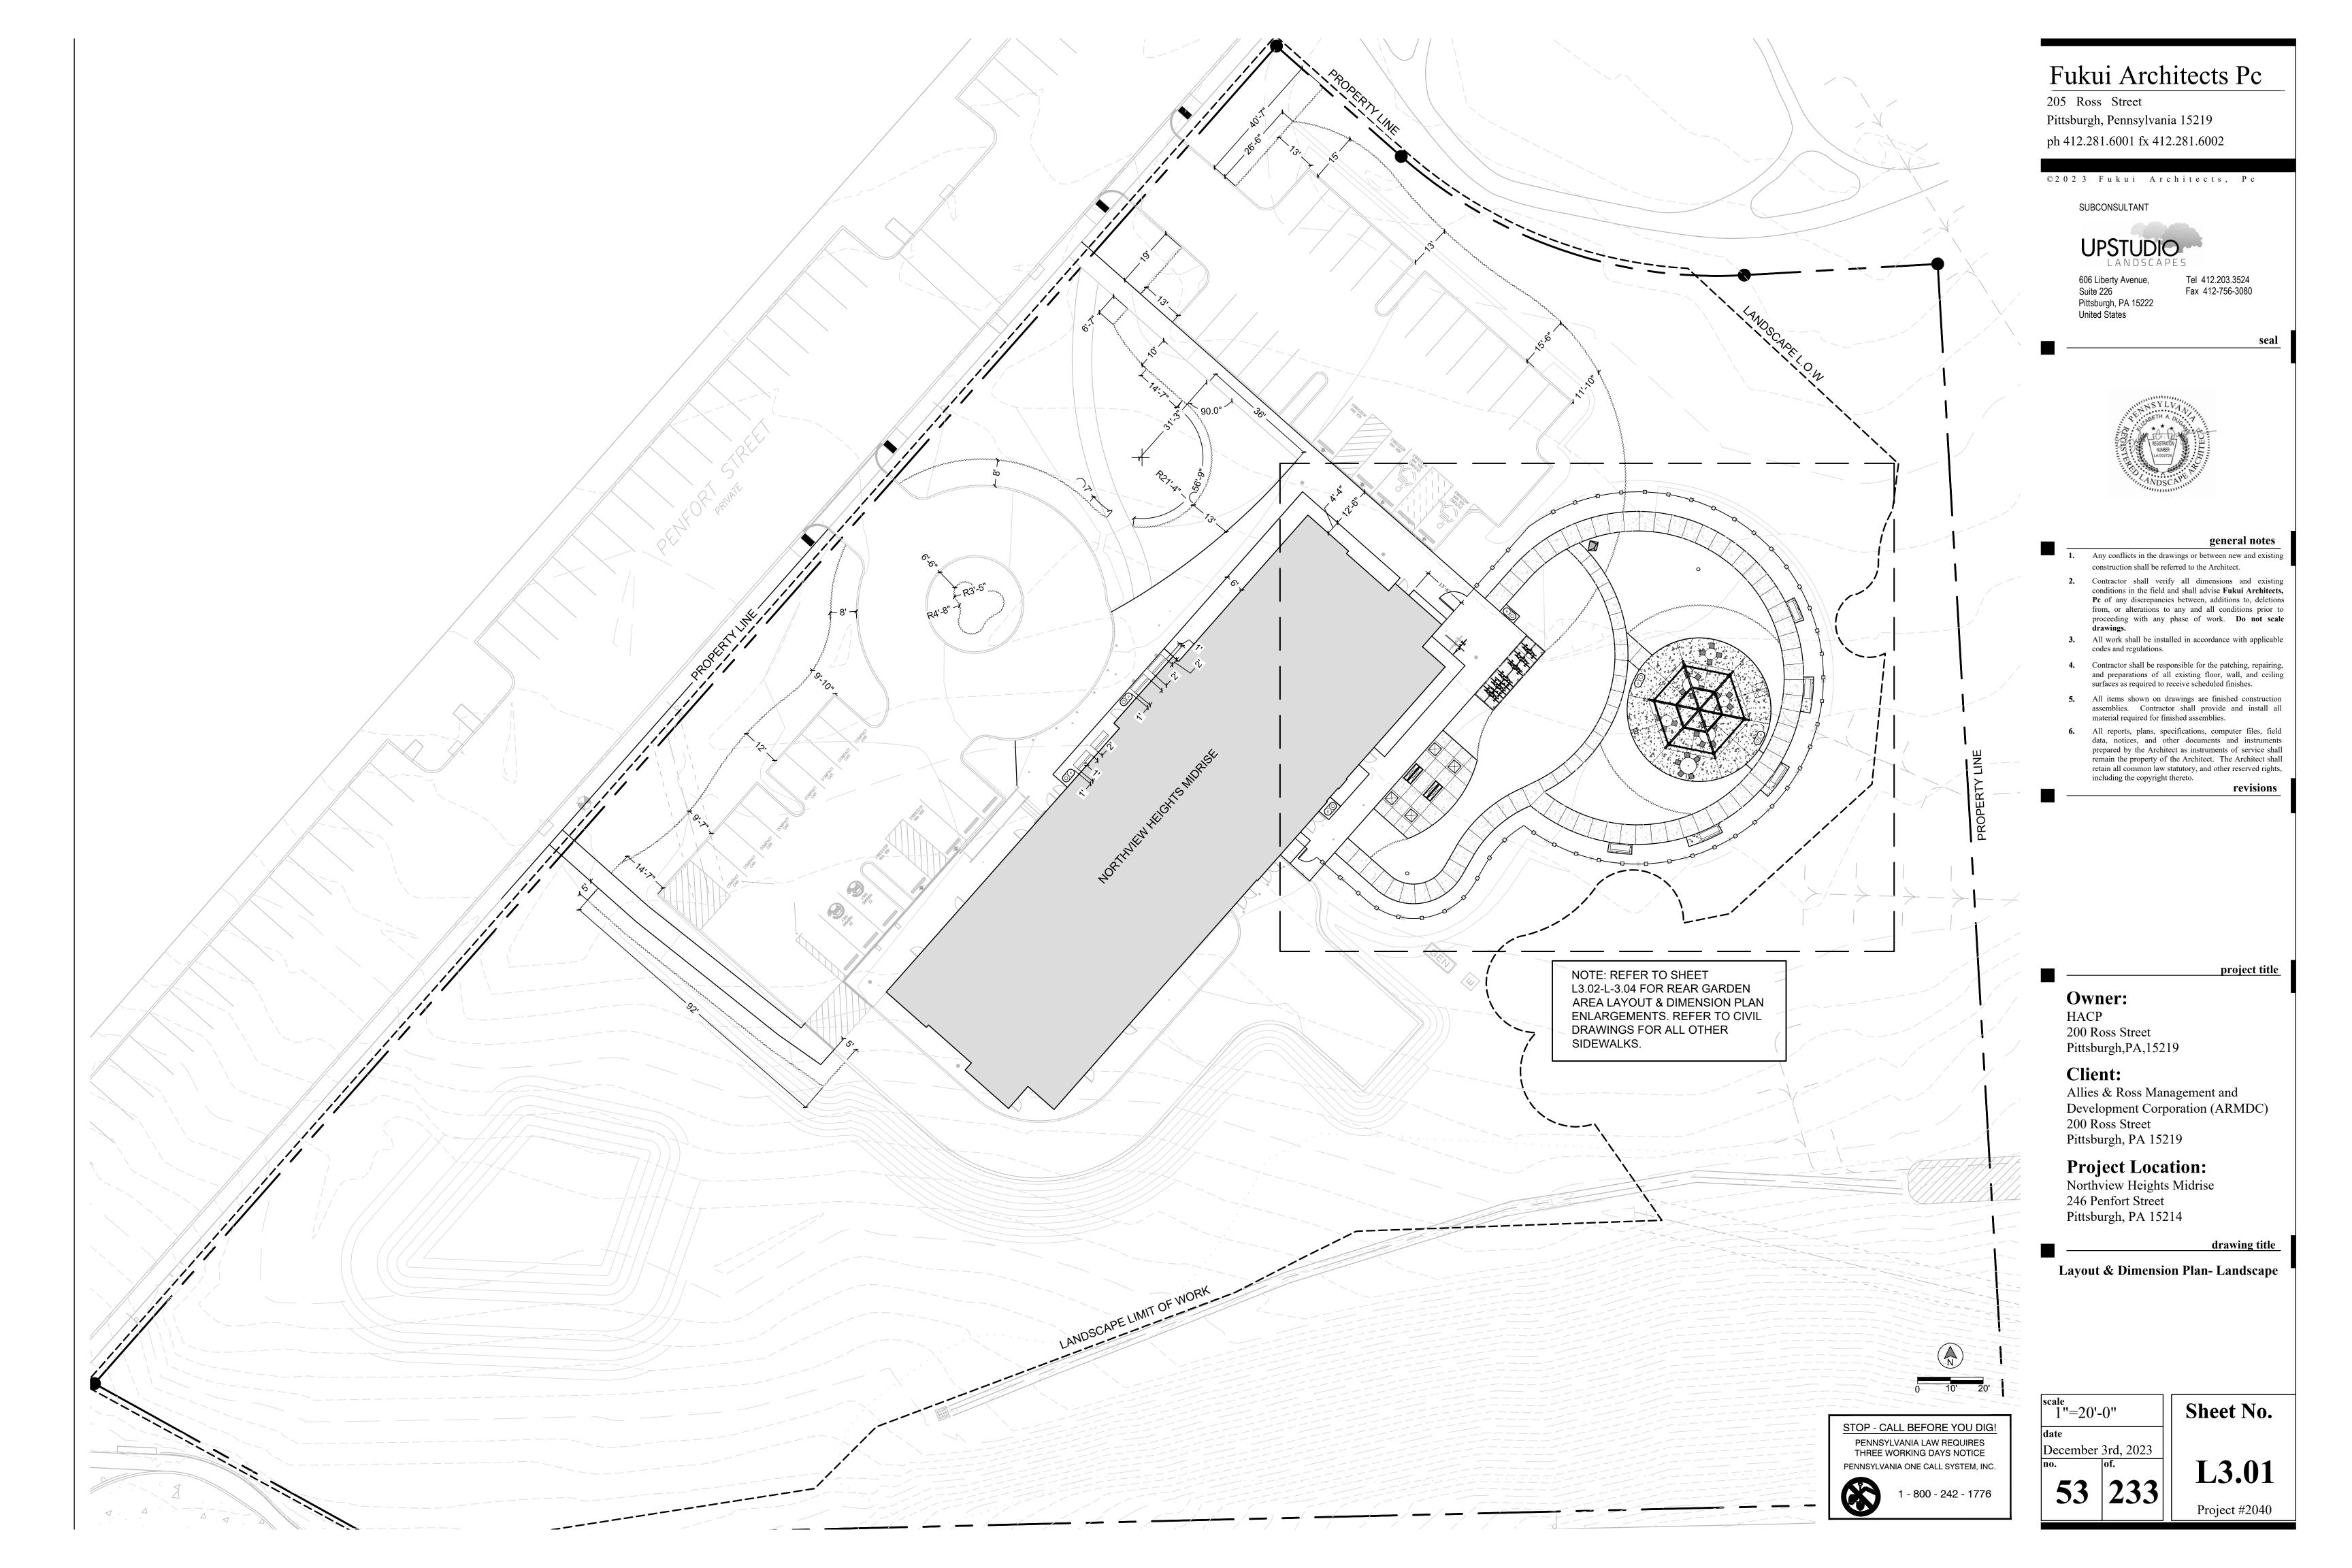GARDEN WALKWAY - FLATWORK LAYOUT

SCALE: 1"=10'-0"

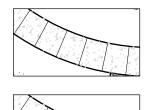

EXPANSION JOINT (25' MAX SPACING TYP) REFER TO CIVIL DETAIL SHEET C201.

NOTE: REAR GARDEN WALKWAYS SHOWN BELOW. REFER TO CIVIL DRAWINGS FOR ALL OTHER PROJECT SIDEWALKS.

EXPANSION JOINT (TYP) CONTROL JOINT (TYP) 3 C250 CONTROL JOINT (TYP) 3 EXPANSION JOINT (TYP)

Fukui Architects Pc

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Tel 412.203.3524 606 Liberty Avenue, Fax 412-756-3080 Pittsburgh, PA 15222

United States



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Project Location:

Northview Heights Midrise 246 Penfort Street Pittsburgh, PA 15214

drawing title

Layout & Dimension Plan -Landscape Enlargements

STOP - CALL BEFORE YOU DIG!

PENNSYLVANIA LAW REQUIRES THREE WORKING DAYS NOTICE PENNSYLVANIA ONE CALL SYSTEM, INC. 1 - 800 - 242 - 1776


2 GARDEN PATIO- FLATWORK LAYOUT

SCALE: 1"=10'-0"

scale 1''=10'-0'' December 3rd, 2023

Sheet No.

L3.02 54 | 233 |

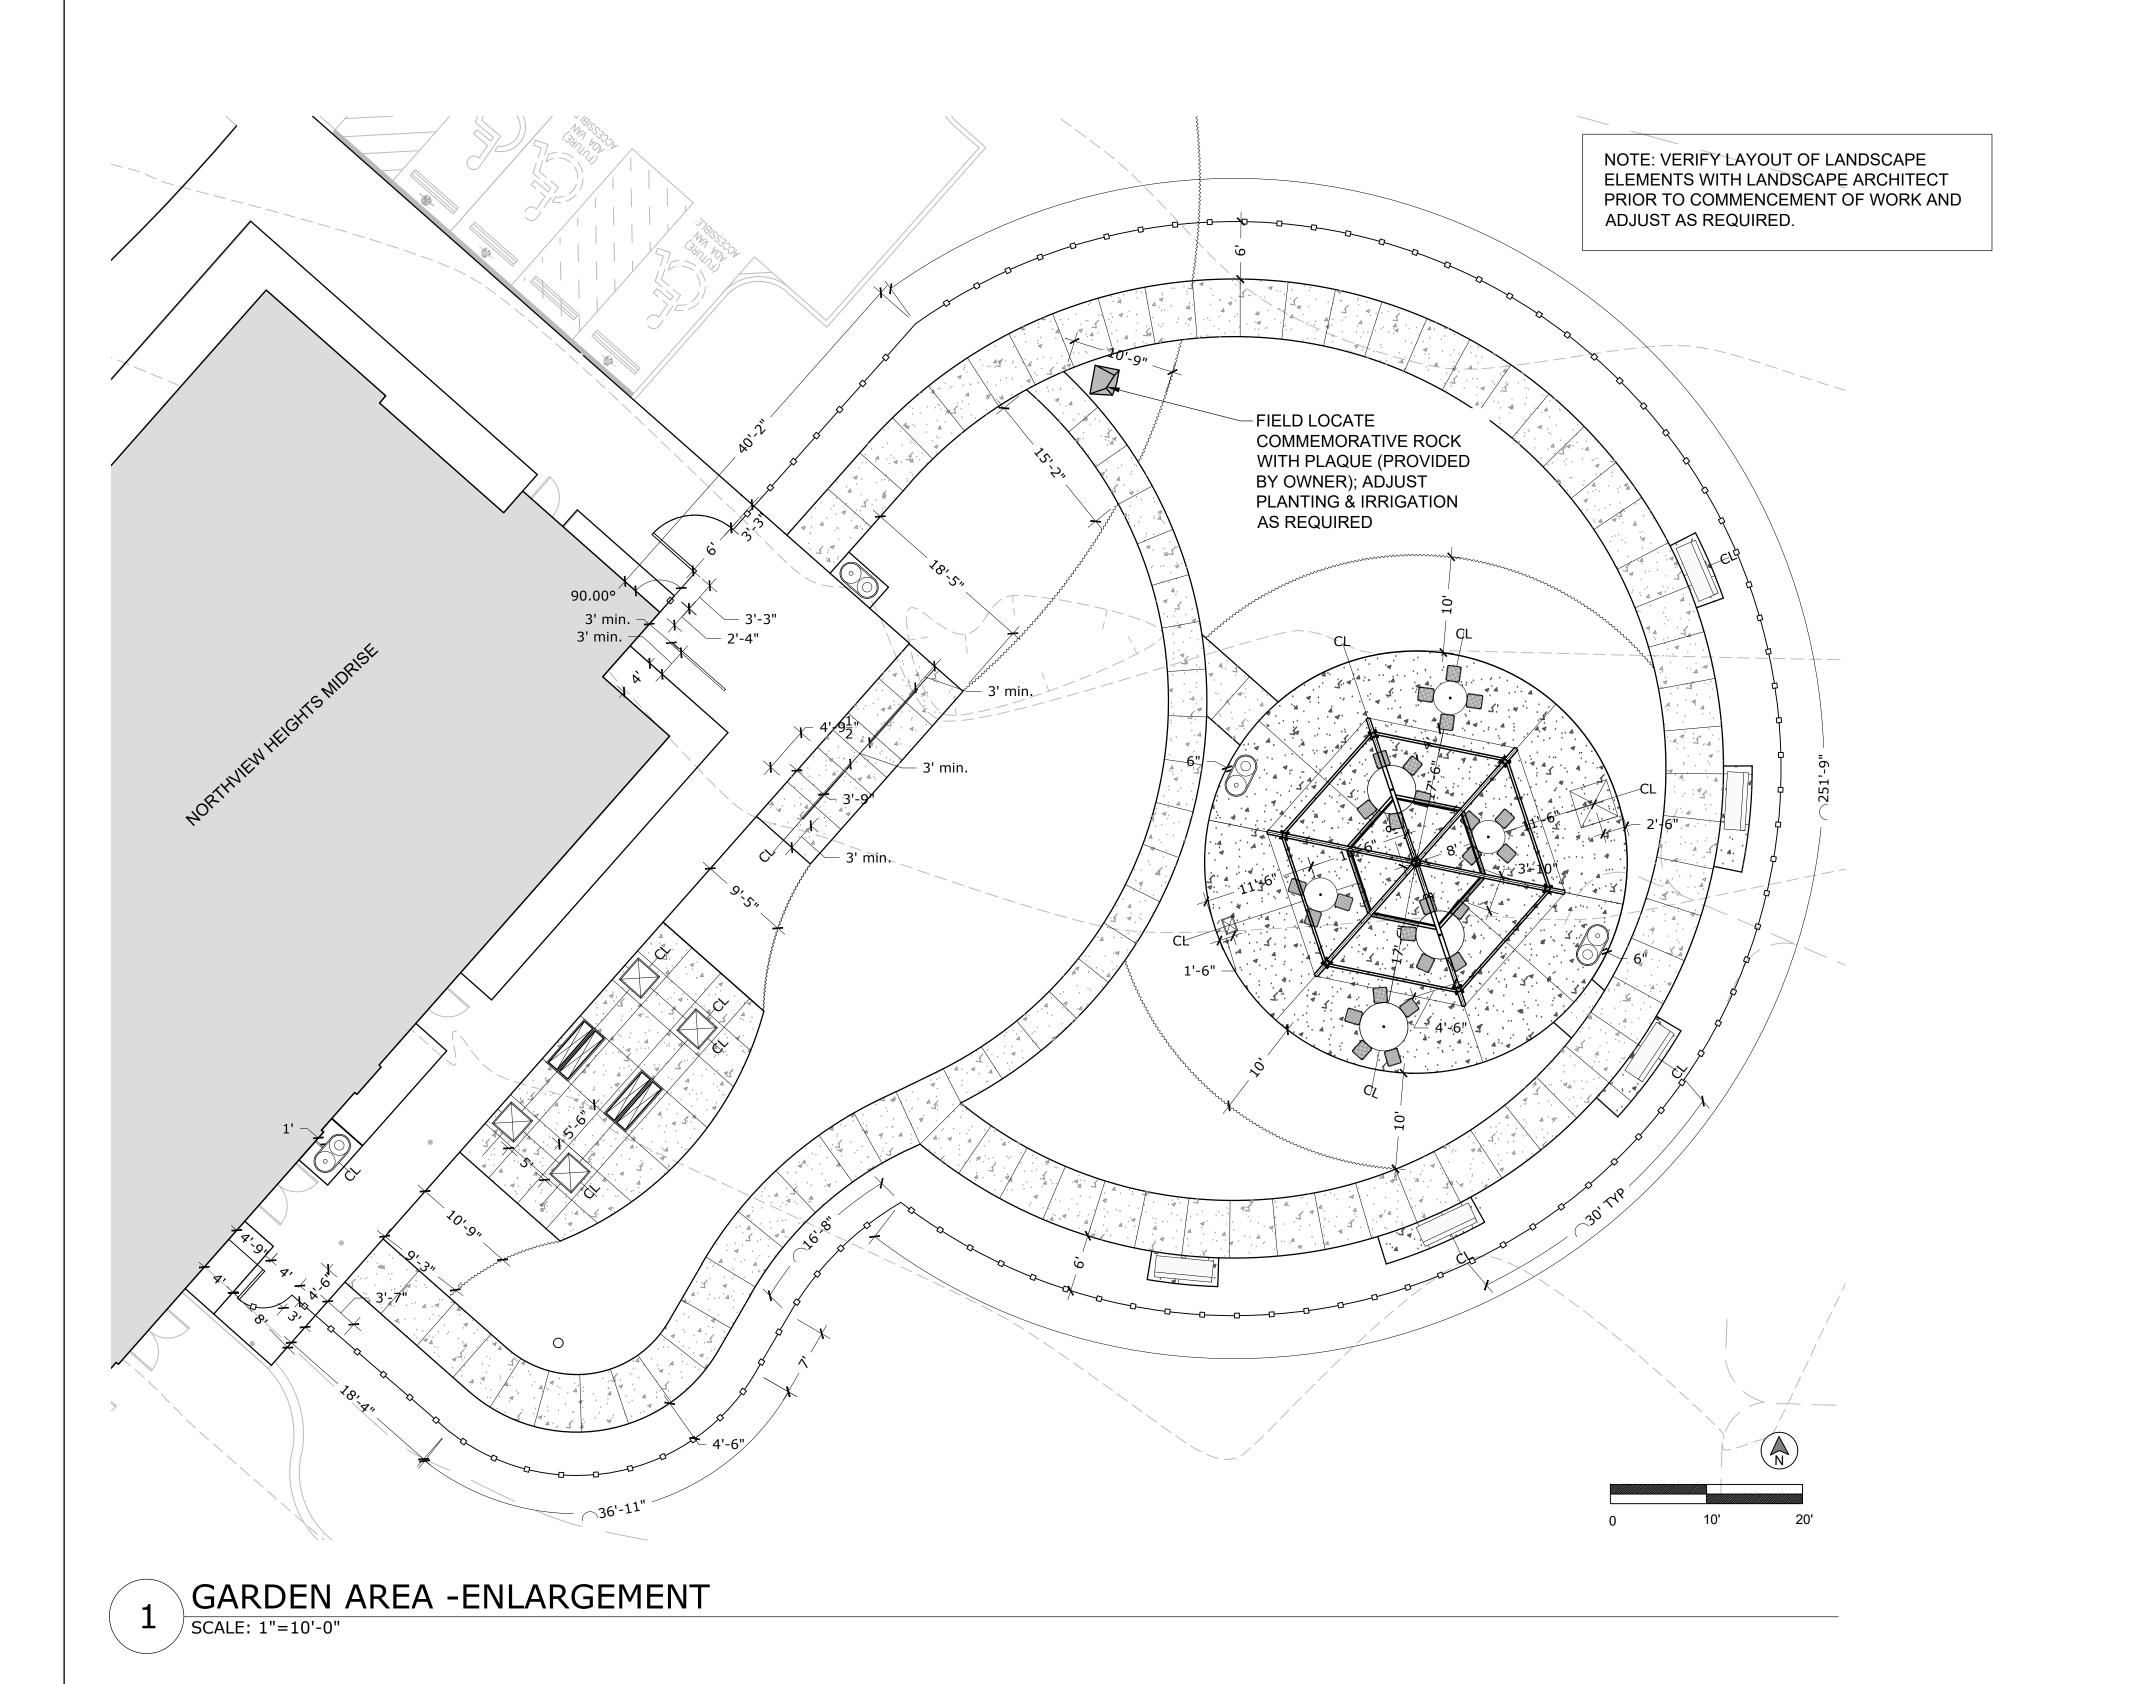

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ph 412.281.6001 fx 412.281.6002

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Suite 226 Fax 412-756-3080
Pittsburgh, PA 15222
United States



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drawing title

Layout & Dimension Plan -Landscape Enlargements

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THREE WORKING DAYS NOTICE
PENNSYLVANIA ONE CALL SYSTEM, INC.

THREE WORKING DAYS NOTICE PENNSYLVANIA ONE CALL SYSTEM, INC.

1 - 800 - 242 - 1776


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date
December 3rd, 2023


Sheet No.

55 233 L3.03
Project #2040

Legend

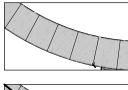

ACCESSIBLE ROUTE

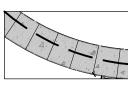

MOST DIRECT ROUTE TO ADA ACCESSIBLE GRILL (ADA ACCESSIBLE ROUTE)



SIZE OF CLEAR FLOOR SPACE AT ACCESSIBLE GRILL. MINIMUM SIZE 48" X 30" (4' X 2.5')

GATE MANEUVERING CLEARANCES


SCALE: 1"=10'-0"

ACCESSIBLE ROUTE TO ADA GRILL AND SEATING

NOTE: REAR GARDEN WALKWAYS SHOWN BELOW. REFER TO CIVIL DRAWINGS FOR ALL OTHER PROJECT SIDEWALKS.

ACCESSIBLE ROUTE:

- 1. ROUTE SHALL HAVE 5% MAX LONGITUDINAL SLOPE AND 2% MAX CROSS SLOPE.
- 2. REFER TO CIVIL DRAWINGS FOR GRADING INFORMATION.

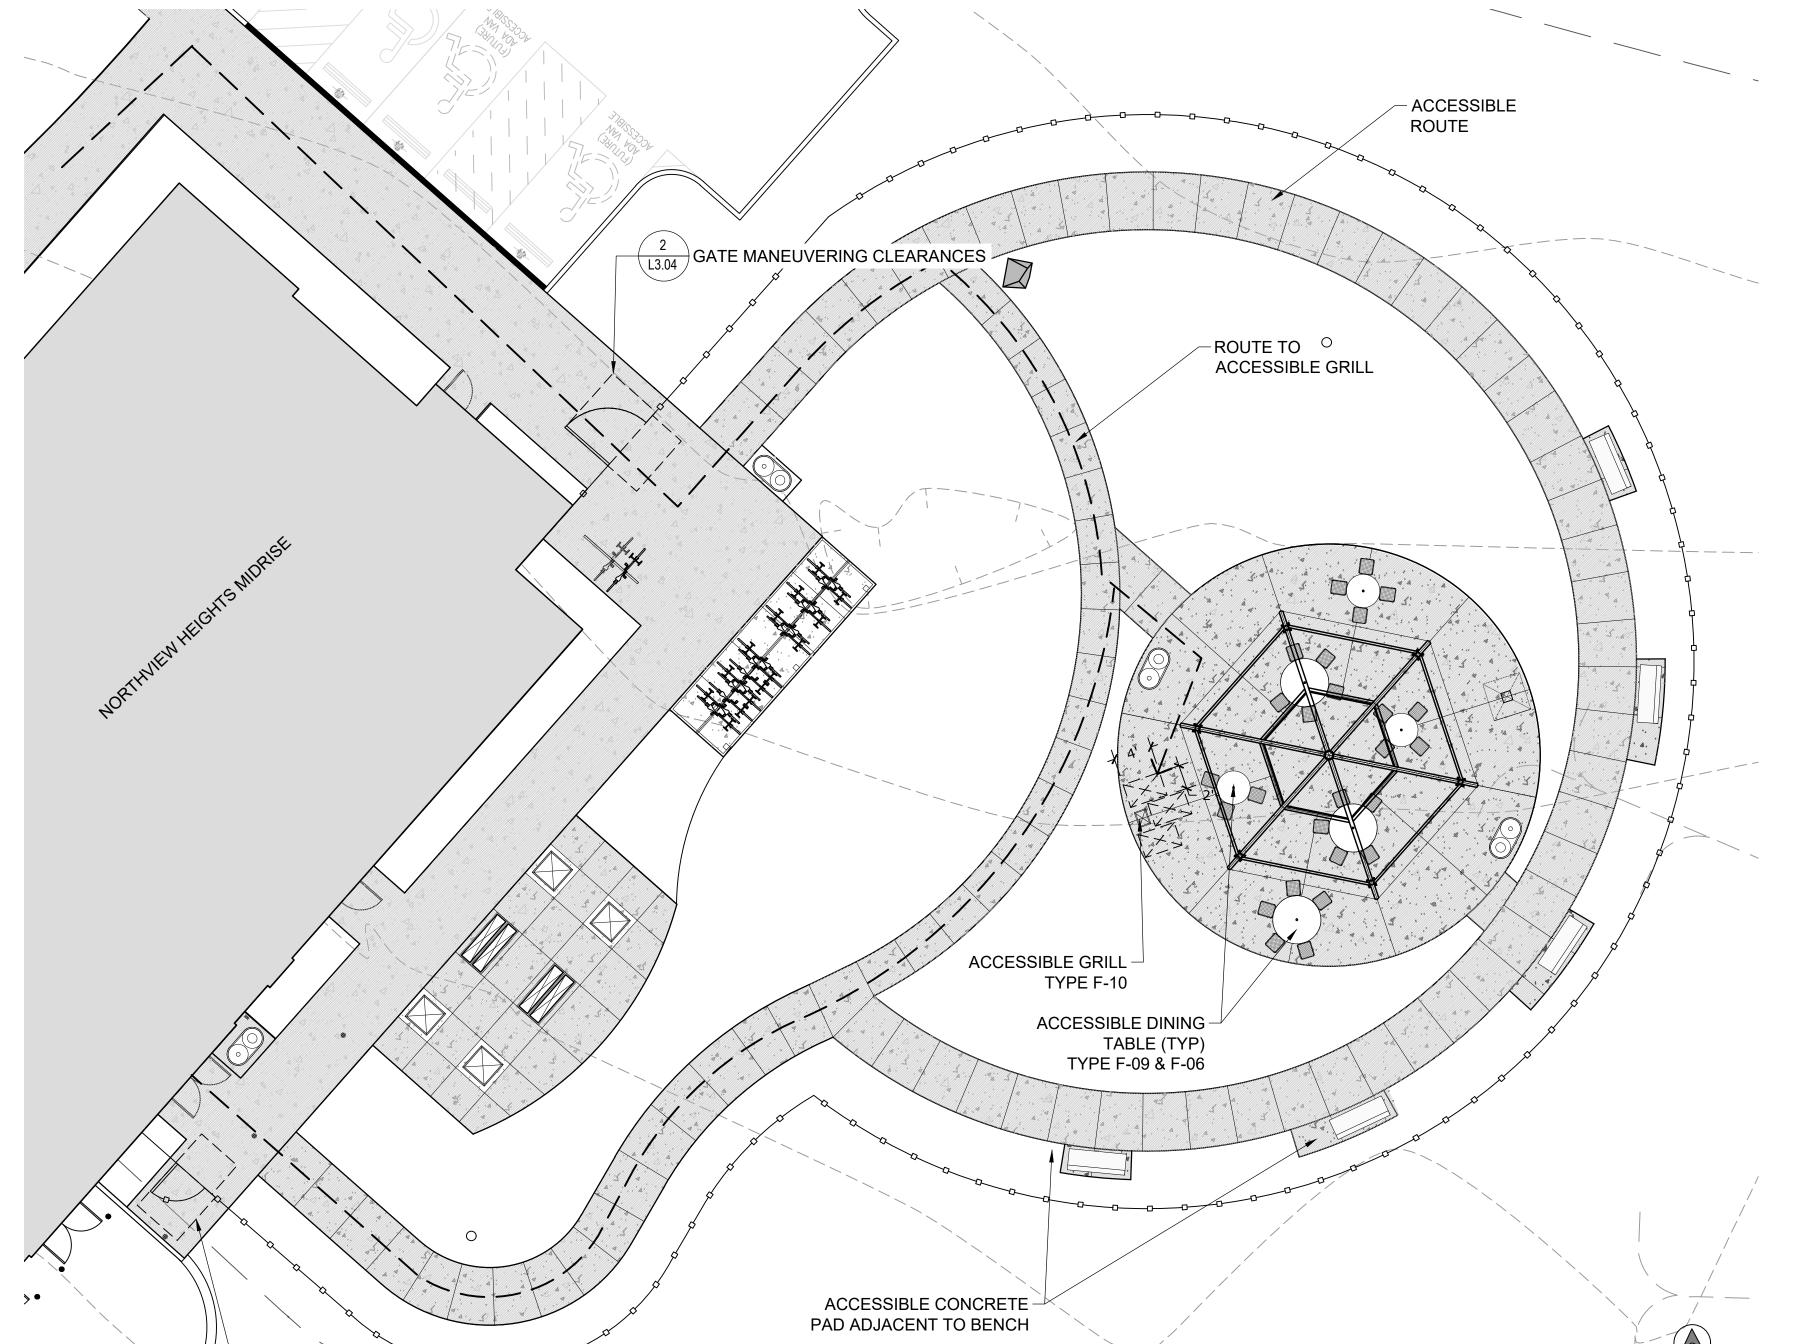


CIVIL DRAWINGS - ACCESSIBLE ROUTE

(FUTURE) ADA ACCESSIBLE

VAN PARKING; REFER TO

GATE MANEUVERING CLEARANCES- EAST GATE 2 SCALE: 1"=10'-0"

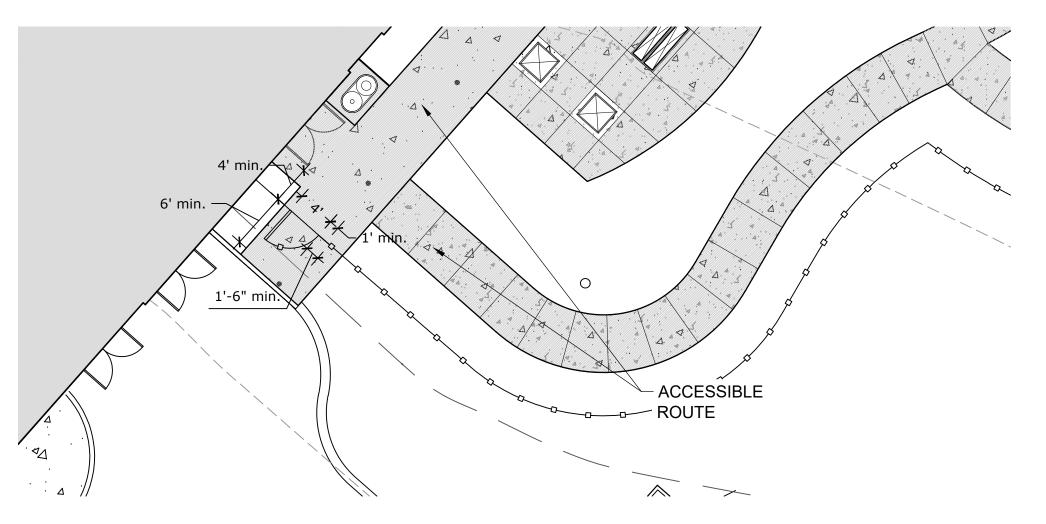

GATE MANEUVERING CLEARANCES- REAR GATE

SCALE: 1"=10'-0"

Fukui Architects Pc

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general notes

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- 2. Contractor shall verify all dimensions and existing conditions in the field and shall advise Fukui Architects, Pc of any discrepancies between, additions to, deletions from, or alterations to any and all conditions prior to proceeding with any phase of work. Do not scale
- **3.** All work shall be installed in accordance with applicable codes and regulations.
- **4.** Contractor shall be responsible for the patching, repairing, and preparations of all existing floor, wall, and ceiling surfaces as required to receive scheduled finishes.
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revisions

project title

Owner:

HACP 200 Ross Street Pittsburgh,PA,15219

Client:

Allies & Ross Management and Development Corporation (ARMDC) 200 Ross Street Pittsburgh, PA 15219

Project Location:

Northview Heights Midrise 246 Penfort Street Pittsburgh, PA 15214

drawing title

Layout & Dimension Plan -Accessibility Enlargements

STOP - CALL BEFORE YOU DIG! PENNSYLVANIA LAW REQUIRES THREE WORKING DAYS NOTICE

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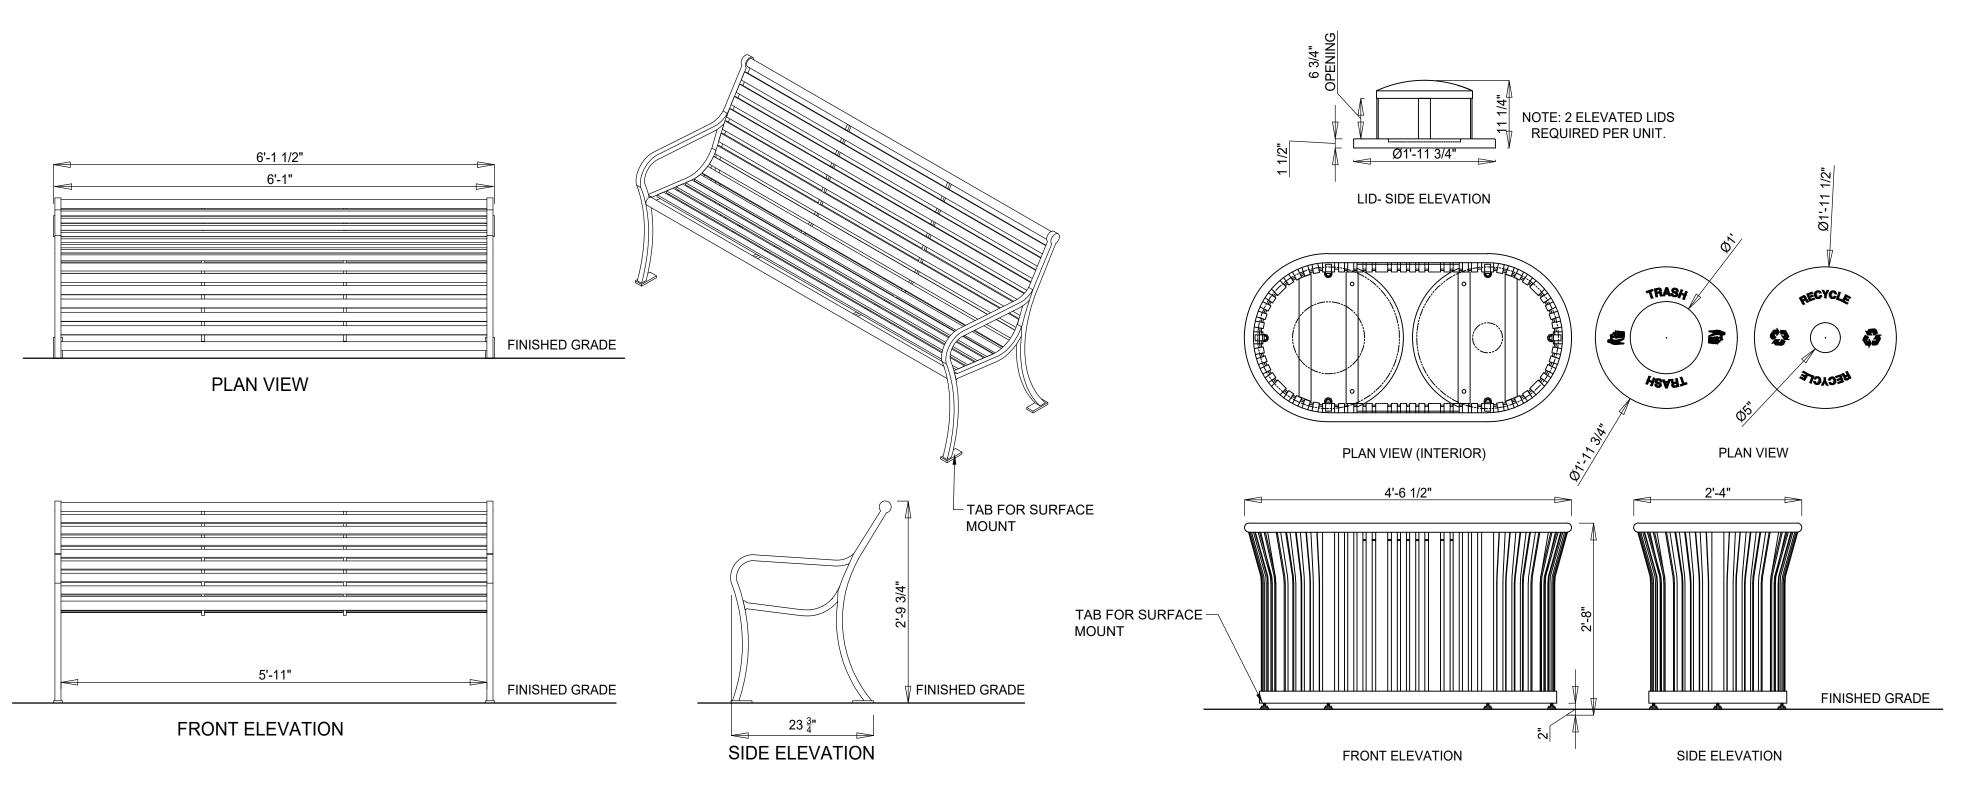
scale 1"=10'-0" December 3rd, 2023

Sheet No.


L3.04

PENNSYLVANIA ONE CALL SYSTEM, INC.

56 | 233 |



—PERFORATED TABLE TOP -PERFORATED TABLE −Ø2" UMB HOLE ─Ø 2" UMB HOLE TAB FOR SURFACE — AXONOMETRIC VIEW PLAN MOUNT PLAN VIEW AXONOMETRIC VIEW TAB FOR SURFACE MOUNT

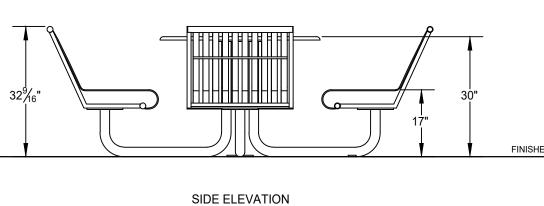

4 SEAT DINING TABLE (F-05)

4 $\frac{1}{\text{SCALE: }1/2"=1'-0"}$

BACKED BENCH (F-01)
SCALE: 3/4"=1'-0"

FINISHED GRADE FRONT ELEVATION

5 SEAT DINING TABLE (ADA ACCESSIBLE) (F-06)

SCALE: 1/2"=1'-0"

SCALE: NTS

1. REFER TO L1.00 FOR SITE FURNISHING SCHEDULE.

- 2. VERIFY LAYOUT OF LANDSCAPE ELEMENTS WITH LANDSCAPE ARCHITECT PRIOR TO COMMENCEMENT OF WORK AND ADJUST AS REQUIRED.
- 3. SURFACED MOUNTED FURNISHINGS REQUIRE STAINLESS STEEL
- ANCHOR BOLTS (NOT PROVIDED). 4. SURFACE MOUNT TO CONCRETE PAVING. REFER TO CIVIL
- DRAWINGS FOR CONCRETE DETAIL.
- 5. INSTALL PER MANUFACTURER'S SPECIFICATIONS.


1. EMBED IN CONCRETE PER MANUFACTURER'S SPECIFICATIONS. 9 CAPACITY RACK 2. COORDINATE INSTALLATION WITH BIKE LENGTH 90 3" SHELTER FOOTING LOCATIONS. REFER TO OVERALL HT 54" L3.00s FOR MINIMUM CLEARANCES. EMBEDDED 12" WEIGHT 120LBS ï2 1/2" [60] 3'-6" [1067] 1' [305]

FOOTING

L12" DIA. MIN

BIKE RACK (F-03)

^L6 1/2" [162]

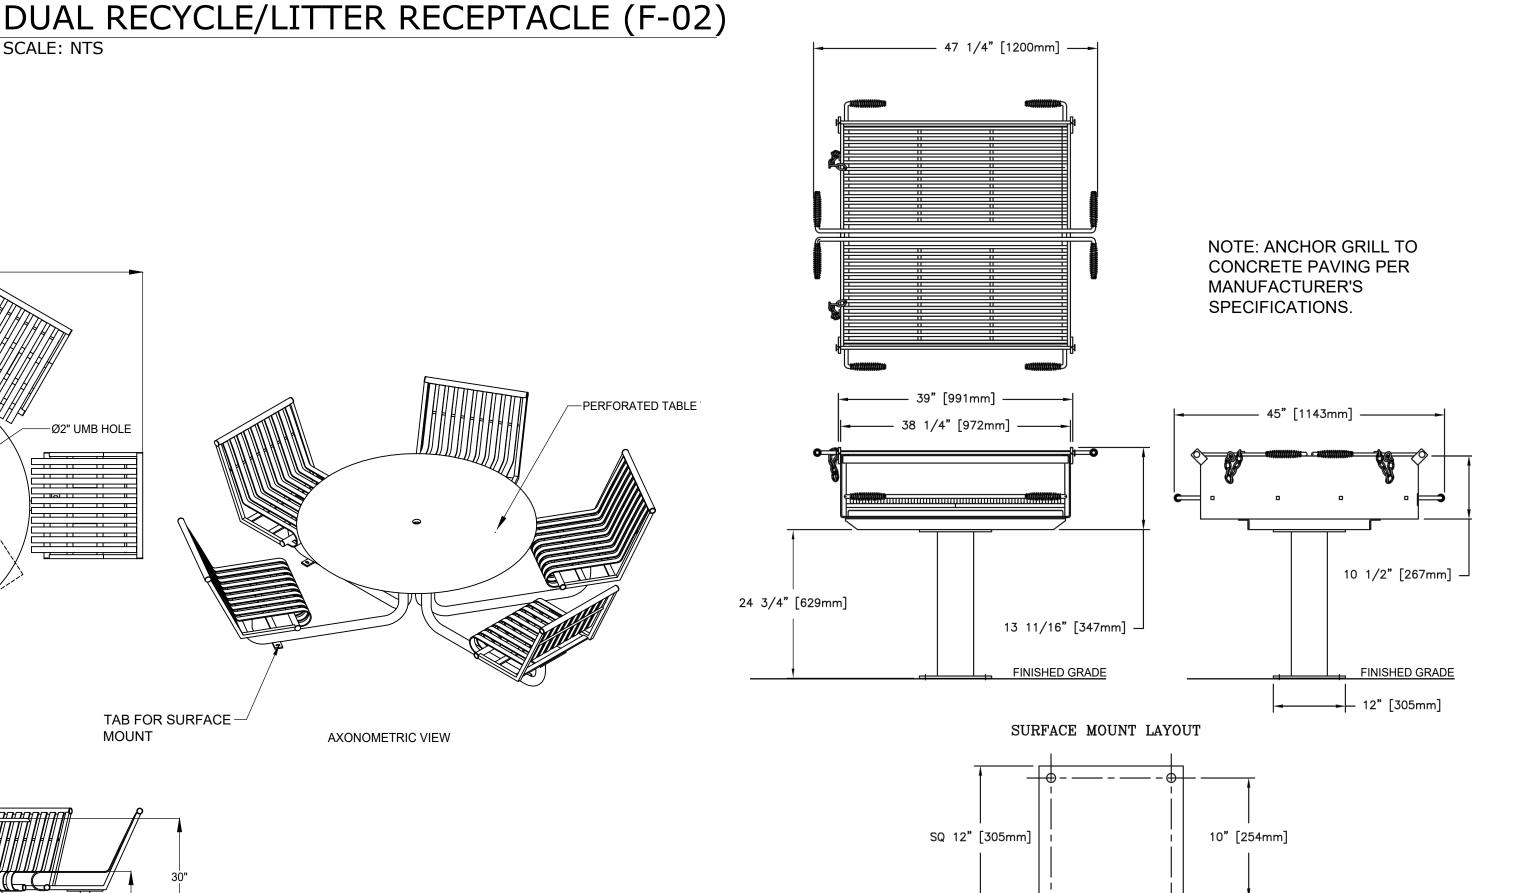

10" [253mm]

6 GROUP GRILL (F-07)
SCALE: NOT TO SCALE

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606 Liberty Avenue, Tel 412.203.3524 Fax 412-756-3080 Suite 226 Pittsburgh, PA 15222 **United States**



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revisions

project title

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HACP 200 Ross Street Pittsburgh,PA,15219

Client:

Allies & Ross Management and Development Corporation (ARMDC) 200 Ross Street Pittsburgh, PA 15219

Project Location:


Northview Heights Midrise 246 Penfort Street Pittsburgh, PA 15214

drawing title

Site Details

scale As Shown **Sheet No.**

December 3rd, 2023 L4.00 Project #2040

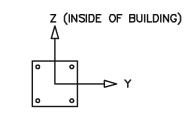

LOADS TO FOUNDATION (KIPS, IN-KIPS)	FOUNDATION LOADS						
LOAD COMBINATION	AXIAL (Fx)	SHEAR (Fy)	SHEAR (Fz)	MOMENT (My)	MOMENT (Mz)		
DL	0.78	0.00	0.06	-2.55	0.00		
SL	2.44	0.00	0.23	-9.69	0.00		
W-UPLIFT	-1.18	0.17	-0.20	11.87	13.34		
W-FY	-1.12	-0.22	-0.11	4.48	-17.64		
W-FZ	-1.18	-0.12	-0.28	19.11	-8.83		
E-FY	0.00	-0.19	0.00	0.00	-14.70		
E-Z	-0.11	0.00	-0.18	14.18	0.00		

THESE FOUNDATION LOADS ARE FOR ESTIMATING PURPOSE ONLY.
THE ACTUAL LOADS WILL BE DETERMINED IN THE FINAL ENGINEERING

NOTES:

- TABLE SHOWS UNFACTORED SERVICE LOADS

- A FOUNDATION DESIGN HAS NOT BEEN PERFORMED BY ICON SHELTER SYSTEMS INC.

MUST PERFORM A FOUNDATION DESIGN. (BY SHELTER MANUFACTURER). - THE STRUCTURE HAS BEEN ENGINEERED AS AN OPEN STRUCTURE.


- CONSULT ICON SHELTER SYSTEMS INC. IF THE STRUCTURE IS TO BE ENCLOSED.

- COORDINATES ARE LOCAL TO THE COLUMN

<u>DEFINITIONS:</u>
DL = SERVICE LEVEL DEAD LOAD REACTION WITH THE GREATEST AXIAL LOAD
SL = SERVICE LEVEL SNOW LOAD REACTION WITH THE GREATEST AXIAL LOAD
W-UL = SERVICE LEVEL WIND LOAD REACTION WITH THE GREATEST UPLIFT LOAD W-Y = SERVICE LEVEL WIND LOAD REACTION WITH THE GREATEST MAGNITUDE OF SHEAR IN THE LOCAL Y DIRECTION W-Z=SERVICE LEVEL WIND LOAD REACTION WITH THE GREATEST SHEAR VALUE ACTING IN THE SAME DIRECTION AS THE DL SHEAR LOAD


E-Y = SERVICE LEVEL SEISMIC LOAD REACTION WITH THE GREATEST MAGNITUDE OF

E-Z=SERVICE LEVEL SEISMIC LOAD REACTION WITH THE GREATEST MAGNITUDE OF SHEAR IN THE LOCAL Z DIRECTION

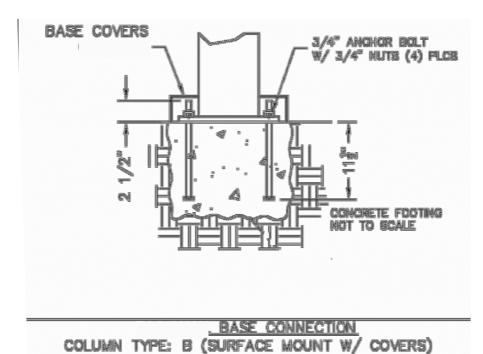

- 1. FIELD VERIFY CONDITIONS TO REFLECT
- 2. SHELTER MANUFACTURER TO PROVIDE STAMPED DRAWINGS PREPARED BY A FOUNDATION DESIGN.
- APPROVAL BY LANDSCAPE ARCHITECT PRIOR TO INSTALLATION.
- MANUFACTURER'S SPECIFICATIONS.
- 6. CONTRACTOR TO COORDINATE THE LOCATION
- REFER TO ELECTRICAL DRAWINGS FOR PAVILION LIGHTING. (SEE E010 FOR SCHEDULE).

- OPTIMAL LAYOUT SHOWN.
- PROVIDE ENGINEERED SHOP DRAWINGS FOR
- 4. ATTACH POSTS TO CONCRETE FOOTINGS PER
- 5. USE CONCRETE SPREAD FOOTINGS DUE TO
- GEOTHERMAL LOCATIONS IN THE AREA.
- OF THE ELECTRICAL WIRING WITH THE PAVILION FOOTING LOCATIONS.
- ELECTRICAL SITE PLAN AND E400 ELECTRICAL

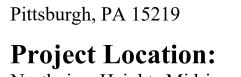

Allies & Ross Management and

Development Corporation (ARMDC)

Fukui Architects Pc

Pittsburgh, Pennsylvania 15219

SUBCONSULTANT

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Tel 412.203.3524

Fax 412-756-3080

general notes

revisions

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material required for finished assemblies.

including the copyright thereto.

codes and regulations.

205 Ross Street

Northview Heights Midrise 246 Penfort Street Pittsburgh, PA 15214

200 Ross Street

Owner:

Client:

200 Ross Street

Pittsburgh,PA,15219

drawing title

Site Details

PAVILION- ELEVATION & ANCHOR BOLT LAYOUT (F-09) SCALE: NOT TO SCALE

ELEVATION

ANCHOR BOLT LAYOUT

- GRADE

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1 - 800 - 242 - 1776


December 3rd, 2023

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scale As Shown

Sheet No.

L4.01 Project #2040

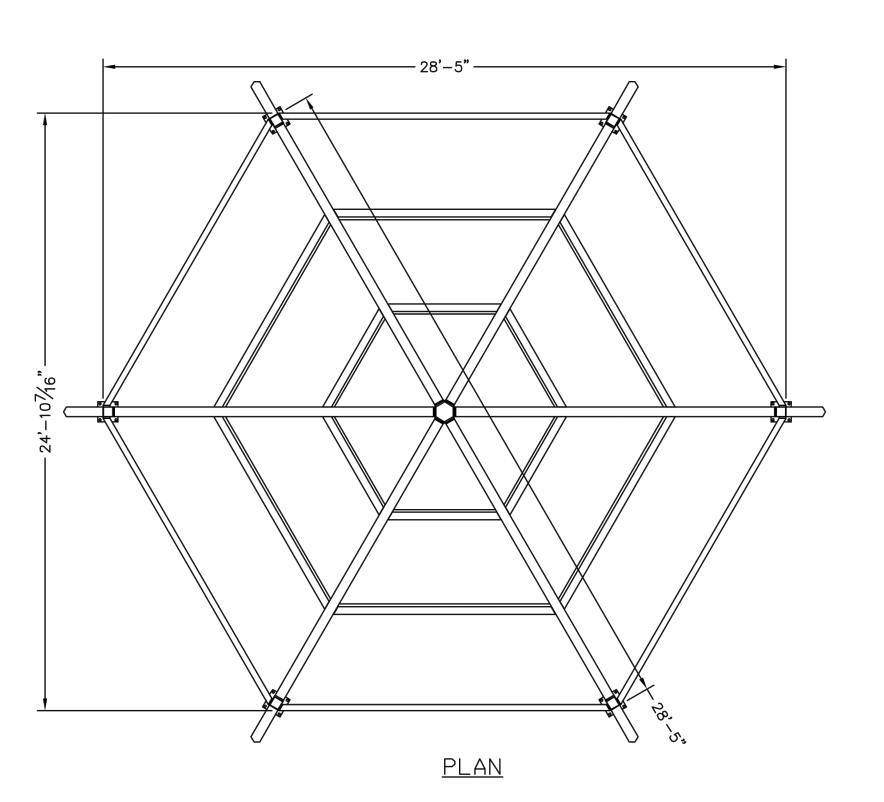

12" CENTER

TO CENTER

24ga MULTI RIB PANEL SECTION

ANCHOR BOLT LAYOUT

- 3/4" PAINTED SCREW

(1) ON EACH SIDE OF RIB

ALONG THE PURLIN

3/4" PAINTED SCREWS

(1) ON EACH SIDE OF RIB

ALONG TIE BEAM —

NOTE: STANDARD DETAILS SHOWN


ACTUAL BUILDING MAY VARY


FASTENERS

3/4" PAINTED SCREW 1 1/4" PAINTED SCREW

1 1/4" PAINTED SCREWS

(1) ON EACH SIDE OF RIB ALONG THE RAFTER

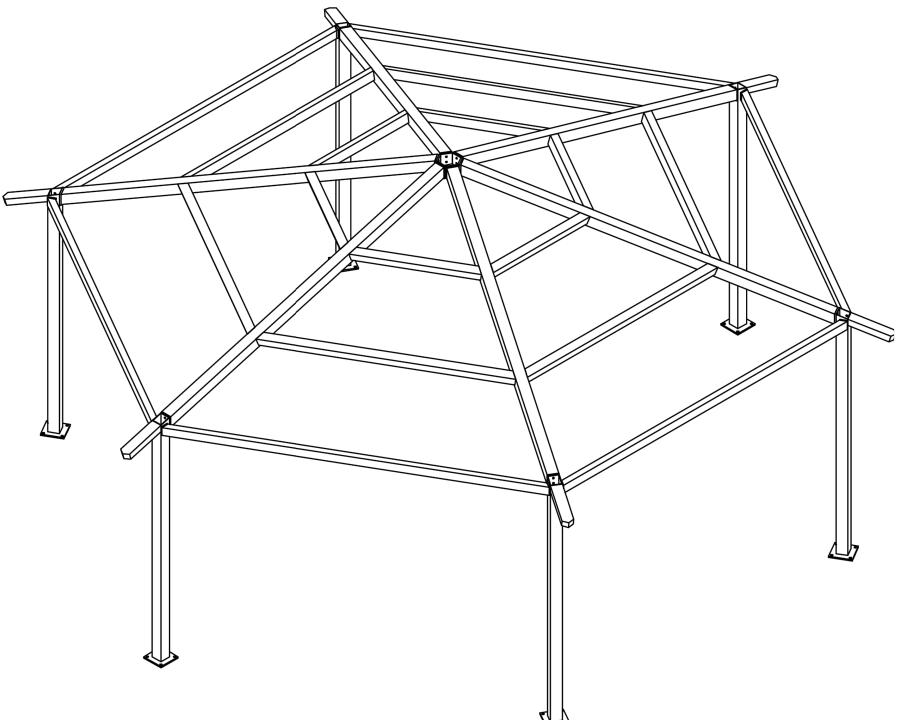

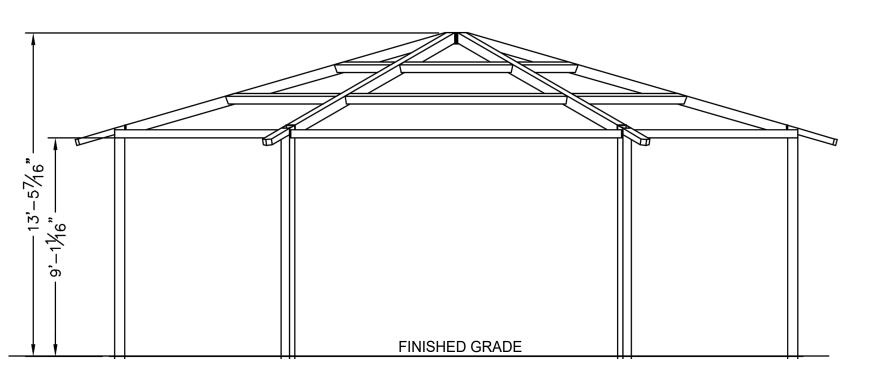


FRONT ELEVATION

<u>ISOMETRIC</u>

ALL STRUCTURAL COMPONETS WILL BE: TUBE: ASTM A500 GRADE B

PLATE: ASTM A36 BOLTS: ASTM A325 NUTS: ASTM A563 WELDING: GMAW

COLUMN SIZE: HSS5x5x0.1875

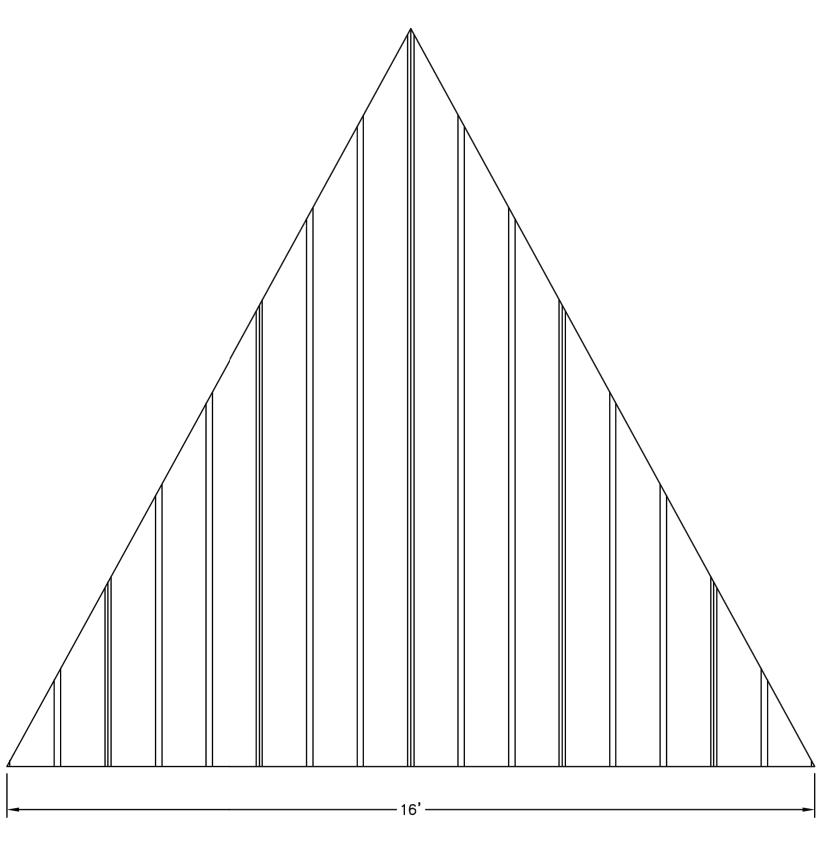

ROOF LAYOUT

- OPTIMAL LAYOUT SHOWN.
- 2. SHELTER MANUFACTURER TO PROVIDE STAMPED DRAWINGS PREPARED BY A
- PROVIDE ENGINEERED SHOP DRAWINGS FOR APPROVAL BY LANDSCAPE ARCHITECT PRIOR TO INSTALLATION.
- 4. ATTACH POSTS TO CONCRETE FOOTINGS PER
- 6. CONTRACTOR TO COORDINATE THE LOCATION
- PAVILION LIGHTING. (SEE E010 FOR ELECTRICAL SITE PLAN AND E400 ELECTRICAL SCHEDULE).

- 1. FIELD VERIFY CONDITIONS TO REFLECT
- LICENSED ENGINEER FOR THE STRUCTURE AND FOUNDATION DESIGN.
- MANUFACTURER'S SPECIFICATIONS.
- 5. USE CONCRETE SPREAD FOOTINGS DUE TO GEOTHERMAL LOCATIONS IN THE AREA.
- OF THE ELECTRICAL WIRING WITH THE PAVILION FOOTING LOCATIONS.
- 7. REFER TO ELECTRICAL DRAWINGS FOR

Fukui Architects Pc

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Pittsburgh, Pennsylvania 15219 ph 412.281.6001 fx 412.281.6002

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revisions

project title

Owner:

200 Ross Street

Pittsburgh,PA,15219

Client:

Allies & Ross Management and Development Corporation (ARMDC) 200 Ross Street Pittsburgh, PA 15219

Project Location: Northview Heights Midrise

246 Penfort Street Pittsburgh, PA 15214

drawing title

Site Details

STOP - CALL BEFORE YOU DIG! PENNSYLVANIA LAW REQUIRES THREE WORKING DAYS NOTICE PENNSYLVANIA ONE CALL SYSTEM, INC.


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scale As Shown Sheet No. December 3rd, 2023


59 | 233 |

L4.02 Project #2040


PAVILION -FRAME & ROOF LAYOUT (F-09) SCALE: NOT TO SCALE

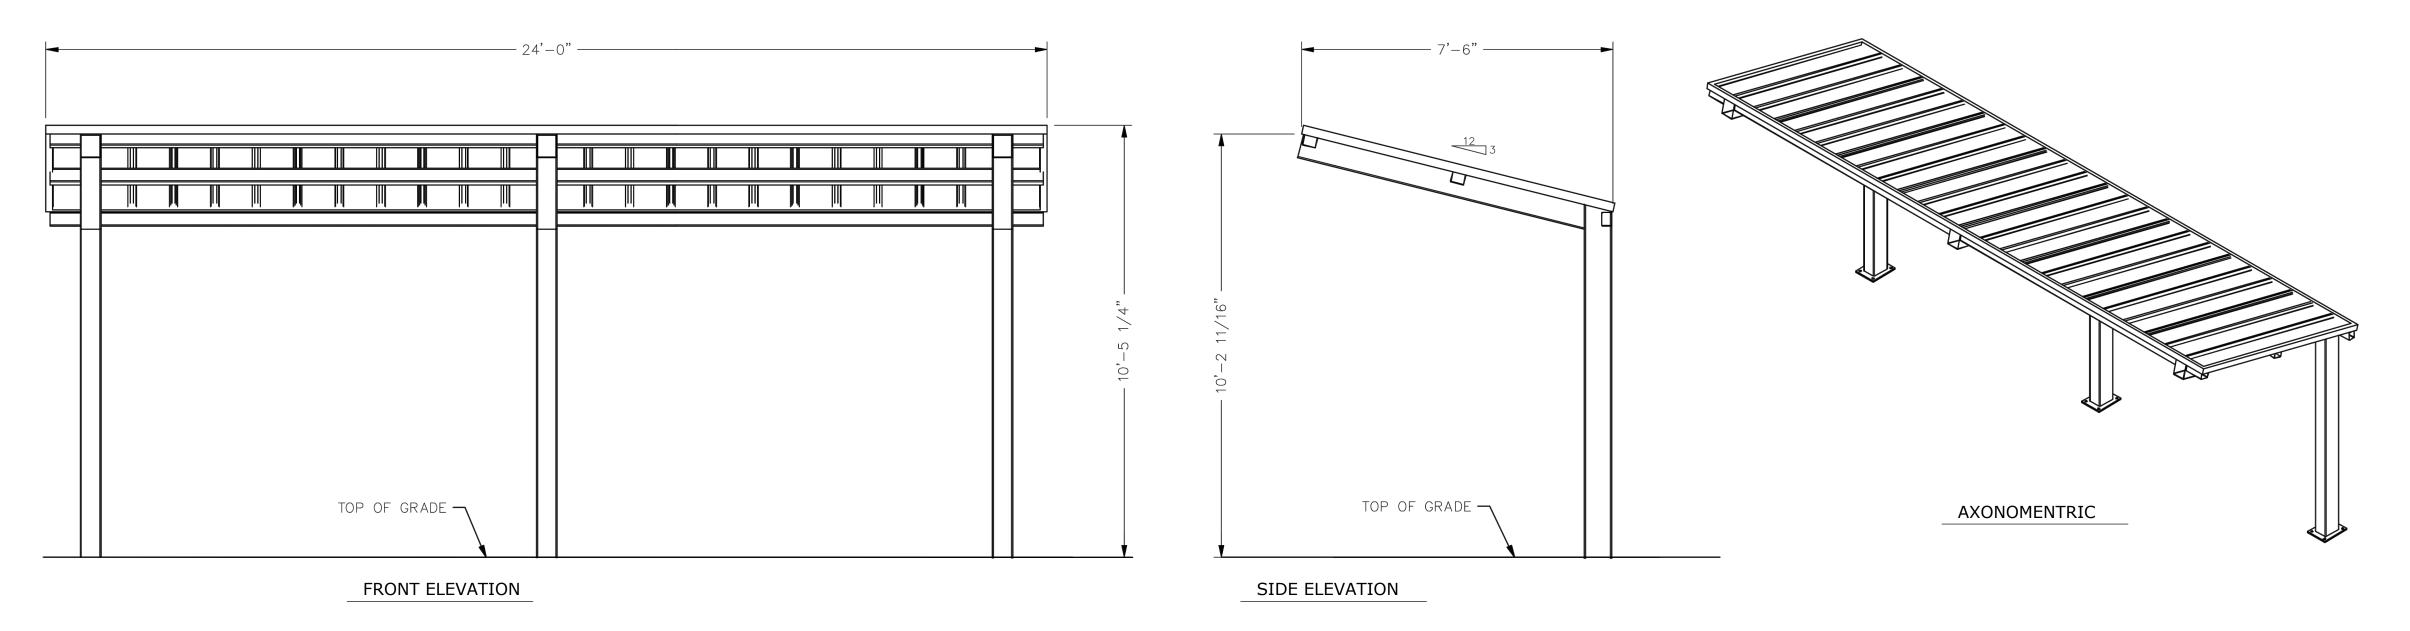

ELEVATIONS

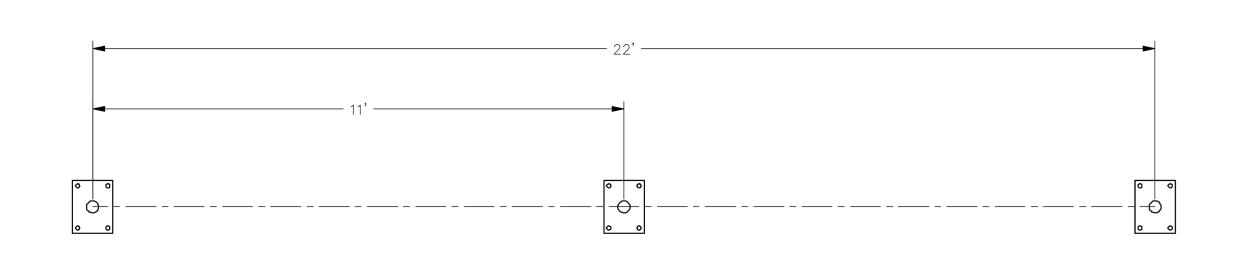


PLAN- ANCHOR BOLT LAYOUT

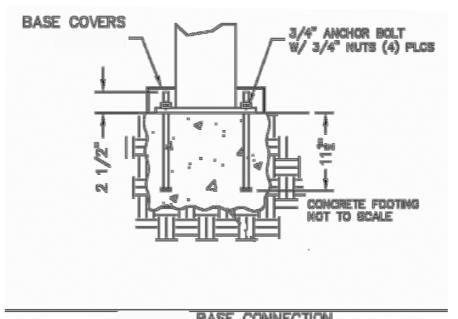

COLUMN TYPE: B (SURFACE MOUNT W/ COVERS)

- 1. FIELD VERIFY CONDITIONS TO REFLECT OPTIMAL LAYOUT SHOWN.
- 2. SHELTER MANUFACTURER TO PROVIDE STAMPED DRAWINGS PREPARED BY A LICENSED ENGINEER FOR THE STRUCTURE AND FOUNDATION DESIGN.
- PROVIDE ENGINEERED SHOP DRAWINGS FOR APPROVAL BY LANDSCAPE ARCHITECT PRIOR TO INSTALLATION.
- 4. ATTACH POSTS TO CONCRETE FOOTINGS PER MANUFACTURER'S SPECIFICATIONS.

ANCHOR BOLT LAYOUT

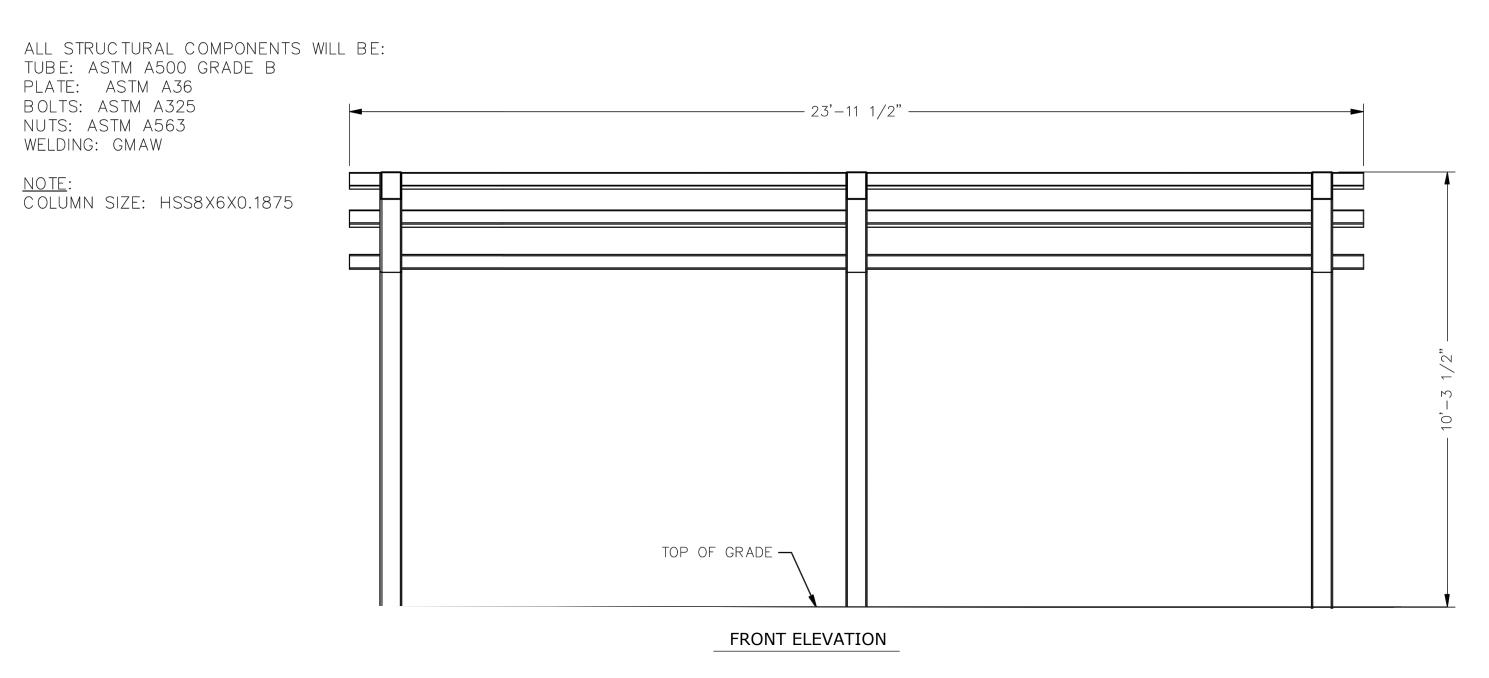

______ 7'-6 15/16" ____ AXONOMENTRIC TOP OF GRADE -SIDE ELEVATION

project title

Fukui Architects Pc

Pittsburgh, Pennsylvania 15219

SUBCONSULTANT

606 Liberty Avenue,

Pittsburgh, PA 15222 **United States**

Suite 226

ph 412.281.6001 fx 412.281.6002

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Tel 412.203.3524

Fax 412-756-3080

general notes

revisions

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including the copyright thereto.

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205 Ross Street

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Project Location:

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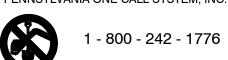
drawing title

Site Details

FRAME


1 COVERED BIKE SHELTER (F-10)
SCALE: NOT TO SCALE


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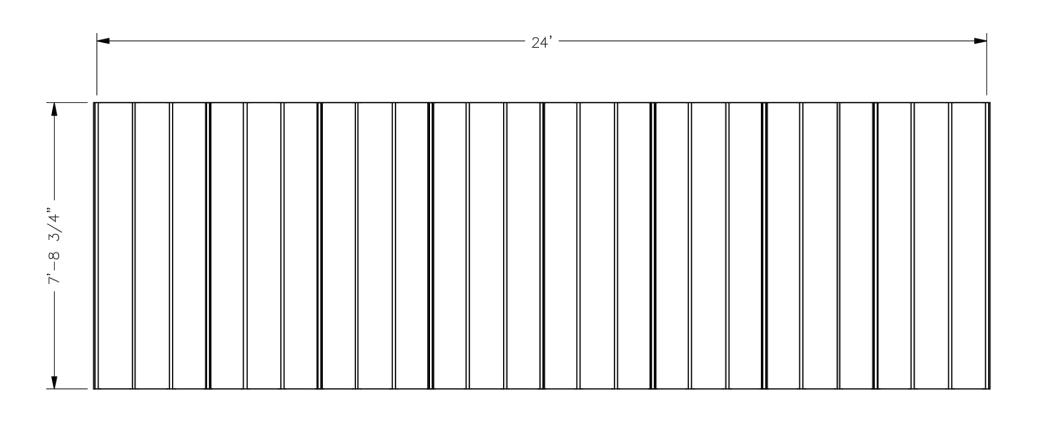
scale As Shown Sheet No. December 3rd, 2023

L4.03 60 | 233 | Project #2040



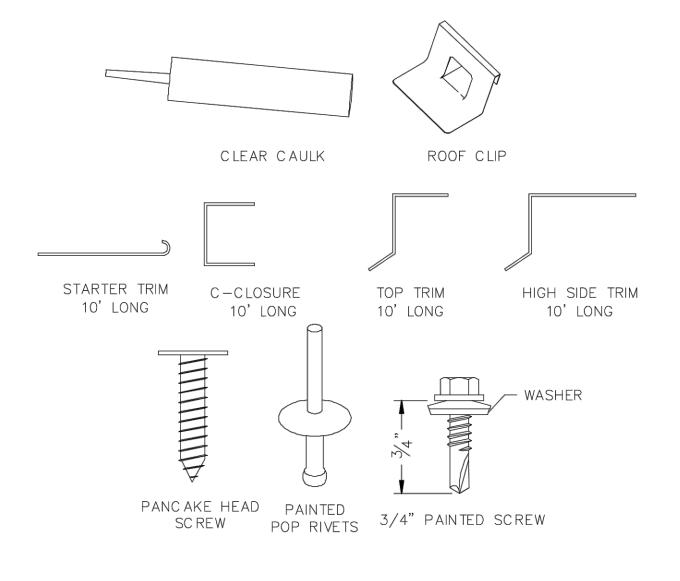


- 1. FIELD VERIFY CONDITIONS TO REFLECT OPTIMAL LAYOUT SHOWN.
- 2. SHELTER MANUFACTURER TO PROVIDE STAMPED DRAWINGS PREPARED BY A LICENSED ENGINEER FOR THE STRUCTURE AND FOUNDATION DESIGN.
- PROVIDE ENGINEERED SHOP DRAWINGS FOR APPROVAL BY LANDSCAPE ARCHITECT PRIOR TO INSTALLATION.
- 4. EMBED POSTS IN CONCRETE FOOTINGS PER MANUFACTURER'S SPECIFICATIONS.

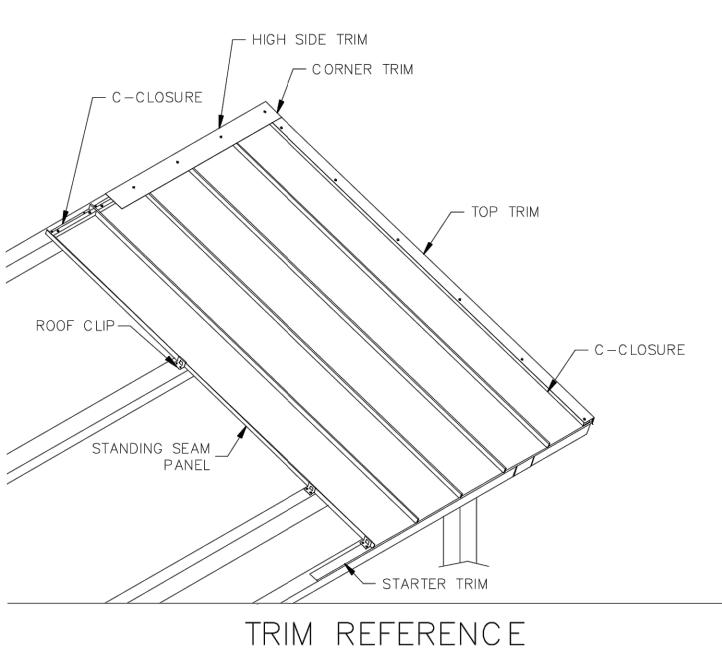

MULTI- RIB ROOF LAYOUT


COVERED BIKE SHELTER - ROOF LAYOUT (F-10) SCALE: NOT TO SCALE

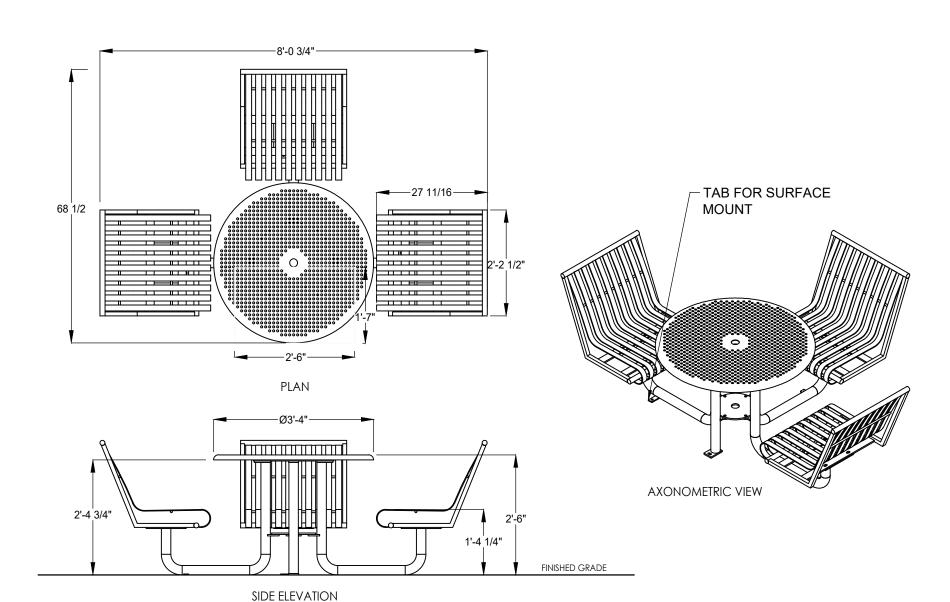


- REFER TO L1.00 FOR SITE FURNISHING SCHEDULE.
- 2. VERIFY LAYOUT OF LANDSCAPE ELEMENTS WITH LANDSCAPE ARCHITECT PRIOR TO COMMENCEMENT OF WORK AND ADJUST AS REQUIRED.
- 3. SURFACED MOUNTED FURNISHINGS REQUIRE STAINLESS STEEL ANCHOR BOLTS (NOT PROVIDED).
- 4. SURFACE MOUNT TO CONCRETE PAVING. REFER TO CIVIL DRAWINGS FOR CONCRETE DETAIL.
- 5. INSTALL PER MANUFACTURER'S SPECIFICATIONS.

NOTES:


- 1. REFER TO L1.00, SITE FURNISHING SCHEDULE, FOR PLANTER TYPES.
- 2. TYPICAL PLANTER LAYOUT SHOWN.
- 3. VERIFY LAYOUT OF LANDSCAPE ELEMENTS WITH LANDSCAPE ARCHITECT PRIOR TO COMMENCEMENT OF WORK AND ADJUST AS REQUIRED.
- 4. SURFACED MOUNTED FURNISHINGS REQUIRE STAINLESS
- STEEL ANCHOR BOLTS (NOT PROVIDED).
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- 6. INSTALL PER MANUFACTURER'S SPECIFICATIONS.

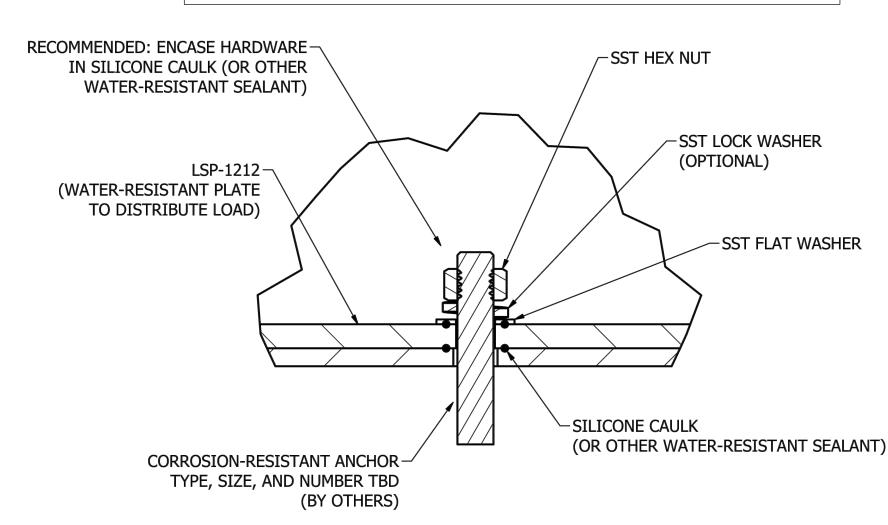


DETAIL

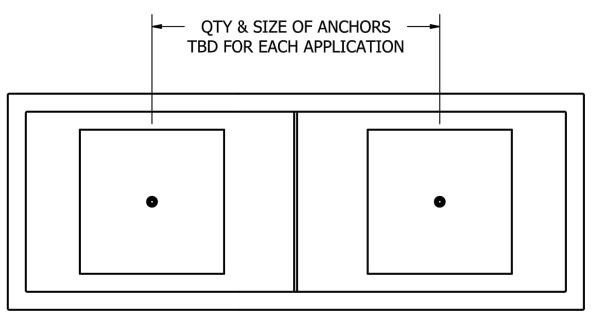

PLAN

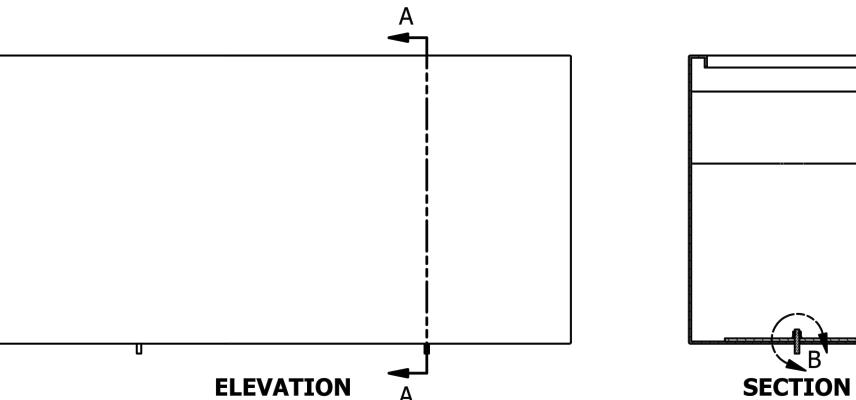

PLANTER- TYPICAL ANCHORING SCALE: NOT TO SCALE

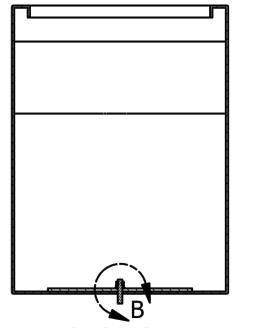

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Fukui Architects Pc

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drawing title


Site Details

scale As Shown **Sheet No.**


December 3rd, 2023 L4.04 **61** Project #2040

3 SEAT DINING TABLE (ADA ACCESSIBLE) (F-09) 2 SCALE: NOT TO SCALE

- BASIS OF DESIGN PRODUCT: AMERISTAR "ECHELON PLUS" COMMERCIAL ORNAMENTAL ALUMINUM FENCE WITH FULLY RAKEABLE PANELS. REFER TO SPECIFICATIONS.
- 2. POST SIZE AND GAUGE DEPENDS ON FENCE HEIGHT AND WIND LOADS. SEE ECHELON PLUS™ SPECIFICATIONS FOR POST SIZING CHART.
- 3. VALUES SHOWN ARE NOMINAL AND NOT TO BE USED FOR INSTALLATION PURPOSES. SEE PRODUCT SPECIFICATION FOR INSTALLATION REQUIREMENTS.
- 4. FIELD VERIFY CONDITIONS TO REFLECT OPTIMAL LAYOUT
- 5. PROVIDE SHOP DRAWINGS FOR APPROVAL BY LANDSCAPE ARCHITECT PRIOR TO INSTALLATION.
- 6. EMBED POSTS IN CONCRETE FOOTINGS PER
- MANUFACTURER'S SPECIFICATIONS.
- 7. REFER TO SPECIFICATIONS FOR POST, PICKET AND

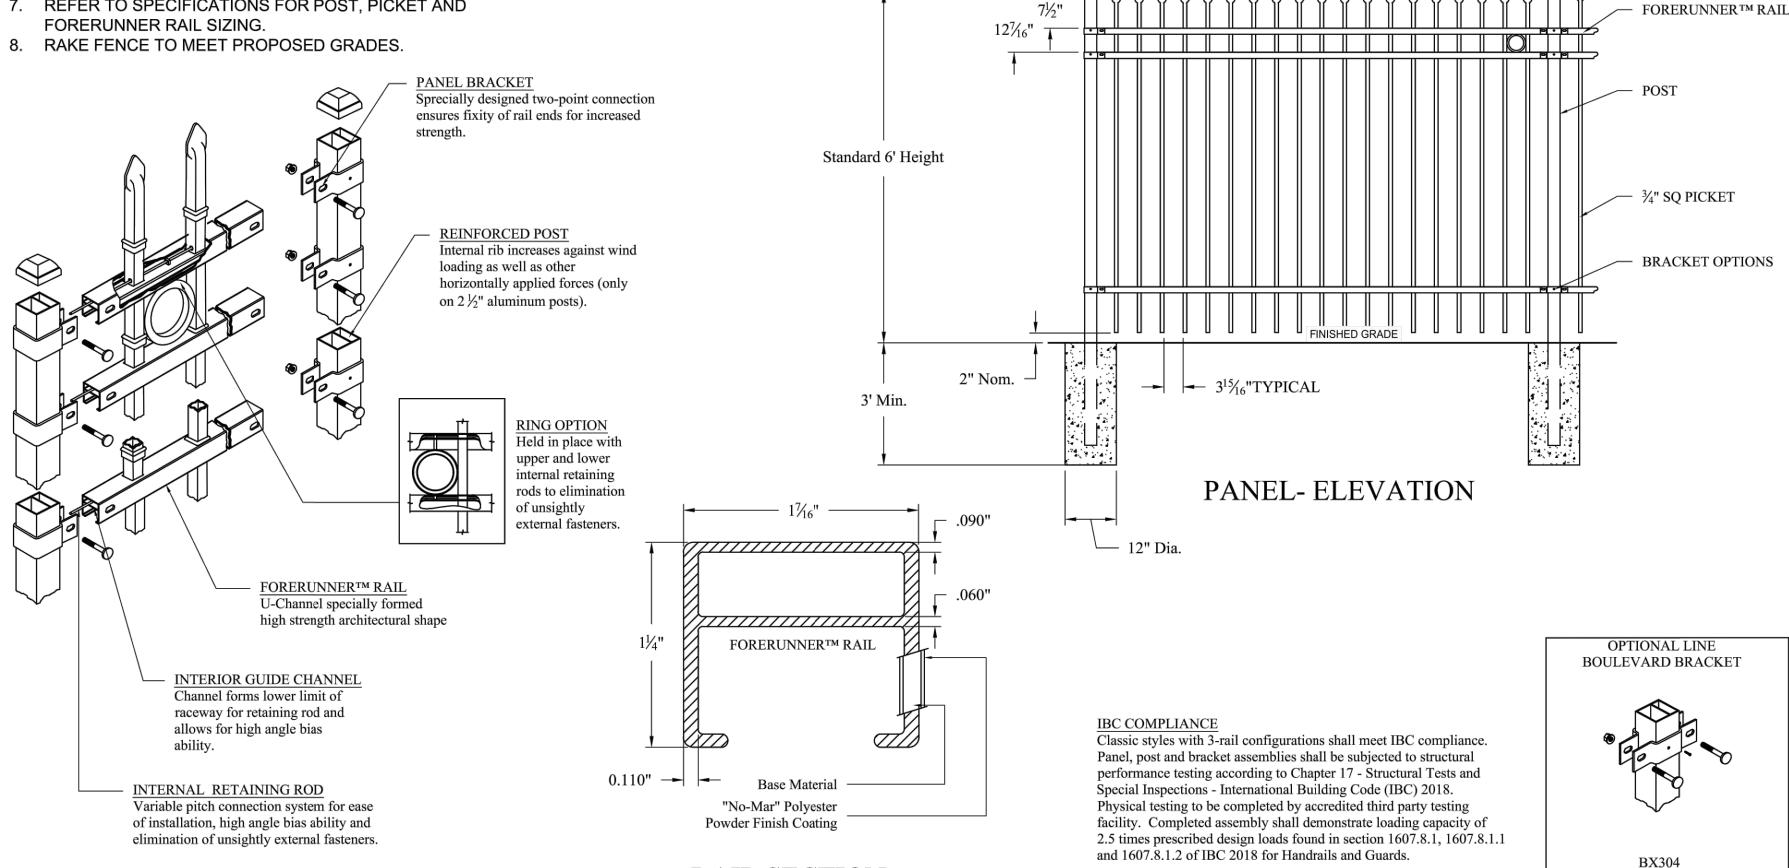

ORNAMENTAL FENCE SCALE: NOT TO SCALE

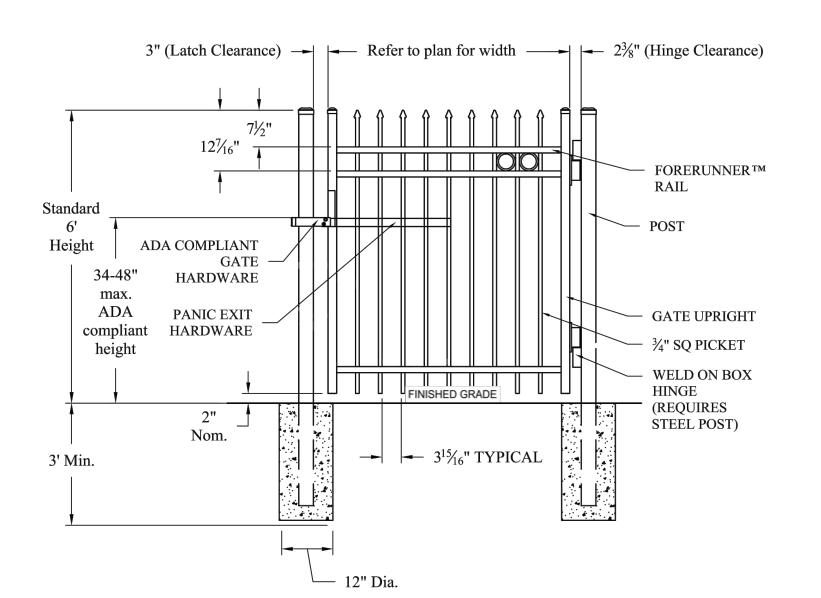

NOTES:

RAIL SECTION


1. BASIS OF DESIGN PRODUCT: AMERISTAR "ECHELON PLUS" COMMERCIAL ORNAMENTAL ALUMINUM GATE TO MATCH FENCE WITH SOFT CLOSURE HINGES AND ADA COMPLIANT HARDWARE. REFER TO SPECIFICATIONS.

8' O.C. Nom.

- 2. POST SIZE AND GAUGE DEPENDS ON FENCE HEIGHT AND WIND LOADS. SEE ECHELON PLUS™ SPECIFICATIONS FOR POST SIZING CHART
- 3. VALUES SHOWN ARE NOMINAL AND NOT TO BE USED FOR INSTALLATION PURPOSES. SEE PRODUCT SPECIFICATION FOR INSTALLATION REQUIREMENTS.
- 4. FIELD VERIFY CONDITIONS TO REFLECT OPTIMAL LAYOUT
- 5. PROVIDE SHOP DRAWINGS FOR APPROVAL BY LANDSCAPE ARCHITECT PRIOR TO INSTALLATION.
- 6. EMBED POSTS IN CONCRETE FOOTINGS PER
- MANUFACTURER'S SPECIFICATIONS.
- REFER TO SPECIFICATIONS FOR POST, PICKET AND FORERUNNER RAIL SIZING.


NOTES:

- REFER TO L1.00 FOR SITE FURNISHING SCHEDULE.
- 2. VERIFY LAYOUT OF LANDSCAPE ELEMENTS WITH LANDSCAPE ARCHITECT PRIOR TO COMMENCEMENT OF WORK AND ADJUST AS REQUIRED.
- 3. SURFACED MOUNTED FURNISHINGS REQUIRE STAINLESS STEEL ANCHOR BOLTS (NOT PROVIDED).
- SURFACE MOUNT TO CONCRETE PAVING. REFER TO CIVIL DRAWINGS FOR CONCRETE DETAIL.
- 5. INSTALL PER MANUFACTURER'S SPECIFICATIONS

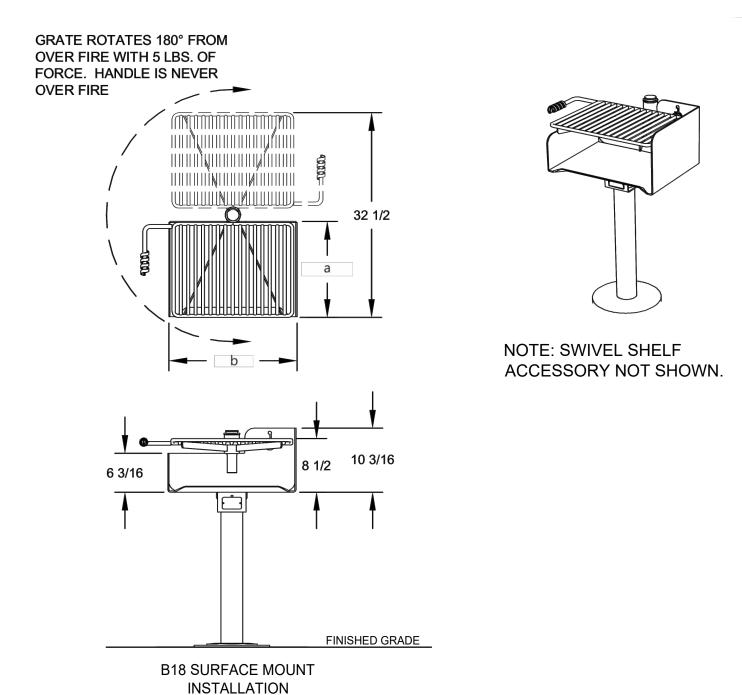


MODEL	DIMENSION					
NUMBER	a	b				
ASW-20	15-1/8	19-3/8				

ACCESSIBLE GRILL (F-10) SCALE: NOT TO SCALE

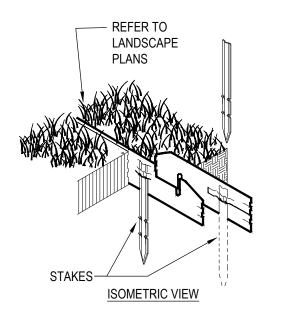

1. CLEANLINE 3/16" X 4", 0.072" THICK ALUMINUM EDGING WITH 0.135" EXPOSED TOP LIP, WITH NATURAL ALUMINUM MILL FINISH.

- 2. INSTALL PER MANUFACTURER'S "INSTALLATION
- GUIDELINES". 3. 16'-0" SECTIONS TO INCLUDE (5) 12" ALUMINUM STAKES. 4. CORNERS - CUT BASE EDGING UP HALFWAY AND FOR A CONTINUOUS CORNER.
- 5. PERMALOC CLEANLINE AS MANUFACTURED BY PERMALOC CORPORATION. WWW.PERMALOC.COM OR APPROVED EQUIVALENT

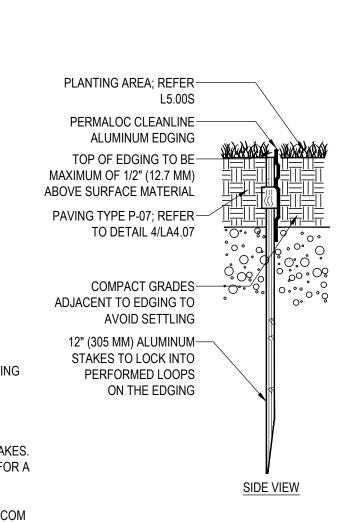

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United States



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general notes

seal

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- 2. Contractor shall verify all dimensions and existing conditions in the field and shall advise Fukui Architects, Pc of any discrepancies between, additions to, deletions from, or alterations to any and all conditions prior to proceeding with any phase of work. Do not scale
- 3. All work shall be installed in accordance with applicable codes and regulations. **4.** Contractor shall be responsible for the patching, repairing,
- and preparations of all existing floor, wall, and ceiling surfaces as required to receive scheduled finishes.
- 5. All items shown on drawings are finished construction assemblies. Contractor shall provide and install all material required for finished assemblies.
- **6.** All reports, plans, specifications, computer files, field data, notices, and other documents and instruments prepared by the Architect as instruments of service shall remain the property of the Architect. The Architect shall retain all common law statutory, and other reserved rights, including the copyright thereto.

revisions

project title

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HACP 200 Ross Street Pittsburgh,PA,15219

Client:

Allies & Ross Management and Development Corporation (ARMDC) 200 Ross Street Pittsburgh, PA 15219

Project Location:

Northview Heights Midrise 246 Penfort Street Pittsburgh, PA 15214

drawing title

Site Details

Sheet No. As Shown

December 3rd, 2023 L4.05 Project #2040

ORNAMENTAL FENCE GATE SCALE: NOT TO SCALE

METAL EDGING SCALE: NOT TO SCALE

Tree Schedule

TREE SCHEDULE								
QUANTITY	BOTANICAL NAME	COMMON NAME	SIZE (MIN.)	CONDITION	TOTAL CALIPER INCHES	NOTES		
10	ACER RUBRUM 'BRANDYWINE'	BRANDYWINE RED MAPLE	2 1/2" CAL.	B&B	25	MATCHING SPECIMENS		
10	ACER SACCHARUM	SUGAR MAPLE	3" CAL	B&B	30			
9	AMELANCHIER CANADENSIS	SHADBLOW SERVICEBERRY	7'-8' HT (2" CAL)	B&B	18	CLUMP, MULTI-TRUNK, CALIPER LISTED INDICATES SUM OF INDIVIDUAL TRUNK CALIPERS		
11	AMELANCHIER X GRANDIFLORA 'AUTUMN BRILLIANCE'	AUTUMN BRILLIANCE SERVICEBERRY	7'-8' HT (2" CAL)	B&B	22	SINGLE TRUNK		
8	CERCIS CANADENSIS	EASTERN REDBUD	2- 21/2" CAL	B&B	16	SINGLE TRUNK		
7	CLADRASTIS KENTUKEA	YELLOWWOOD	2 1/2"-3" CAL	B&B	14			
13	CORNUS X RUTGAN	STELLAR PINK DOGWOOD	2- 21/2" CAL	B&B	26	SINGLE TRUNK, MATCHING SPECIMENS		
23	NYSSA SYLVATICA	BLACK TUPELO	3" CAL.	B&B	69			
6	PICEA GLAUCA	WHITE SPRUCE	10'-12' HT	B&B	15	10'-12' HEIGHT (CALIPER CALCULATIONS ARE BASED ON A 2 1/2" CALIPER TREE)		
6	PLATANUS X ACERIFOLIA 'EXCLAMATION'	EXCLAMATION LONDON PLANETREE	3" - 3 1/2" CAL.	B&B	18	MATCHING SPECIMENS, STREET TREE		
8	QUERCUS COCCINEA	SCARLET OAK	3" CAL.	B&B	24			
10	ULMUS AMERICANA 'LEWIS & CLARK' PRAIRIE EXPEDITION	PRAIRIE EXPEDITION AMERICAN ELM	2 1/2" CAL.	B&B	25			
6	ULMUS 'FRONTIER'	FRONTIER ELM	2 1/2" CAL.	B&B	15	MATCHING SPECIMENS		
TOTAL CALIPER	INCHES			317	TOTAL OF PROPOSED TREE PLANTINGS			

NOTE: QUANTITIES SHOWN FOR CONTRACTOR CONVENIENCE ONLY. CONTRACTOR TO VERIFY ALL QUANTITIES FOR PLANTING AREAS. B&B = BALLED & BURLAPPED, CONT= CONTAINER, O.C.= ON CENTER SPACING

NOTE: PLANT SCHEDULES SHOWN ARE COMPRISED OF NATIVE AND APPROPRIATE PLANT SPECIES THAT ARE ADAPTED TO THE SITE CONDITIONS, CLIMATE AND DESIGN INTENT.

GENERAL PLANTING NOTES

- 1. COORDINATE PLANTINGS WITH EXISTING AND PROPOSED UTILITY LOCATIONS AND NOTIFY OWNER'S REPRESENTATIVE OF ANY UTILITIES OR FEATURES THAT INTERFERE WITH PROPOSED IMPROVEMENTS.
- 2. UTILIZE ONLY PLANTS GROWN IN THE SAME USDA PLANTING ZONES (PER THE USDA PLANT HARDINESS MAP) AS THOSE OF THE PROJECT SITE.
- 3. ALL PLANTS SHALL BE FURNISHED AND INSTALLED IN STRICT ACCORDANCE WITH THE "AMERICAN STANDARD FOR NURSERY STOCK". ANSI 260.1, AS PUBLISHED AND APPROVED BY THE AMERICAN ASSOCIATION OF NURSERYMEN.
- 4. ALL PLANTS TO BE STAKED IN THE FIELD BY CONTRACTOR FOR APPROVAL OF OWNER'S REPRESENTATIVE PRIOR TO PLANTING INSTALLATION.
- 5. CONTRACTOR SHALL INSTALL ALL PLANT MATERIALS IN LOCATIONS AND TO DEPTHS AS SHOWN ON PLAN OR ON DETAILS.
- 6. PROVIDE MULCH RING AROUND INDIVIDUAL TREES (BOTH EXISTING AND PROPOSED). 4' MINIMUM MULCH RING AT SHADE/CANOPY TREES. 3' MUCH RING - AT ORNAMENTAL/FLOWERING TREES.
- 7. REFER TO SPECIFICATIONS FOR MULCH.
- 8. NOTIFY OWNER'S REPRESENTATIVE OF ANY DISCREPANCY BETWEEN THE PLANT SCHEDULE AND PLAN PRIOR TO ORDERING PLANT 9. ALL PLANT MATERIAL SHALL BE GUARANTEED FOR A PERIOD OF ONE CALENDAR YEAR AFTER WRITTEN NOTICE OF ACCEPTANCE OF
- ALL PLANTING WORK. 10. NO SUBSTITUTIONS FOR PLANT SPECIES AND VARIETIES WILL PERMITTED WITH OUT APPROVAL BY OWNER'S REPRESENTATIVE.
- 11. SHOULD THERE BE A DISCREPANCY BETWEEN THE PLANT SCHEDULES AND THE PLANTING PLAN, THE FOLLOWING GOVERNS:
 - A. NUMBER OF PLANT MATERIAL- PLANTING PLAN GOVERNS
 - B. SIZE OF PLANTS LARGEST SIZE GOVERNS
 - C. TYPE OF PLANT MATERIAL AS DIRECTED BY THE OWNER'S REPRESENTATIVE.

TOPSOIL:

- 12. TOPSOIL SHALL BE SUPPLIED BY THE CONTRACTOR. TOPSOIL MUST BE TESTED ACCORDING TO SPECIFICATIONS PRIOR TO ITS USE. TOPSOIL TEST RESULTS AND AMENDMENT RECOMMENDATIONS SHALL BE PROVIDED BY THE CONTRACTOR TO THE LANDSCAPE ARCHITECT PRIOR TO INSTALLATION.
- 13. TOPSOIL SHALL BE 4 INCHES IN LAWN AREAS AND 12 INCHES IN PLANTING BEDS. REFER TO L2.01.

Shrub Schedule

SHRUB SCHEDULE									
QUANTITY	CODE	BOTANICAL NAME	COMMON NAME	SIZE (MIN.)	CONDITION	NOTES			
107	САН	CLETHRA ALNIFOLIA 'HUMMINGBIRD'	HUMMINGBIRD SUMMERSWEET	2-3' HT.	#3 CONT.	FULL AND BUSHY TO GROUND			
33	csc	CORNUS SERICEA 'CARDINAL'	RED TWIG DOGWOOD	42" HT.	#7 CONT.	FULL AND BUSHY TO GROUND, PARKING LOT BUFFER (DENSE TWIGGY STRUCTURE)			
44	CSF	CORNUS STOLONIFERA 'FARROW'	ARCTIC FIRE RED TWIG DOGWOOD	2-3' HT.	#3 CONT.	FULL AND BUSHY TO GROUND			
36	FGM	FOTHERGILLA GARDENII 'MT. AIRY'	MT. AIRY DWARF FOTHERGILLA	42" HT.	#7 CONT.	FULL AND BUSHY TO GROUND, PARKING LOT			
25	FMB	FOTHERGILLA MAJOR 'BLUE SHADOW'	BLUE SHADOW FOTHERGILLA	2-3' HT.	#3 CONT.	FULL AND BUSHY TO GROUND			
16	HPL	HYDRANGEA PANICULATA 'LIMELIGHT'	LIMELIGHT HARDY HYDRANGEA	2-3' HT.	#3 CONT.	FULL AND BUSHY TO GROUND			
170	IG	ILEX GLABRA	INKBERRY HOLLY	42" HT.	#7 CONT.	FULL AND BUSHY TO GROUND, PARKING LOT BUFFER (EVERGREEN)			
103	IGC	ILEX GLABRA 'CHAMZIN'	NORDIC INKBERRY HOLLY	18"-24" HT.	#3 CONT.	FULL AND BUSHY TO GROUND			
4	IVJ	ILEX VERTICILLATA 'JIM DANDY'	JIM DANDY WINTERBERRY	2-3' HT.	#3 CONT.	FULL AND BUSHY TO GROUND, 1 MALE PLANT PER EVERY 9 FEMALE RED SPRITE OR BERRY HEAVY PLANT			
28	IVN	ILEX VERTICILLATA NANA 'RED SPRITE'	RED SPRITE WINTERBERRY	2-3' HT.	#3 CONT.	FULL AND BUSHY TO GROUND			

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2) B&B = BALLED & BURLAPPED, CONT= CONTAINER, O.C.= ON CENTER SPACING, GAL=GALLON

3) REFER TO L5.00s FOR SHRUB LAYOUT/SPACING.

Perennials, Groundcovers, & Grasses Schedule

QUANTITY	CODE	BOTANICAL NAME	COMMON NAME	SIZE (MIN.)	CONDITION	NOTES
282	АМ	ACHILLEA X MOONSHINE	MOONSHINE YARROW	#1 CONT.	CLUMP	SPACING 18" O.C.
151	CAK	CALAMAGROSTIS X ACUTIFLORA 'KARL FOERSTER'	FEATHER REED GRASS	#2 CONT	CLUMP	SPACING AS SHOWN PLAN
478	EPP	ECHINACEA PURPUREA 'POW WOW WILD BERRY'	WILD BERRY PURPLE CONEFLOWER	#1 CONT.	CLUMP	SPACING 18" O.C.
137	HPP	HEUCHERA X 'PLUM PUDDING'	PLUM PUDDING CORAL BELLS	#1 CONT.	CLUMP	SPACING 18" O.C.
1386	LM	LIRIOPE MUSCARI 'BIG BLUE'	BIG BLUE LILY TURF	#2 CONT.	CONT.	SPACING 12" O.C.
110 MC MUHLENBERGIA CAPILLARIS PINK MUHLY GRASS #2 CON		#2 CONT	CLUMP	SPACING AS SHOWN PLAN		
96 PVN		PANICUM VIRGATUM 'NORTHWIND'	NORTHWIND SWITCHGRASS	2-3' HT.	CONT.	SPACING AS SHOWN PLAN
236 PAL PEROVSKIA ATRIPLICIFOLIA LITTLE SPIRE RUSSIAN SAGE		#2 CONT	CLUMP	SPACING 18" O.C.		
57 RAG RHUS AROMATICA 'GRO-LOW'		RHUS AROMATICA 'GRO-LOW'	GRO-LOW SUMAC	#1 CONT.	CLUMP	12"-15" HT., SPACING 48" O.C.
295 SSA SEDUM SPECTABI 'AUTUMN JOY'		SEDUM SPECTABILE 'AUTUMN JOY'	AUTUMN JOY STONE CROP #1 CONT.		CLUMP	SPACING 18" O.C.
			SEED MIXES			
N/A	N/A	LAWN SEED	REFER TO SPECIFICATIONS	N/A	N/A	N/A
N/A	N/A	LOW-MOW FESCUE SEED MIX	REFER TO SPECIFICATIONS	N/A	N/A	N/A
N/A	N/A	SLOPE SEED MIX	REFER TO SPECIFICATIONS	N/A	N/A	N/A
N/A	N/A	DETENTION BASIN SEED MIX	REFER TO SPECIFICATIONS	N/A	N/A	N/A

QUANTITIES SHOWN FOR CONTRACTOR CONVENIENCE ONLY. CONTRACTOR TO VERIFY ALL QUANTITIES FOR PLANTING AREAS. B&B = BALLED & BURLAPPED, CONT= CONTAINER, O.C.= ON CENTER SPACING

GRASSES, GROUNDCOVERS AND PERENNIALS UTILIZE TRIANGULAR SPACING. REFER TO PLANS FOR HATCHED AREAS.

Fukui Architects Pc

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Fax 412-756-3080

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drawing title

Planting Schedules & Notes


n/a December 3rd, 2023


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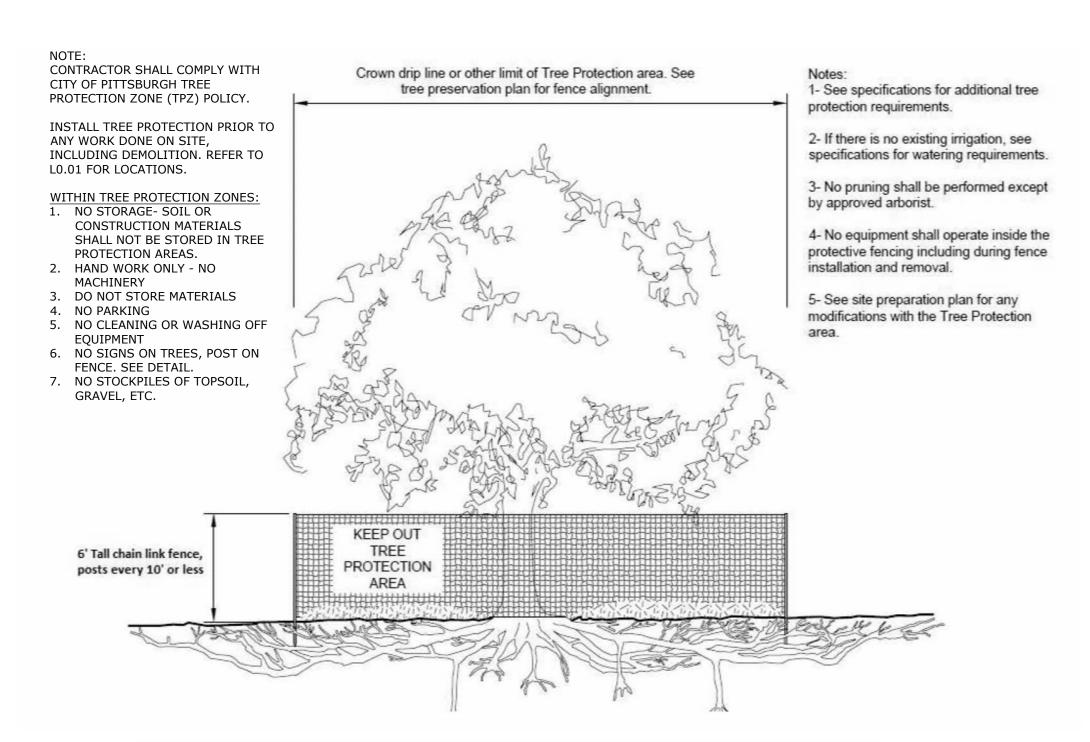
Project #2040

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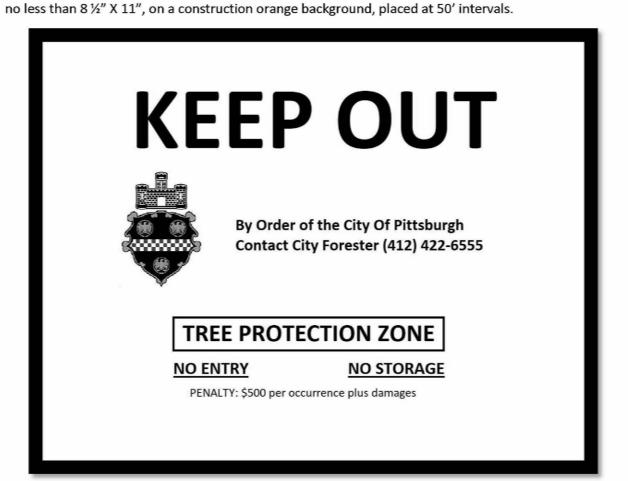
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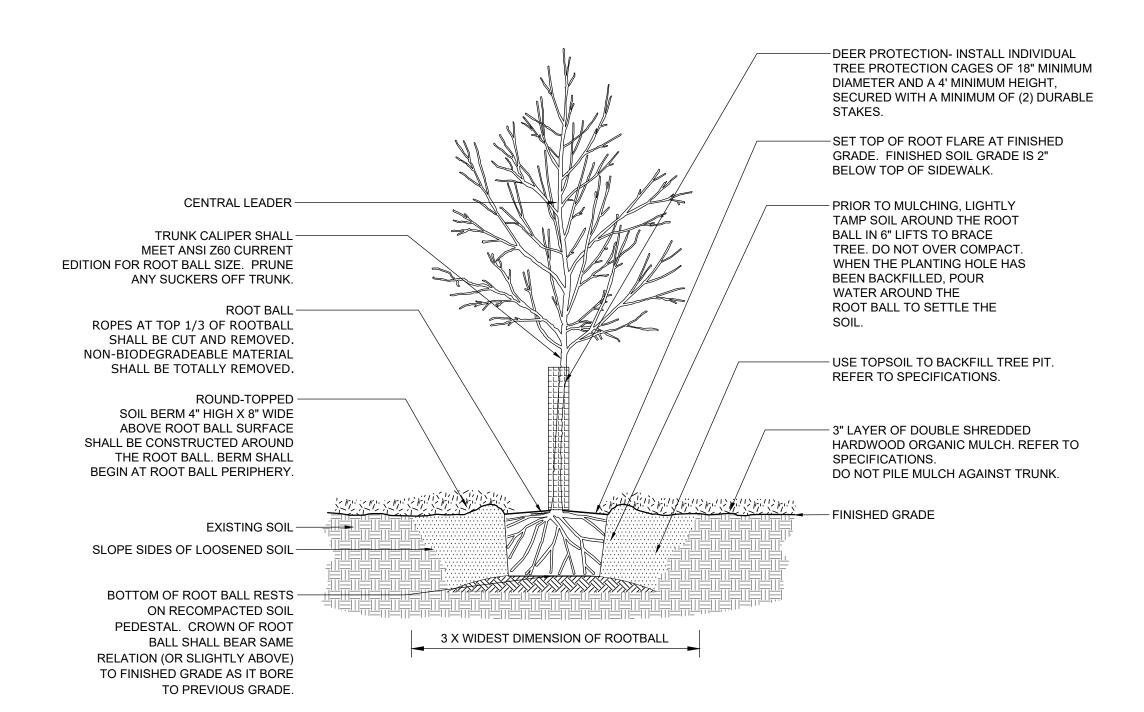




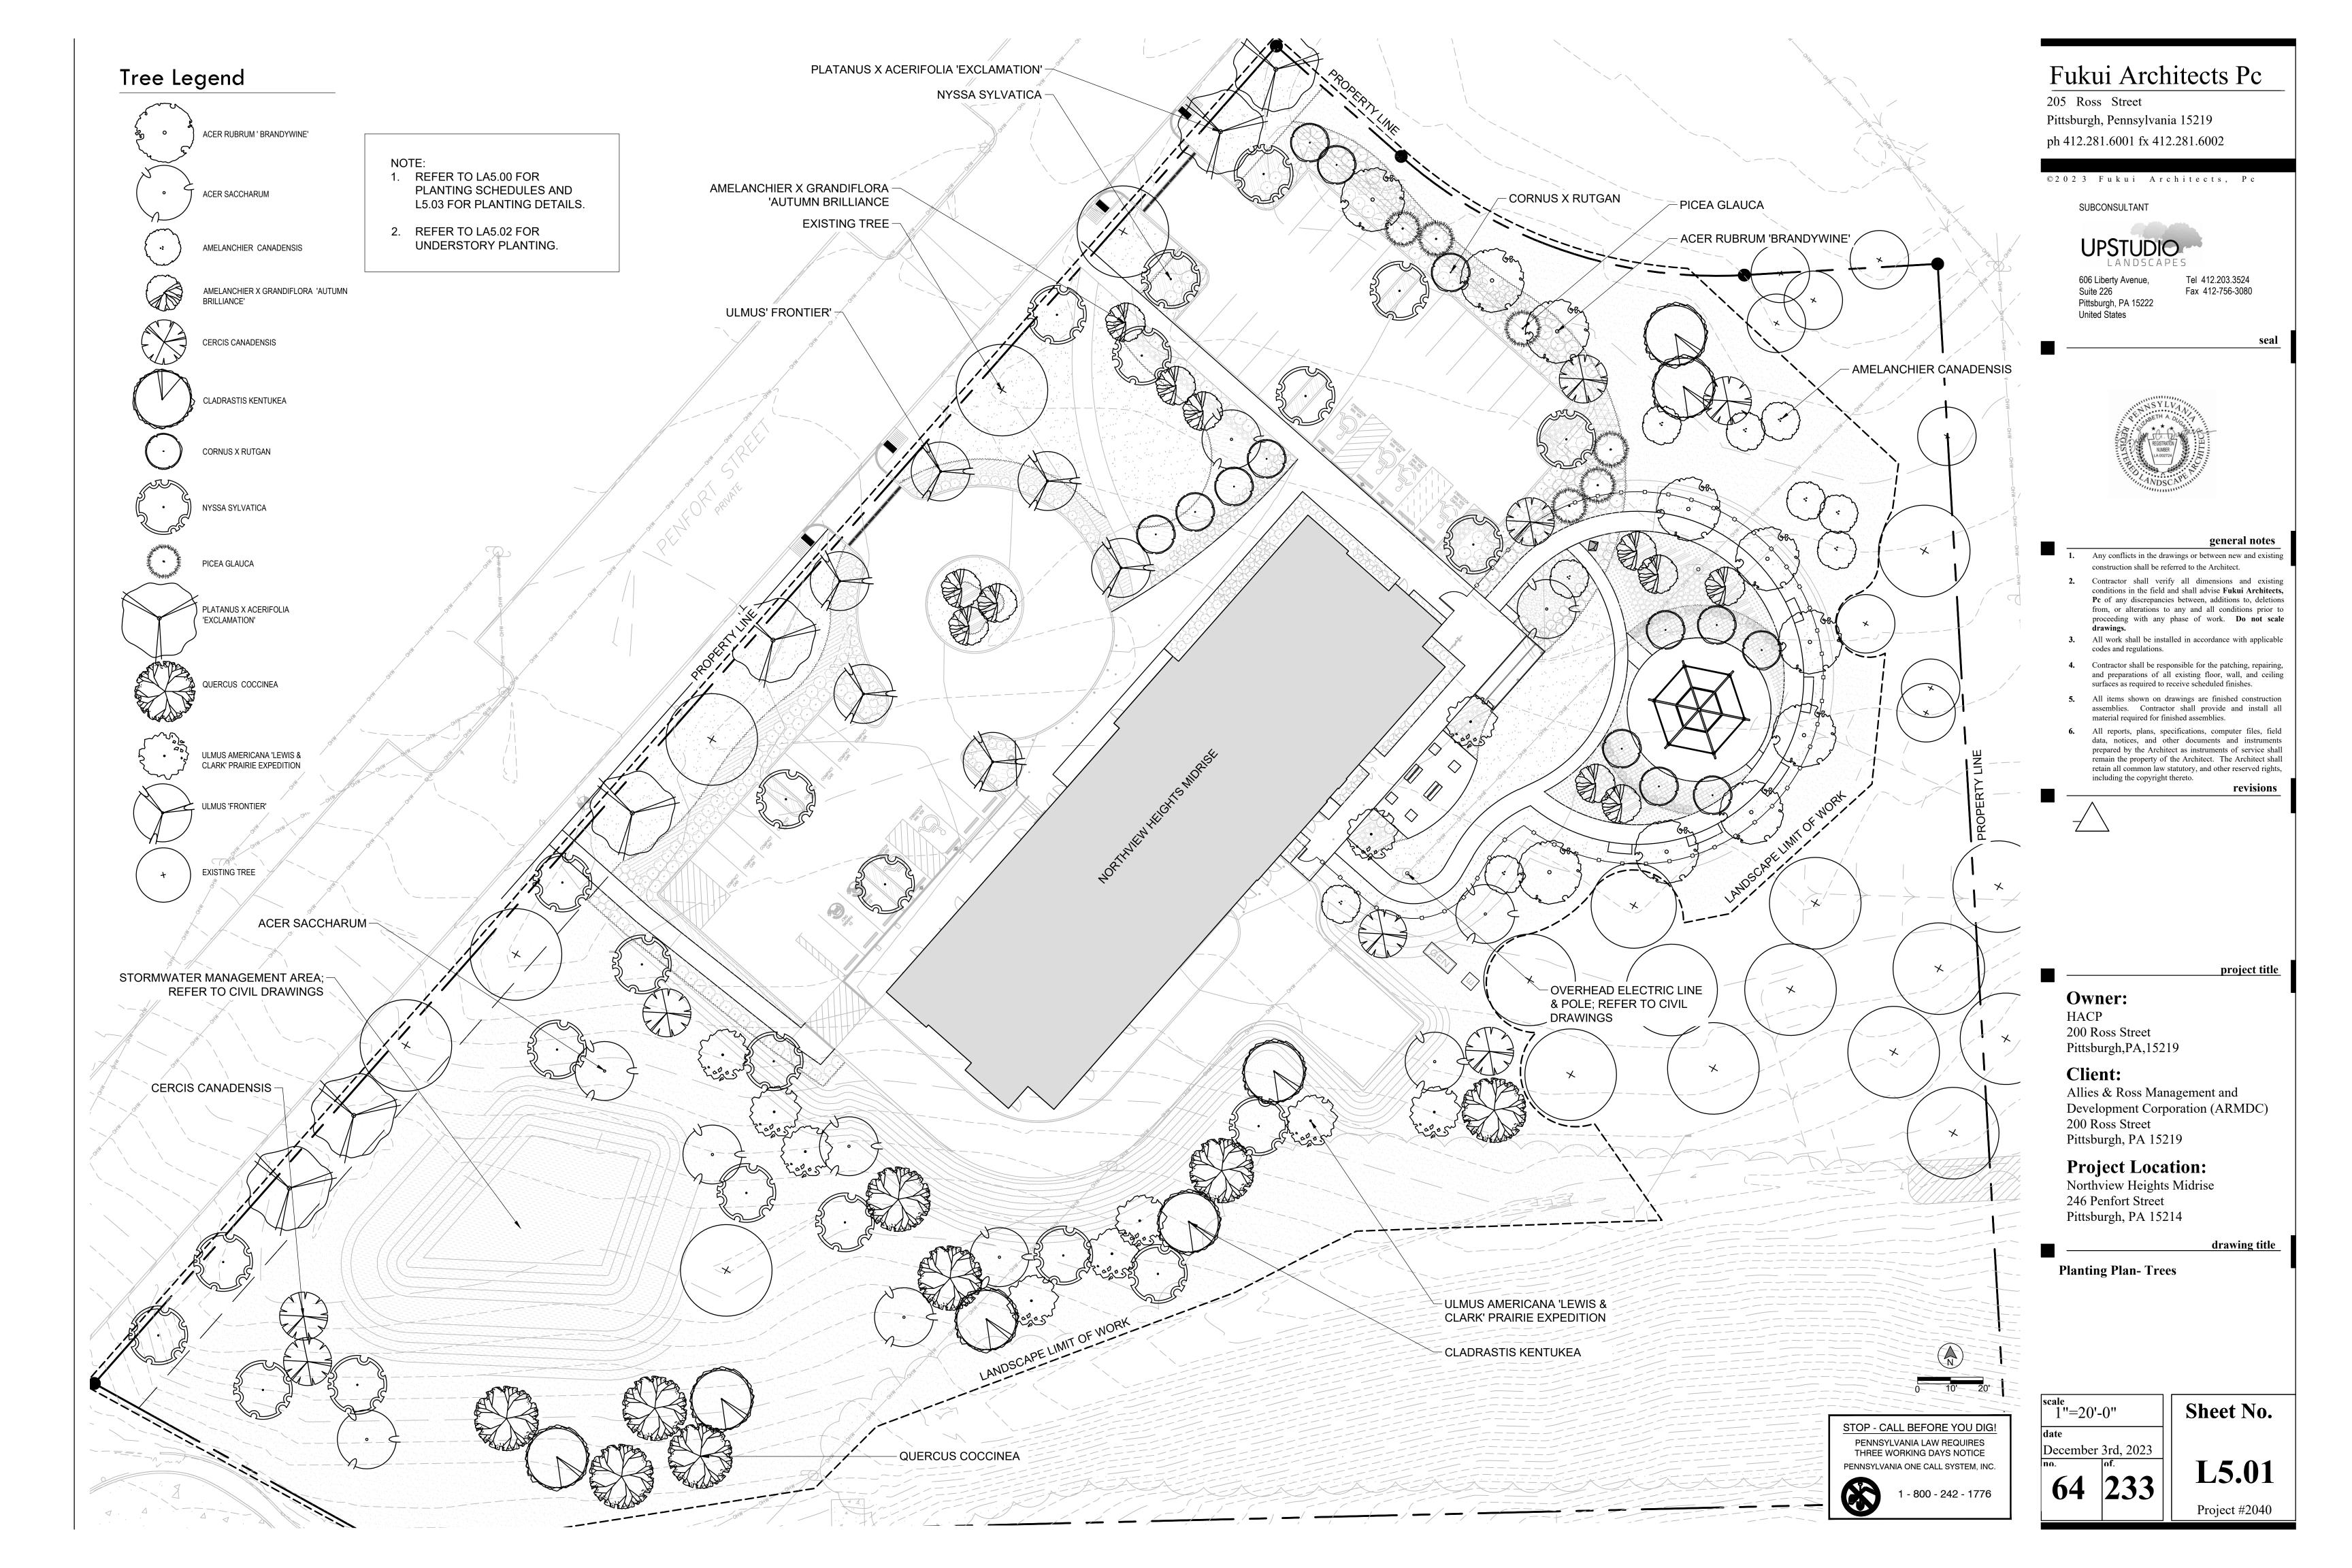

Sign content shall be as in example below or as otherwise provided by City Forester. Signs shall measure

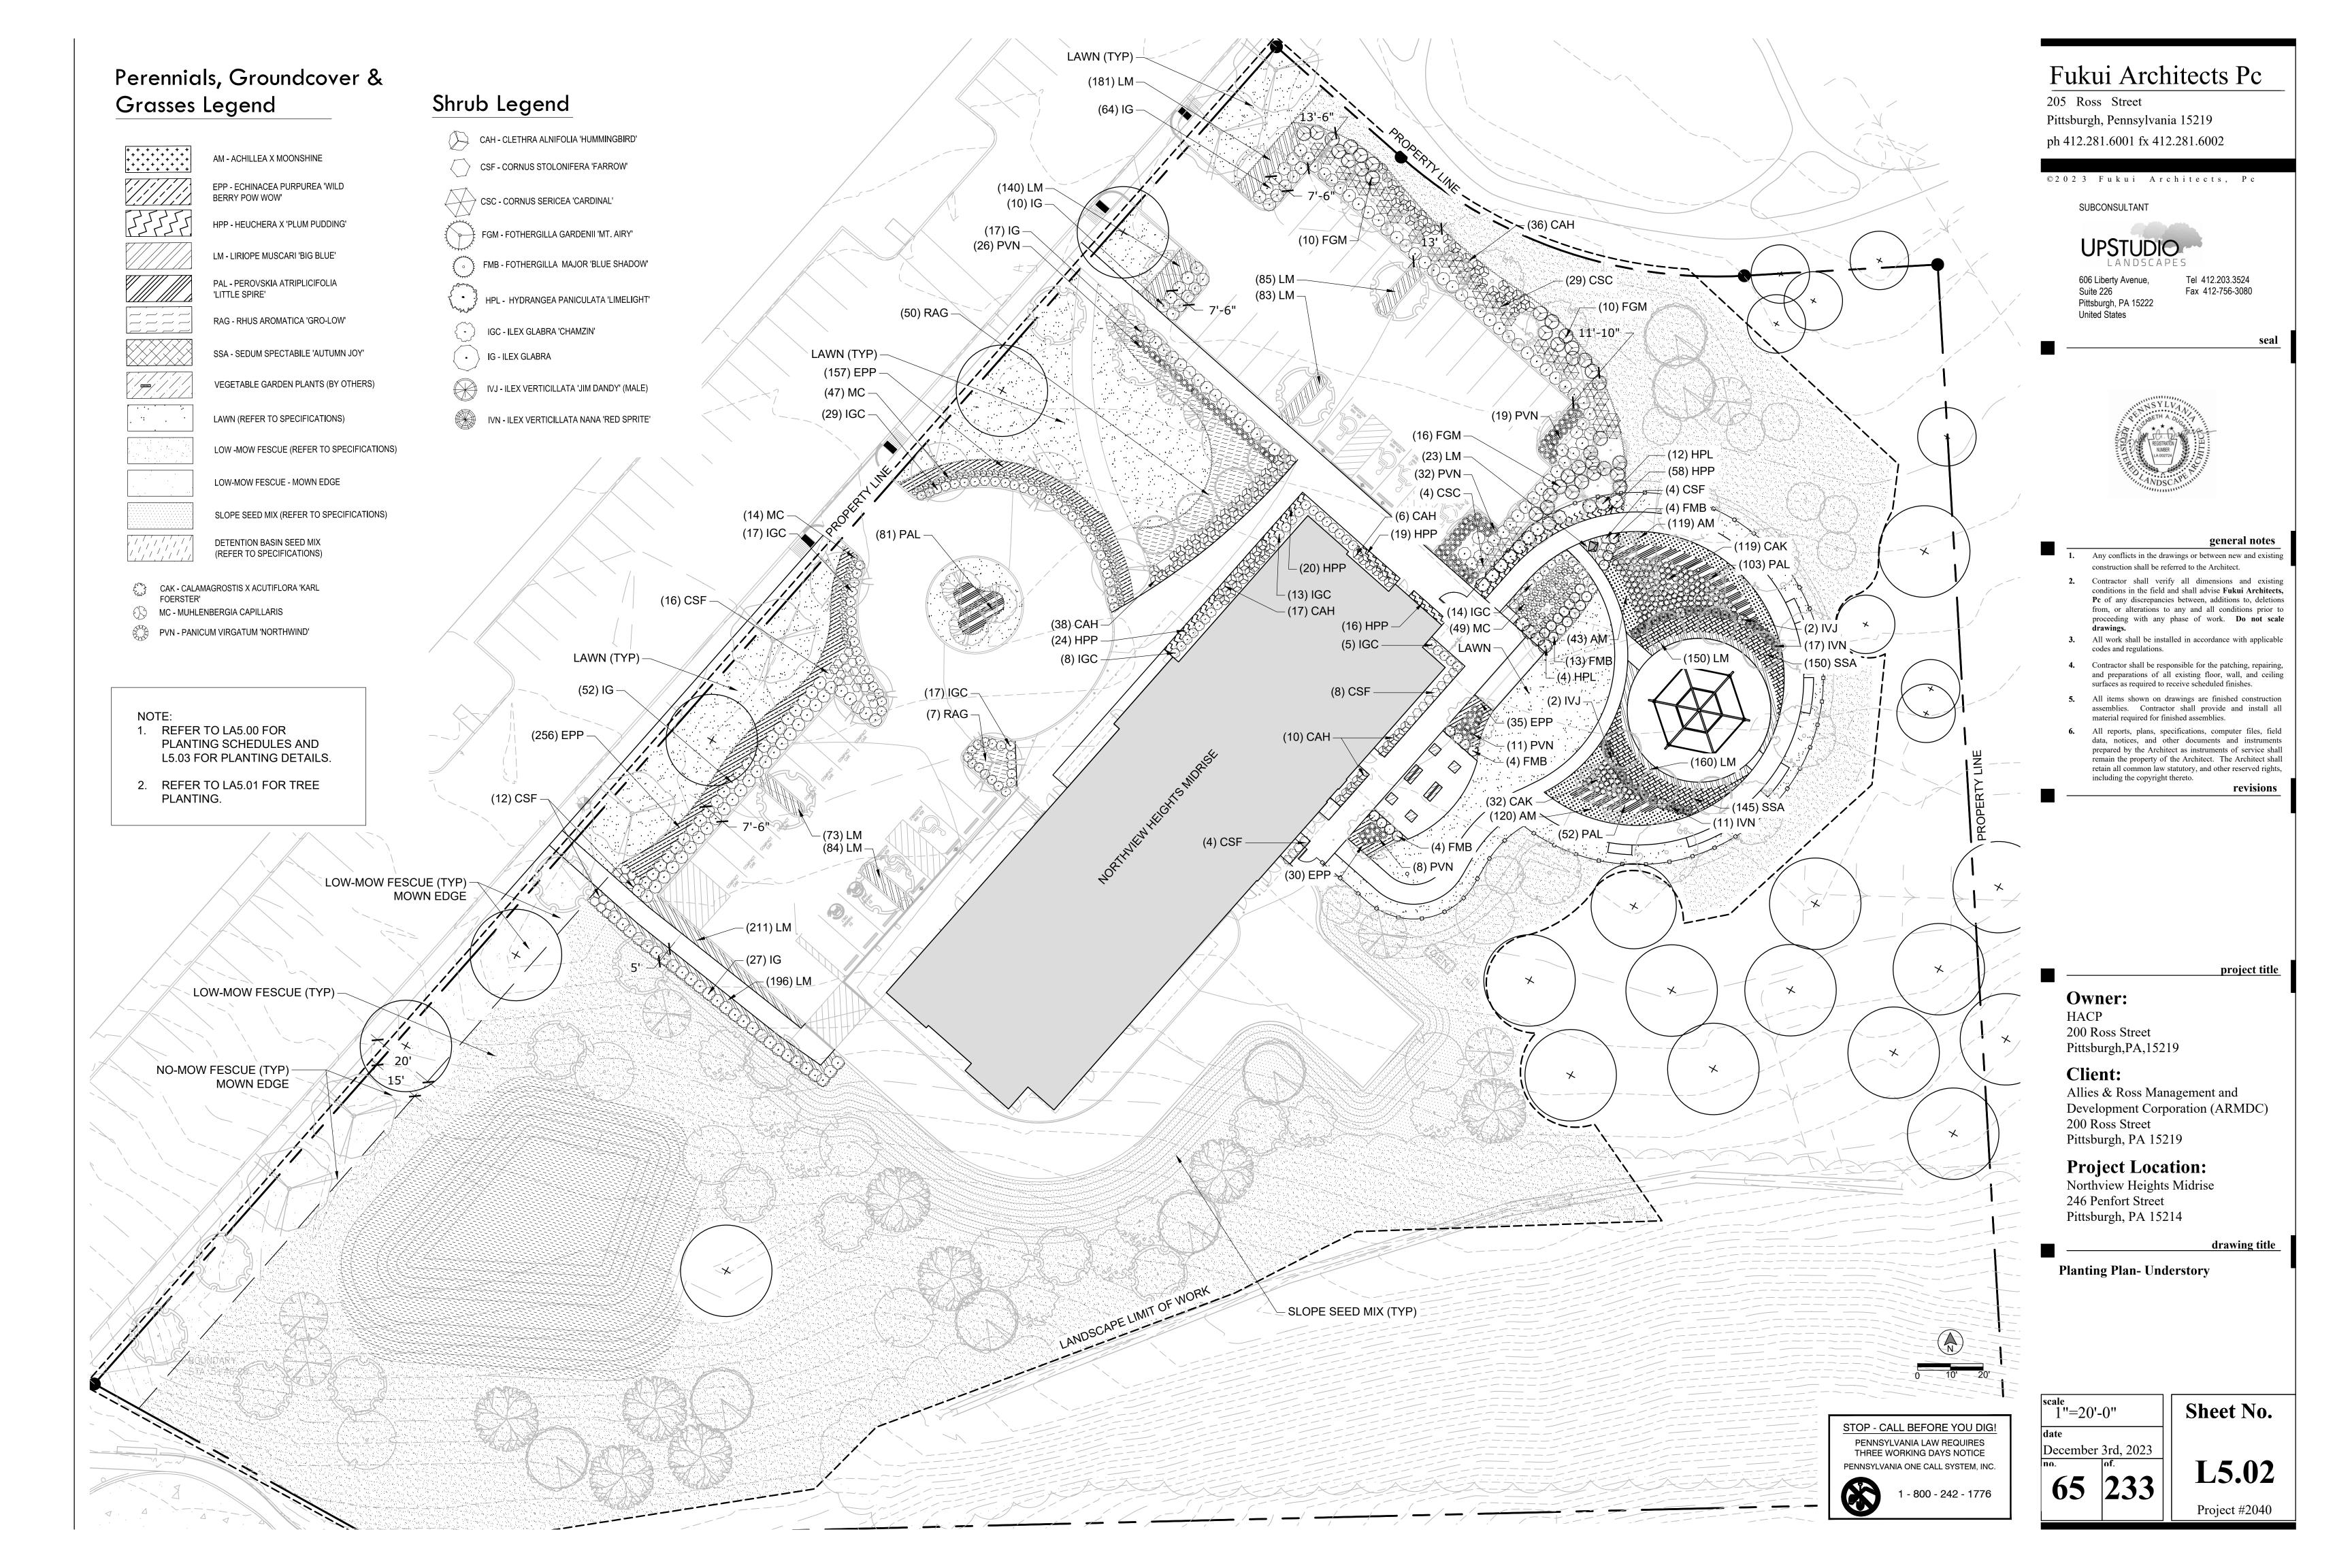





PLANTS DUG WITH FIRM, NATURAL BALLS OF EARTH IN WHICH THEY ARE GROWN, WITH BALL SIZE NOT LESS THAN DIAMETER AND DEPTH RECOMMENDED BY ANSI Z60.1 FOR TYPE AND SIZE OF TREE OR SHRUB REQUIRED; WRAPPED, TIED, RIGIDLY SUPPORTED, AND DRUM-LACED AS RECOMMENDED BY ANSI Z60.1 CURRENT EDITION.

DECIDUOUS TREE PLANTING

TREE PROTECTION

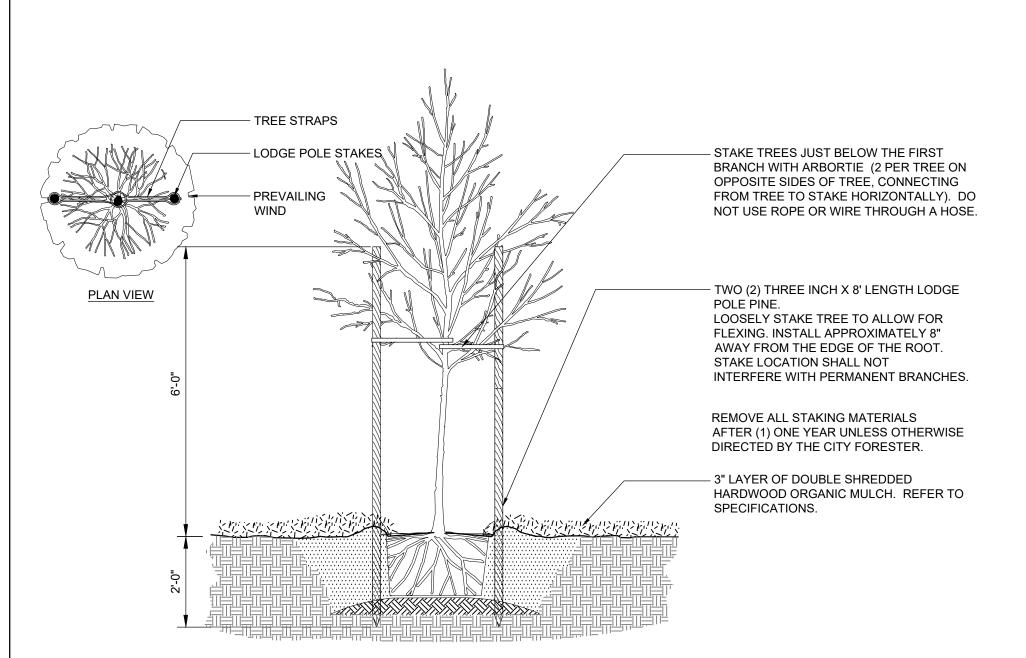


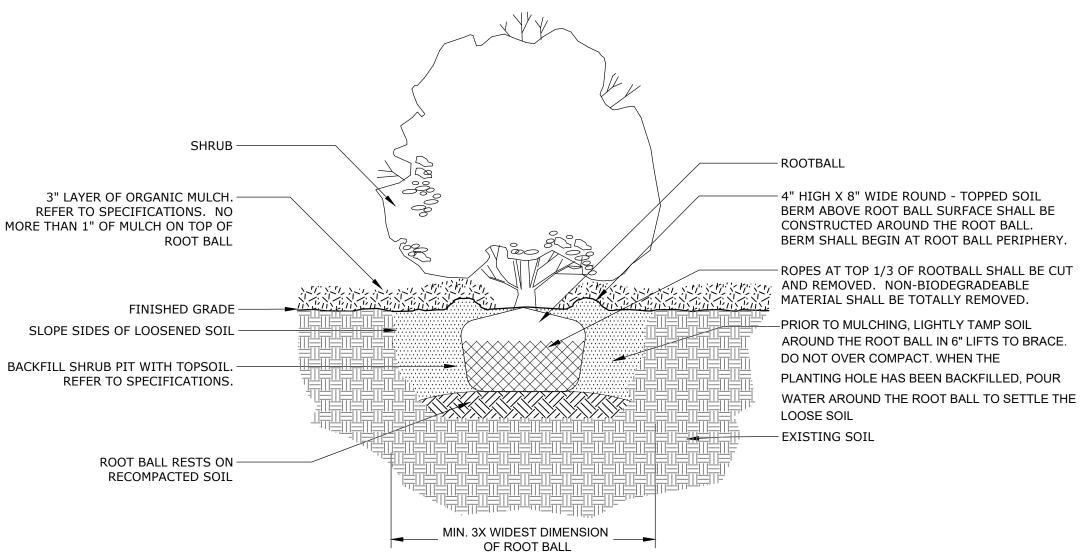

NOTE: BALLED AND BURLAPPED PLANTS DUG WITH FIRM, NATURAL BALLS OF EARTH IN WHICH THEY ARE GROWN, WITH BALL SIZE NOT LESS THAN DIAMETER AND DEPTH RECOMMENDED BY ANSI Z60.1-CURRENT EDITION FOR TYPE AND SIZE OF TREE OR SHRUB REQUIRED; WRAPPED, TIED, RIGIDLY SUPPORTED, AND DRUM-LACED AS RECOMMENDED BY ANSI Z60.1-CURRENT EDITION.


ALL CONTAINER GROWN PLANTS SHALL BE HEALTHY, VIGOROUS, WELL ROOTED, AND ESTABLISHED IN THE CONTAINER IN WHICH THEY ARE GROWING. A CONTAINER GROWN PLANT SHALL HAVE A WELL-ESTABLISHED ROOT SYSTEM REACHING THE SIDES OF THE CONTAINER TO MAINTAIN A FIRM ROOT BALL. CONTAINER SHALL BE RIGID ENOUGH TO HOLD BALL SHAPE AND PROTECT ROOT MASS DURING SHIPPING AND BE SIZED ACCORDING TO ANSI Z60.1-CURRENT EDITION FOR KIND, TYPE, AND SIZE OF PLANT REQUIRED.

SHRUB PLANTING

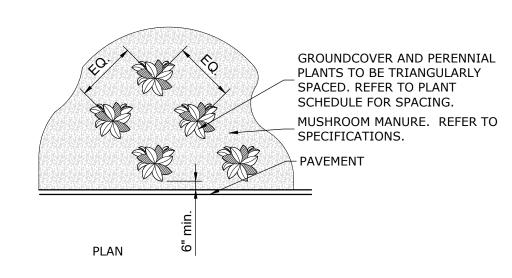


1- SEE PLANTING LEGEND FOR PERENNIAL OR GROUNDCOVER SPECIES, SIZE, AND SPACING DIMENSION. 2- SMALL ROOTS (1/4" OR LESS) THAT GROW AROUND, UP, OR DOWN THE ROOT BALL PERIPHERY ARE CONSIDERED A NORMAL CONDITION IN CONTAINER PRODUCTION AND ARE ACCEPTABLE HOWEVER THEY SHOULD BE ELIMINATED AT THE TIME OF PLANTING. ROOTS ON THE PERIPHERY CAN BE REMOVED AT THE TIME OF PLANTING. (SEE ROOT BALL SHAVING CONTAINER DETAIL).

3- SETTLE SOIL AROUND ROOT BALL OF EACH PERENNIAL OR GROUNDCOVER PRIOR TO MULCHING.

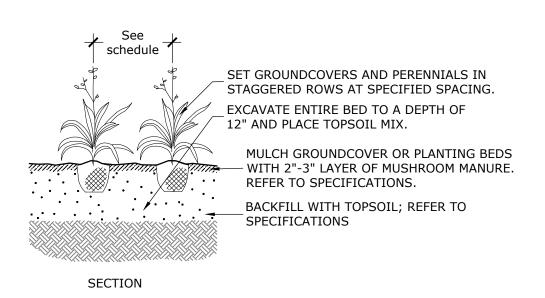

ALL CONTAINER GROWN PERENNIAL PLANTS AND GROUNDCOVERS SHALL BE HEALTHY, VIGOROUS, WELL ROOTED, AND ESTABLISHED IN THE CONTAINER IN WHICH THEY ARE GROWING. A CONTAINER GROWN PERENNIAL PLANT SHALL HAVE A WELL-ESTABLISHED ROOT SYSTEM REACHING THE SIDES OF THE CONTAINER TO MAINTAIN A FIRM ROOT BALL. CONTAINER SHALL BE RIGID ENOUGH TO HOLD BALL SHAPE AND PROTECT ROOT MASS DURING SHIPPING AND BE SIZED ACCORDING TO ANSI Z60.1-CURRENT EDITION FOR KIND, TYPE, AND SIZE OF PLANT REQUIRED.

PERENNIAL & GROUNDCOVER PLANTING NOT TO SCALE

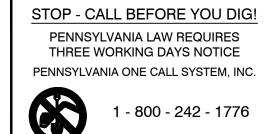

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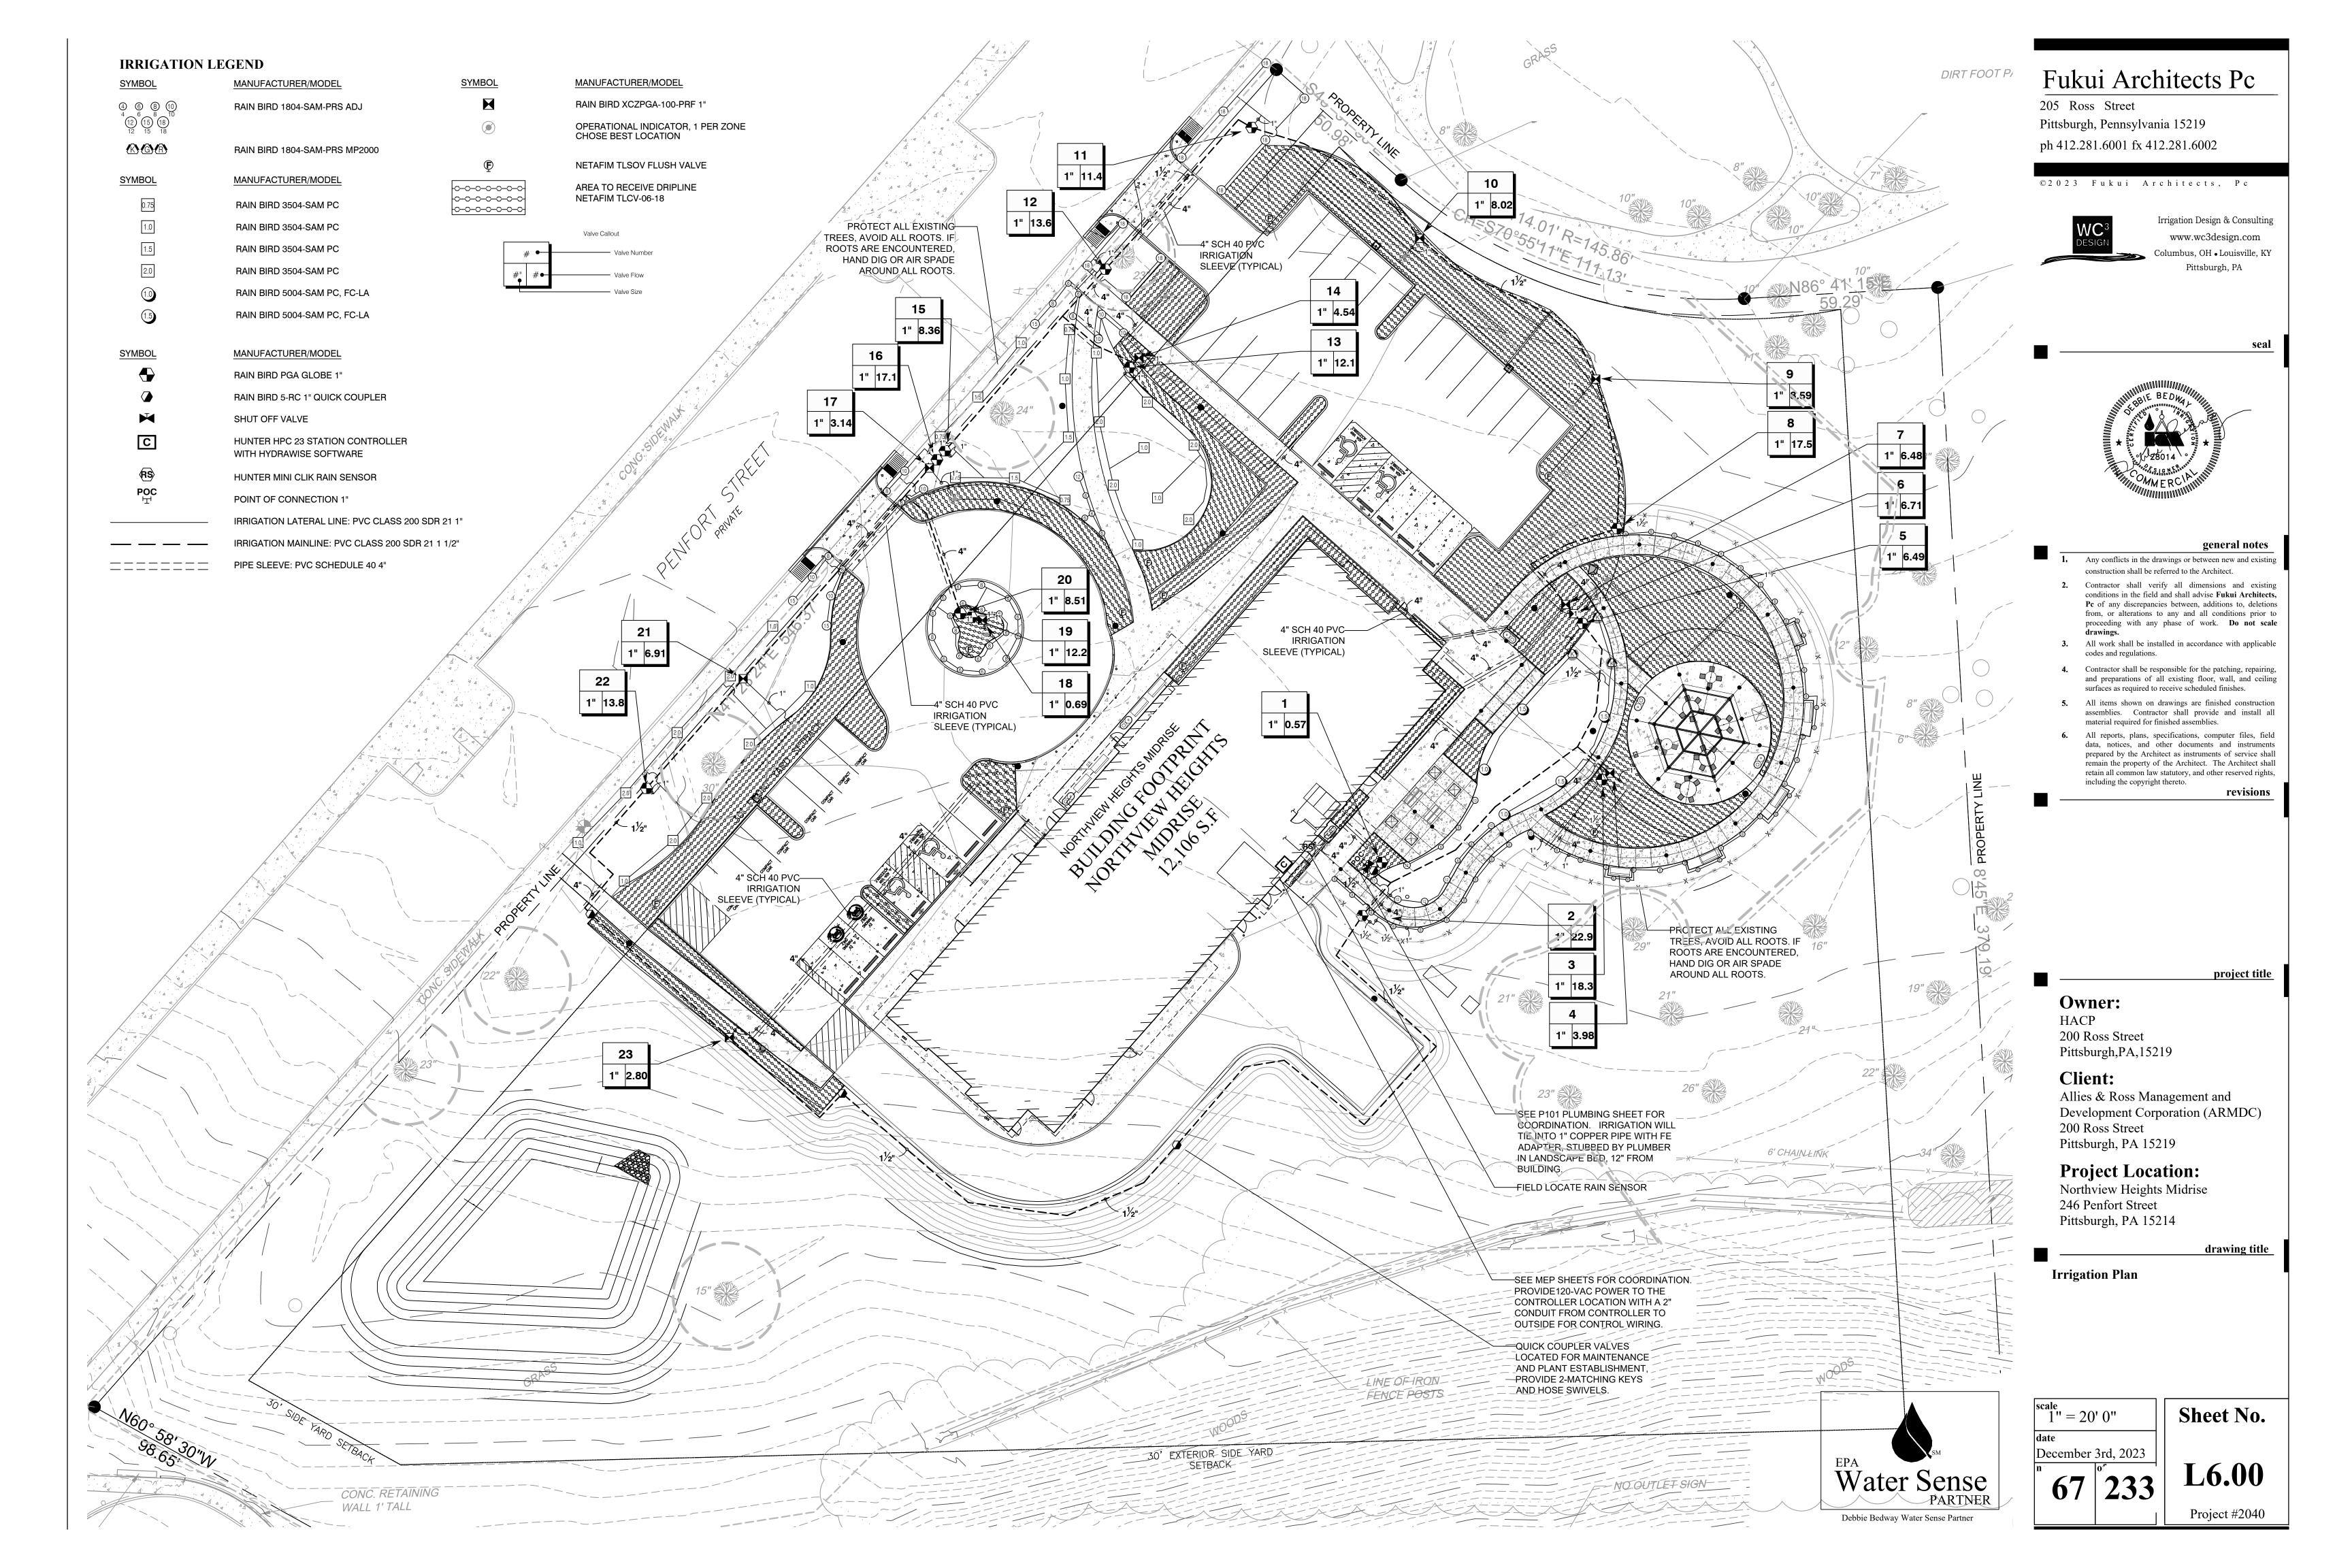
Planting Details

Sheet No. As Shown December 3rd, 2023

L5.03 66 | 233 Project #2040

TREE STAKING(WITH 2 LODGE POLES)





1. THE IRRIGATION SYSTEM IS DIAGRAMMATIC BASED UPON THE INFORMATION PROVIDED BY THE OWNER OR THE OWNER'S REPRESENTATIVE. THE SUCCESSFUL CONTRACTOR IS RESPONSIBLE TO INSTALL A SYSTEM THAT WILL PROPERLY COVER ALL AREAS INDICATED ON THE DESIGN. ACTUAL LAYOUT OF PIPING, SPRINKLER HEADS, VALVES, CONTROLLERS AND OTHER RELATED EQUIPMENT SHALL BE DETERMINED ON SITE. FIELD CHANGES SHALL BE MADE AT NO ADDITIONAL COST TO THE OWNER. IRRIGATION CONTRACTOR MUST BE FULLY AWARE OF THE EXISTING CONDITIONS PRIOR TO BIDDING. SITE WILL BE MADE AVAILABLE FOR INSPECTION, COORDINATE WITH LA.

IT IS THE RESPONSIBILITY OF THE IRRIGATION CONTRACTOR TO BE FAMILIAR WITH ALL GRADE DIFFERENCES, LOCATIONS OF WALLS, STRUCTURES AND UTILITIES AND MAKE THE NECESSARY ADJUSTMENTS TO ACCOMMODATE THE IRRIGATION SYSTEM AS SHOWN ON THE DRAWINGS. THERE MAY BE TIMES WHEN IT IS OBVIOUS IN THE FIELD THAT UNKNOWN OBSTRUCTIONS, GRADES OR DIMENSIONS THAT EXIST MIGHT NOT HAVE BEEN CONSIDERED IN THE ENGINEERING, SUCH OBSTRUCTIONS SHOULD BE BROUGHT TO THE ATTENTIONS OF THE OWNER'S AUTHORIZED REPRESENTATIVE. IN THE EVENT THAT THIS NOTIFICATION IS NOT PERFORMED, THE IRRIGATION CONTRACTOR SHALL ASSUME FULL RESPONSIBILITY FOR ANY REVISIONS AND COSTS THAT OCCUR.

2. THIS SYSTEM SHALL BE INSTALLED USING ACCEPTED AND QUALITY INSTALLATION STANDARDS AS USED IN THE INDUSTRY. ALL MANUFACTURERS SPECIFICATIONS WILL BE FOLLOWED.

3. SYSTEM DESIGN IS BASED ON PRESSURE AND FLOW INFORMATION PROVIDED BY OTHERS, STATIC PRESSURE WAS GIVEN AS TBD AND THE SIZE OF THE P.O.C. IS AS INDICATED ON THE DRAWING. THE IRRIGATION CONTRACTOR SHALL VERIFY WATER PRESSURES PRIOR TO CONSTRUCTION. REPORT DIFFERENCES BETWEEN REQUIREMENTS AND THE ACTUAL READINGS TO THE OWNER'S REPRESENTATIVE.

4. ALL VALVES SHALL BE PLACED IN THE APPROXIMATE AREA AS SHOWN ON THE PLANS.

5. IRRIGATION CONTRACTOR IS TO LOCATE ALL WATERLINES AND UTILITIES AS NEEDED FOR THE IRRIGATION. ALL INFORMATION IS TO BE VERIFIED PRIOR TO ANY INSTALLATION OF THE PROJECT.

6. THE IRRIGATION CONTRACTOR IS RESPONSIBLE FOR ALL CLEAN UP ASSOCIATED WITH HIS WORK.


LINE FLUSHING VALVE
PLUMBED TO PVC OR POLY


-PVC OR POLY EXHAUST HEADER


AIR/VACUUM RELIEF

-- PERIMETER LATERALS 2" TO 4" FROM EDGE


7. IRRIGATION CONTRACTOR SHALL ALL PROVIDE THE FIRST WINTERIZATION, SPRING TURN ON, HEAD ADJUSTMENTS AND CONTROLLER MAINTENANCE IN BID.

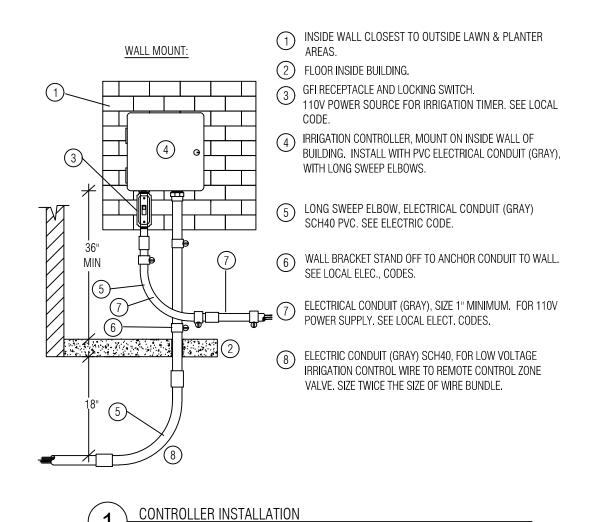

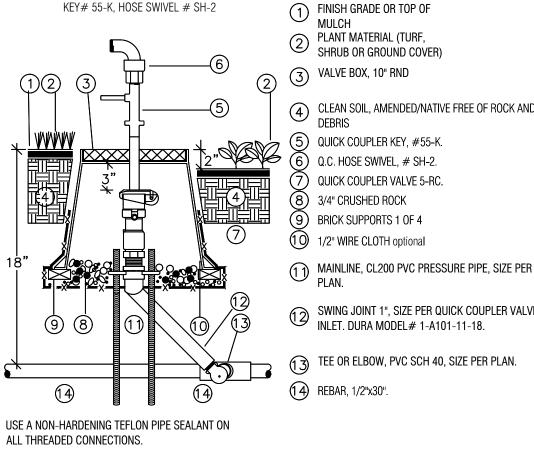

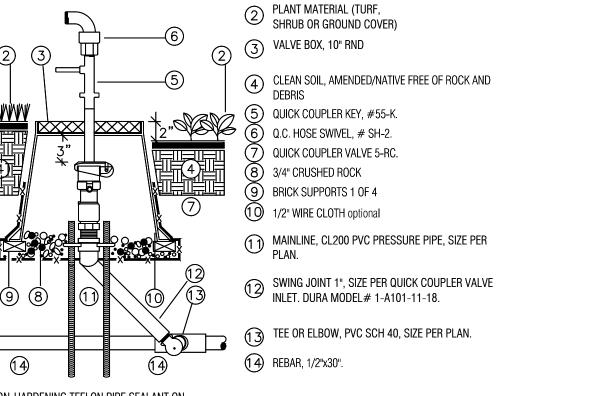

SECTION

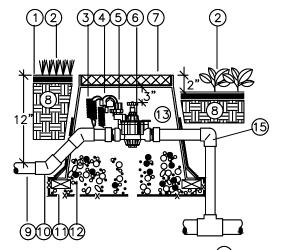

1) FINISH GRADE OR TOP OF MULCH.
(2) PLANT MATERIAL (TURF,

SHRUB OR GROUND COVER) (3) 24V CONTROL WIRE-COILED, 30" IN LINEAR LENGTH.

(14) ELBOW 90 ^, SCH40 PVC.

INSTALL 45 DEGREE ELBOWS TO ACHIEVE CORRECT 15) TEE/ELBOW, SCH40 PVC. DEPTH. USE A NON-HARDENING TEFLON PIPE SEALANT ON ALL THREADED CONNECTIONS. MAINLINE DEPTH IS 18" COVER OVER "TOP" OF PVC

RAINBIRD PGA SOLENOID VALVE

ph 412.281.6001 fx 412.281.6002 (4) WIRE SPLICE WATER PROOF CONNECTOR. VALVE IDENTIFICATION TAG. ©2023 Fukui Architects, Pc REMOTE CONTROL VALVE. VALVE BOX - 10" ROUND. CLEAN COMPACTED BACKFILL (a) LATERAL LINE - CL 200 PVC. (10) ELBOW 45 ^ - SCH40 PVC, 1 OF 2. (1) BRICK SUPPORTS 1 OF 4. (12) 3/4" CRUSHED ROCK. (3) MALE ADAPTER, SCH40 PVC, 1 OF 2.

(1) FINISH GRADE.

(5) SWING PIPE

2 PLANT MATERIAL (TURF).

3 CLEAN SOIL, AMENDED/NATIVE, FREE OF ROCK AND DEBRIS

ROTOR POP-UP SPRINKLER: RAINBIRD MODEL # 5004,

6 TEE/EL, PVC SCH40 LINE SIZE, SIZE PER SPRINKLER INLET

7 PVC LATERAL (NON-PRESSURE PIPE). SIZE PER PLAN.

4" POP-UP HEIGHT, 3/4" INLET.

(6) MAINLINE, CL200 - SEE PLAN.



Fukui Architects Pc

Pittsburgh, Pennsylvania 15219

205 Ross Street

general notes

Irrigation Design & Consulting

www.wc3design.com

Columbus, OH • Louisville, KY

Pittsburgh, PA

seal

Any conflicts in the drawings or between new and existing construction shall be referred to the Architect.

2. Contractor shall verify all dimensions and existing conditions in the field and shall advise Fukui Architects, Pc of any discrepancies between, additions to, deletions from, or alterations to any and all conditions prior to proceeding with any phase of work. Do not scale


All work shall be installed in accordance with applicable codes and regulations.

Contractor shall be responsible for the patching, repairing, and preparations of all existing floor, wall, and ceiling surfaces as required to receive scheduled finishes.

5. All items shown on drawings are finished construction assemblies. Contractor shall provide and install all material required for finished assemblies.

6. All reports, plans, specifications, computer files, field data, notices, and other documents and instruments prepared by the Architect as instruments of service shall remain the property of the Architect. The Architect shall retain all common law statutory, and other reserved rights, including the copyright thereto.

revisions

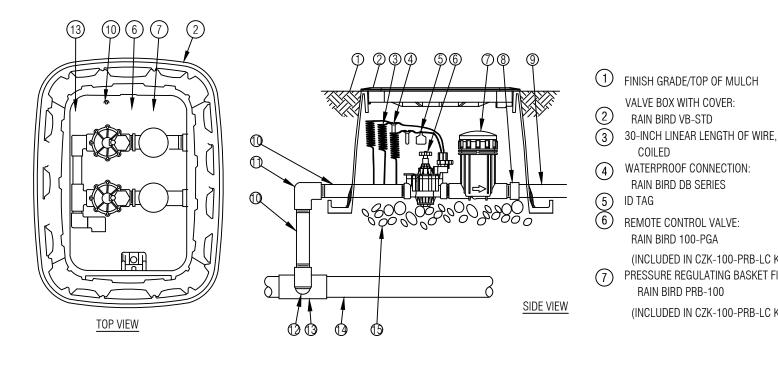

(8) PVC SCH 40 FEMALE ADAPTOR 9 LATERAL PIPE

QCV RAINBIRD MODEL # 5-RC,

10 PVC SCH 80 NIPPLE (LENGTH AS REQUIRED)

WASHED GRAVEL

(11) PVC SCH 40 ELL 12 PVC SCH 80 NIPPLE (2-INCH LENGTH,

HIDDEN) AND PVC SCH 40 ELL 13 PVC SCH 40 TEE OR ELL

(14) MAINLINE PIPE (15) 3-INCH MINIMUM DEPTH OF 3/4-INCH

(INCLUDED IN CZK-100-PRB-LC KIT) PRESSURE REGULATING BASKET FILTER:

RAIN BIRD PRB-100 (INCLUDED IN CZK-100-PRB-LC KIT)

VALVE BOX WITH COVER:

WATERPROOF CONNECTION:


RAIN BIRD DB SERIES


RAIN BIRD 100-PGA

5) ID TAG

RAIN BIRD VB-STD



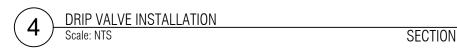

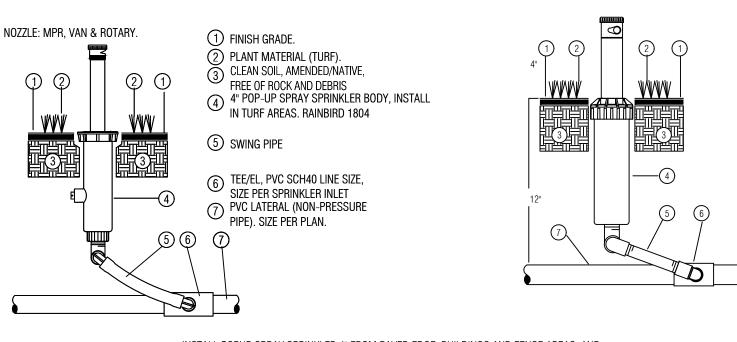



INSTALL POPUP SPRAY SPRINKLER 4" FROM PAVED EDGE, BUILDINGS AND FENCE AREAS, AND INSTALL FLUSH TO GRADE, ADJUST COVERAGE TO AVOID OVERSPRAY ONTO PAVED SURFACES, FENCES, BUILDINGS AND PARKING LOTS. USE ONLY TEFLON TAPE OR SEALANT ON ALL THREADED CONNECTIONS.



WATER SCHEDULE/WATER USAGE TO BE USED AS A GUIDE ONLY

NUMBER	MODEL	TYPE	PRECIP	IN./WEEK	MIN./WEEK	GAL./WEEK	GAL./DAY
1	Rain Bird PGA Globe	Turf Spray	3.38 in/h	1	18	256.8	36.7
2	Rain Bird PGA Globe	Turf Spray	1.39 in/h	1	44	685.8	98.0
3	Rain Bird PGA Globe	Turf Spray	0.88 in/h	1	68	902.1	128.9
4	Rain Bird XCZPGA-100-PRF	Area for Dripline	0.56 in/h	1	107	561.8	80.3
5	Rain Bird PGA Globe	Shrub Rotary	0.47 in/h	0.75	97	629.4	209.8
6	Rain Bird XCZPGA-100-PRF	Area for Dripline	0.52 in/h	1	116	946.6	135.2
7	Rain Bird XCZPGA-100-PRF	Area for Dripline	0.54 in/h	1	111	1,577	225.3
8	Rain Bird PGA Globe	Turf Spray	0.4 in/h	1	149	1,701	243.0
9	Rain Bird XCZPGA-100-PRF	Area for Dripline	0.52 in/h	1	116	1,285	183.6
10	Rain Bird XCZPGA-100-PRF	Area for Dripline	0.54 in/h	1	113	1,135	162.1
11	Rain Bird PGA Globe	Turf Spray	1.25 in/h	1	48	547.0	78.1
12	Rain Bird PGA Globe	Turf Spray	1.54 in/h	1	40	545.8	78.0
13	Rain Bird PGA Globe	Turf Rotor	0.7 in/h	1	86	1,043	149.0
14	Rain Bird XCZPGA-100-PRF	Area for Dripline	0.61 in/h	1	98	1,147	163.8
15	Rain Bird PGA Globe	Turf Rotor	0.67 in/h	1	90	752.4	107.5
16	Rain Bird PGA Globe	Turf Spray	1.61 in/h	1	38	648.5	92.6
17	Rain Bird XCZPGA-100-PRF	Area for Dripline	0.6 in/h	1	100	441	63.0
18	Rain Bird XCZPGA-100-PRF	Area for Dripline	0.64 in/h	1	95	97.9	14.0
19	Rain Bird PGA Globe	Turf Spray	2.86 in/h	1	21	257.2	36.7
20	Rain Bird PGA Globe	Turf Spray	2.71 in/h	1	23	195.7	28.0
21	Rain Bird XCZPGA-100-PRF	Area for Dripline	0.57 in/h	1	106	937.0	133.9
22	Rain Bird PGA Globe	Turf Rotor	0.57 in/h	1	105	1,451	207.3
23	Rain Bird XCZPGA-100-PRF	Area for Dripline	0.71 in/h	1	85	442	63.1
		TOTALO			1.074	10.100	0.710

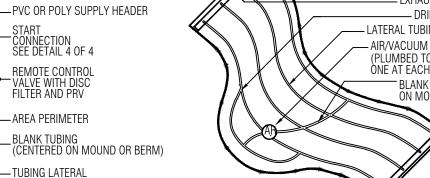

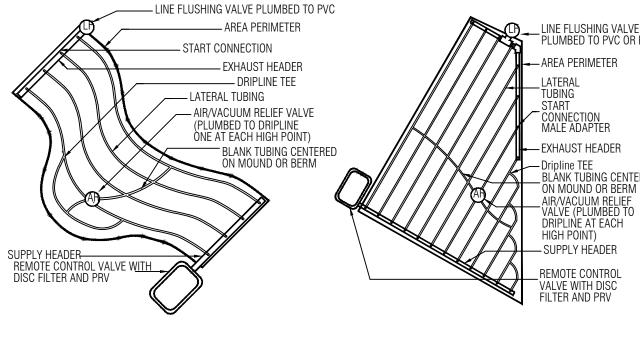

NOTES: 1. DISTANCE BETWEEN LATERAL ROWS AND EMITTER SPACING TO BE BASED ON SOIL TYPE, PLANT MATERIALS AND CHANGES IN ELEVATION. SEE INSTALLATION SPECIFICATIONS ON NETAFIM WEB SITE (WWW.NETAFIMD.COM) FOR SUGGESTED SPACING. 2. LENGTH OF LONGEST DRIPLINE LATERAL SHOULD NOT EXCEED THE MAXIMUM SPACING SHOWN IN THE ACCOMPANYING TABLE.

1 EASY FIT COMPRESSION TEE:

MDCFTEE

(5) MULCH


(6) FINISH GRADE


2 ON-SURFACE DRIPLINE:


(3) INLINE DRIP EMITTER OUTLET


(4) TIE DOWN STAKE: RAIN BIRD TDS-050 WITH BEND

DRIPLINE MAX DISTANCES

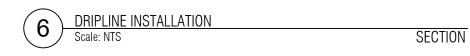

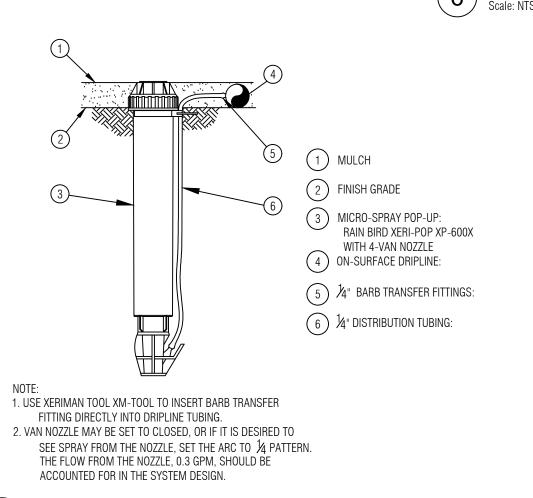

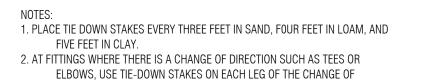

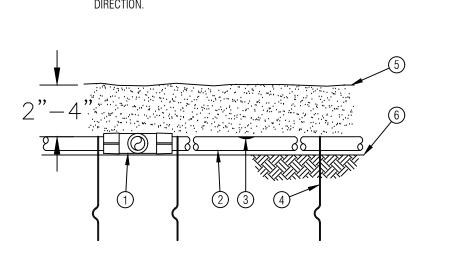

SECTION

NUMBER	MODEL	TYPE	PRECIP	IN./WEEK	MIN./WEEK	GAL./WEEK	GAL./DAY
1	Rain Bird PGA Globe	Turf Spray	3.38 in/h	1	18	256.8	36.7
2	Rain Bird PGA Globe	Turf Spray	1.39 in/h	1	44	685.8	98.0
3	Rain Bird PGA Globe	Turf Spray	0.88 in/h	1	68	902.1	128.9
4	Rain Bird XCZPGA-100-PRF	Area for Dripline	0.56 in/h	1	107	561.8	80.3
5	Rain Bird PGA Globe	Shrub Rotary	0.47 in/h	0.75	97	629.4	209.8
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22	Rain Bird PGA Globe	Turf Rotor	0.57 in/h	1	105	1,451	207.3
23	Rain Bird XCZPGA-100-PRF	Area for Dripline	0.71 in/h	1	85	442	63.1
		TOTALS:			1,874	18,186	2,718
	-	•	_	_	-		_

project title

Project Location: Northview Heights Midrise 246 Penfort Street Pittsburgh, PA 15214

Allies & Ross Management and

Development Corporation (ARMDC)

drawing title

Irrigation Notes and Details

Owner:

Client:


200 Ross Street

200 Ross Street

Pittsburgh, PA 15219

Pittsburgh,PA,15219

HACP

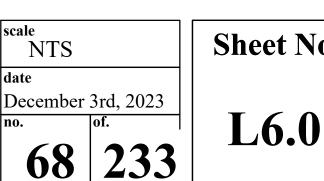

Sheet No. L6.01

FOUNDATION PLAN LEGDEND

 \vdash - - -

EXTERIOR, ELEVATOR STEM WALL. REFER TO STRUCTURAL DRAWINGS.

EXTERIOR STEM WALL SPREAD FOOTING, SLAB. REFER TO STRUCTURAL DRAWINGS.

GENERAL FOUNDATION PLAN NOTES


- 1. THIS DRAWING IS FOR LAYOUT PURPOSES ONLY. NOT ALL STRUCTURAL STEM WALL OR FOOTINGS ARE DRAWN ON THIS FOUNDATION PLAN. SEE STRUCTURAL DRAWINGS.
- 2. DIMENSIONS DRAWN ARE FROM FACE OF STUD AND FACE OF CONCRETE BLOCK STEM WALL.
- 3. INTERIOR SLABS SEE SECTION FOR INSULATION BOARD UNDER SLAB. REFER TO STRUCTURAL DRAWINGS AND SPECIFICATIONS FOR CONCRETE, REINFORCING, AND DETAILS.
- 4. EXTERIOR SLABS SLOPE MIN. 1/8" PER FT. TO SHED WATER AWAY FROM BUILDING. REFER TO STRUCTURAL AND CIVIL DRAWINGS AND SPECIFICATIONS, CONCRETE, REINFORCING, AND DETAILS.

NORTH

Fukui Architects Pc

205 Ross Street Pittsburgh, Pennsylvania 15219 ph 412.281.6001 fx 412.281.6002

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FOUNDATION PLAN

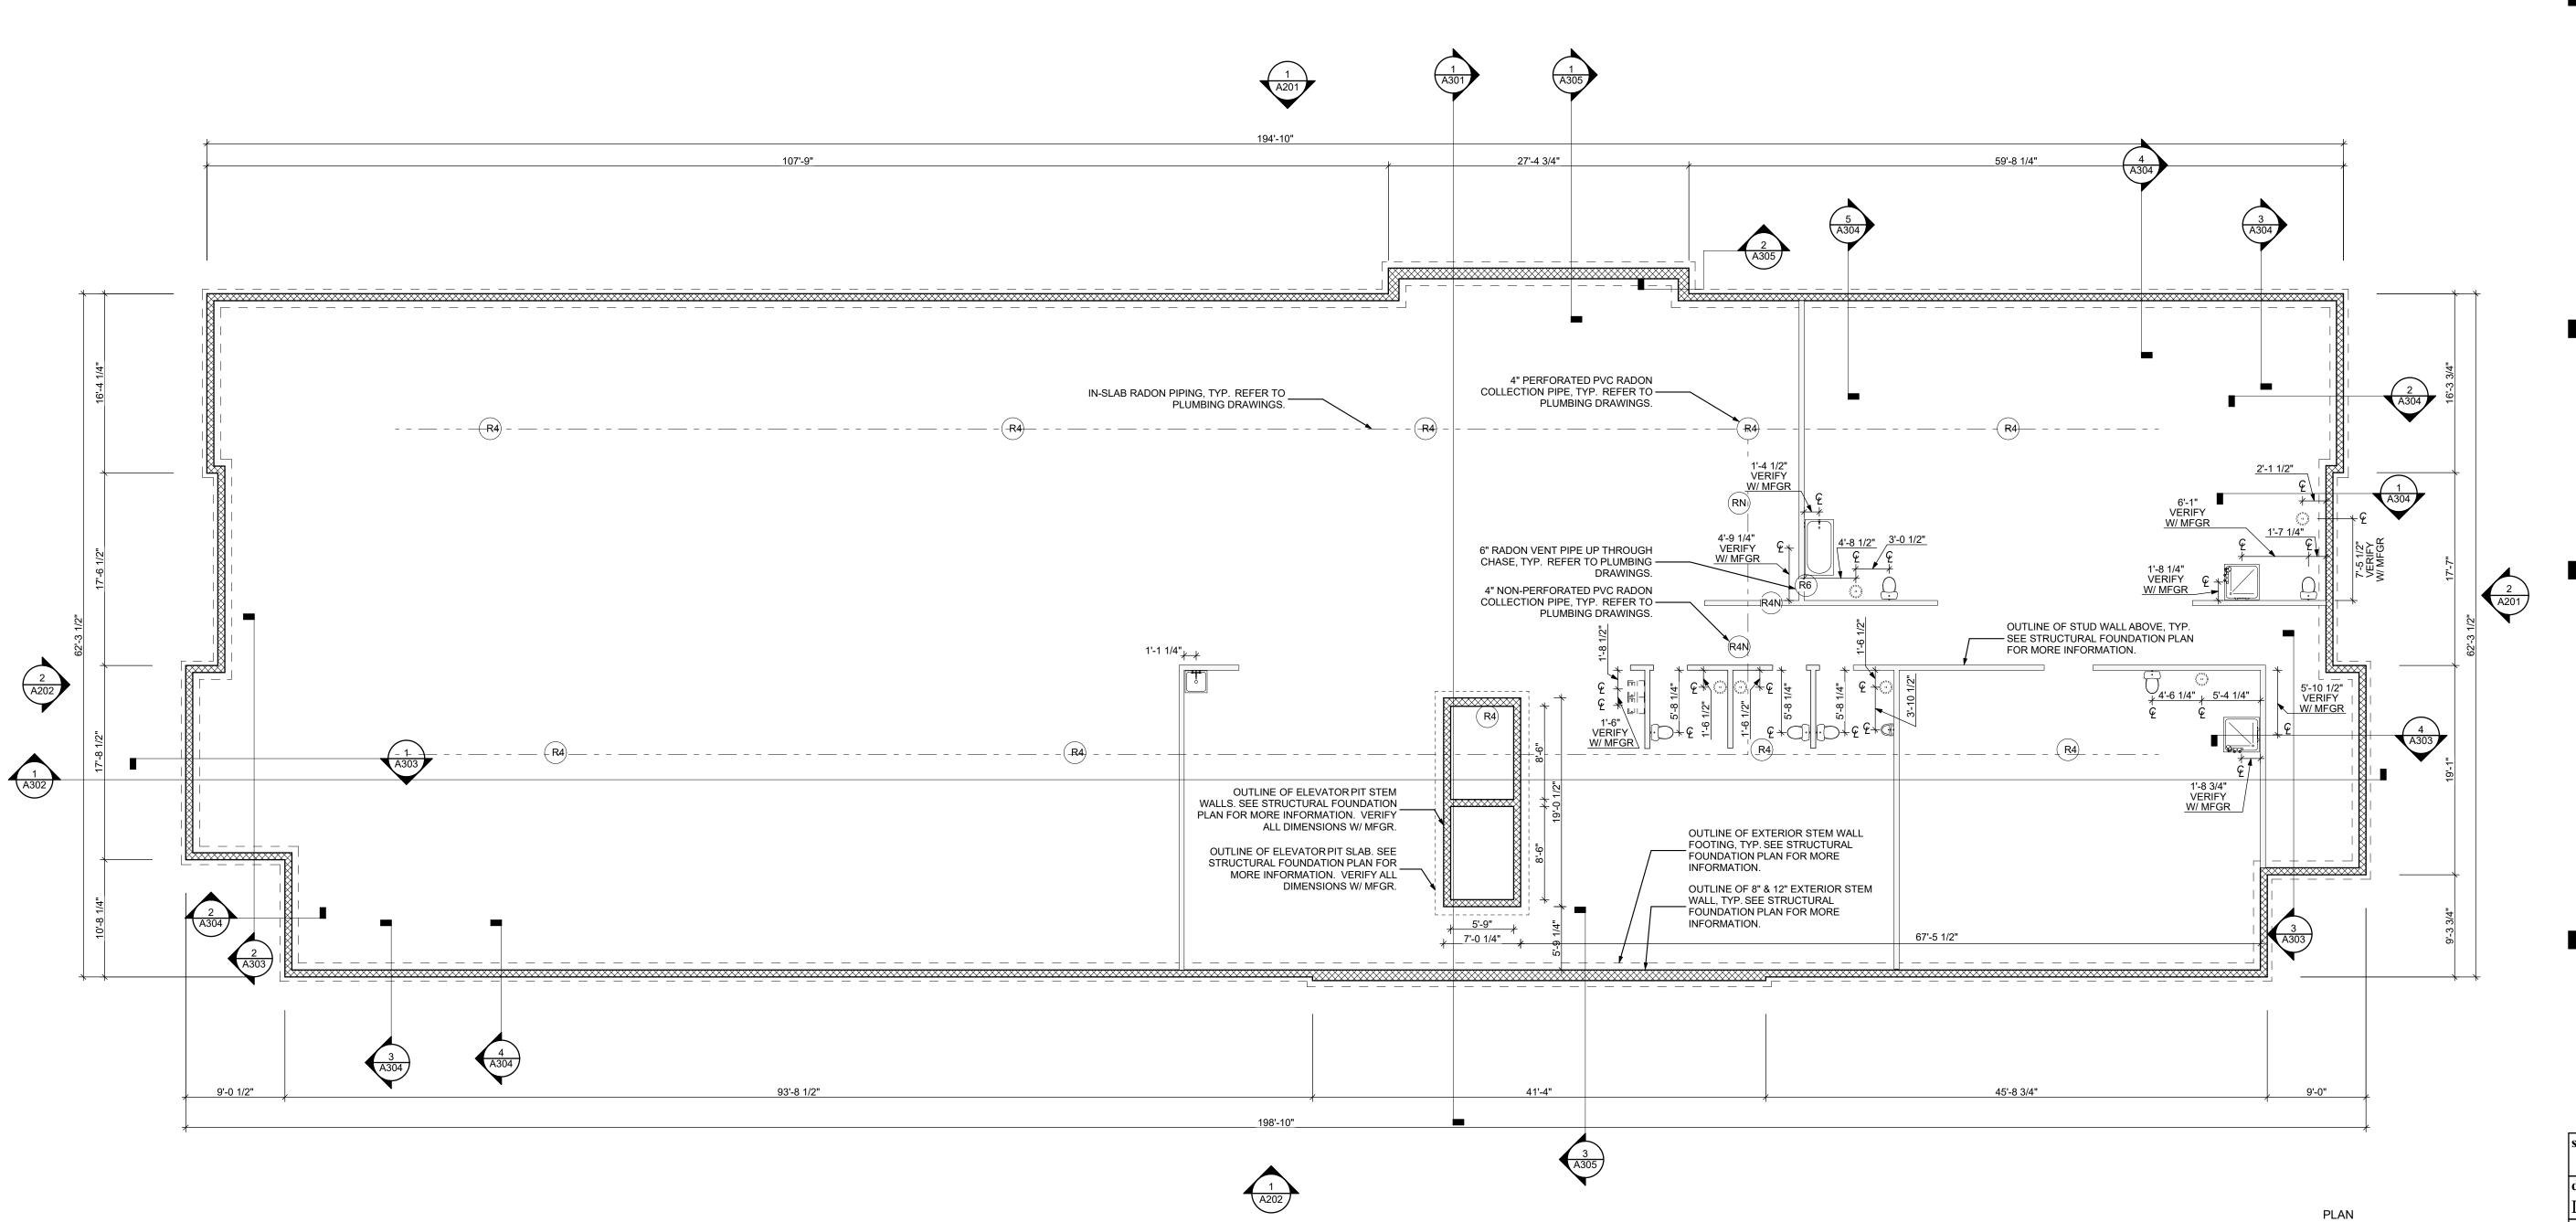SCALE: 1/8" = 1'-0"

general notes

- Any conflicts in the drawings or between new and existing construction shall be referred to the Architect.
- 2. Contractor shall verify all dimensions and existing conditions in the field and shall advise Fukui Architects, Pc of any discrepancies between, additions to, deletions from, or alterations to any and all conditions prior to proceeding with any phase of work. Do not scale
- **3.** All work shall be installed in accordance with applicable codes and regulations.
- 4. Contractor shall be responsible for the patching, repairing, and preparations of all existing floor, wall, and

ceiling surfaces as required to receive scheduled finishes.

- 5. All items shown on drawings are finished construction assemblies. Contractor shall provide and install all material required for finished assemblies.
- **6.** All reports, plans, specifications, computer files, field data, notices, and other documents and instruments prepared by the Architect as instruments of service shall remain the property of the Architect. The Architect shall retain all common law statutory, and other reserved rights, including the copyright thereto.

revisions

project title

Owner:

HACP 200 Ross Street Pittsburgh,PA,15219

Client:

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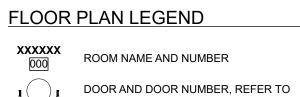
Project Location:

Northview Heights Midrise 246 Penfort Street Pittsburgh, PA 15214

drawing title

FOUNDATION PLAN

As Noted	Sheet No.
date	
December 3rd, 2023	
no. of.	



DOOR SCHEDULE WINDOW AND WINOW NUMBER, REFER TO WINDOW SCHEDULE

WALL TYPE, REFER TO WALL TYPES SHEET

GENERAL FLOOR PLAN NOTES

- PROVIDE 2X BLOCKING @ EXTERIOR WALLS FOR SHEATHING OR GYP WALL BOARD JOINTS THAT ARE NOT LOCATED AT A STUD.
- 2. THE FINSH FLOOR OF THIS PROJECT IS IDENTIFIED AT 0'-0" IN THIS SET OF DRAWINGS.
- 3. ALL BUILDING ENVELOPE PENETRATIONS INCLUDING CEILINGS, WALLS, FLOORS, TO BE SEALED AS REQUIRED TO PREVENT AIR LEAKAGE.
- 4. WRITTEN DIMENSIONS TAKE PRECEDENCE OVER GRAPHIC REPRESENTATIONS. NOTIFY ARCHITECT IN WRITING OF ANY INCONSISTENT OR MISSING DIMENSIONS.
- 5. DIMENSIONS SHOWN ARE DRAWN FROM FACE OF STUD / CONC. BLOCK FOR INTERIOR WALLS AND FROM OUTSIDE FACE OF SHEATHING FOR EXTERIOR WALLS, UNLESS NOTED OTHERWISE.
- 6. ALL DOOR FRAMES TO BE LOCATED 4" FROM PERPENDICULAR WALLS, UNLESS NOTED OTHERWISE.
- 7. GENERAL CONTRACTOR TO VERIFY VERIFY REQUIRED ROUGH OPENINGS FOR DOORS, WINDOWS, TRANSOMS, AND SIDELIGHTS.
- 8. VERIFY ROUGH-IN DIMENSIONS FOR ALL APPLIANCES & PLUMBING FIXTURES PRIOR TO FRAMING PARTITIONS, ORDERING CABINETRY OR FABRICATING MILLWORK.

- 9. REFER TO ELEVATIONS AND SCHEDULE FOR WINDOW TYPES AND SIZES.
- 10. REFER TO PLUBMING AND CIVIL PLANS FOR ALL DRAIN AND CLEAN-OUT LOCATIONS.
- 11. RADON STACK PASSIVE RADON MIGITAGATION SYSTEM. REFER TO PLUMBING DRAWINGS FOR TYPICAL VENTING DETAIL. SYSTEM TO BE ACTIVATED IF NECESSARY.
- 12. PROVIDE A SHELF AND CONTINUOUS ROD IN ALL BEDROOM CLOSETS AND UNIT ENTRY CLOSETS. PROVIDE FIVE (5) SHELVES IN LINEN AND PANTRY CLOSETS.
- 13. PROVIDE WALL CORNER GUARDS (TEXTURED, VINYL 2" X 2" MIN.) ATALL OUTSIDE CORNERS IN ALL COMMON AREAS AND IN ALL ACCESSIBLE UNITS.
- REFER TO FINISH SCHEDULE. 14. PROVIDE SOLID BLOCKING FOR SUPPORT OF ALL BATH AND KITCHEN CABINETS, ALL TOILET ACCESSORIES, STAIR HANDRAILS, TOWEL BARS, BLINDS, CURTAIN RODS, MEDICINE CABINETS, SIGNAGE, AND OTHER MISC. ITEMS SUPPORTED AND
- ATTACHED TO WALLS. 15. FINISH ALL WALLS AND SIDES AROUND REMOVEABLE BASE CABINETS.
- 16.ALL FIRST FLOOR ENTRANCES SHAL HAVE ZERO-STEP ENTRY.
- 17.ALL UNIT WINDOWS MUST BE EQUIPPED WITH A CURTAIN ROD AND HORIZONTAL BLINDS, VERTICAL BLINDS, OR OTHER OPAQUE BLINDS. REFER TO SPECIFICATIONS.
- 18. ELECTRICAL, MECHANICAL, PLUMBING, FIRE PROTECTION CONTRACTORS TO COORDIATE WITH THE GENERAL CONTRACTOR FOR THE LOCATION OF ALL ELECTRICAL, MECHANICAL, PLUMBING, FIRE PROTECTION EQUIPMENT PRIOR TO INSTALLATION. REFER TO M.E.P.FP DRAWINGS. VERIFY REQUIRED ADEQUATE CLEARANCES FOR MECHANICAL AND PLUMBING EQUIPMENT WITH SUPPLIERS SPECIFICATIONS BEFORE INSTALLATION OF EQUIPMENT AND LOCATING UTILITY ROOM WALLS AND DOORS.
- 19. REFER TO STRUCTURAL DRAWINGS FOR ALL STRUCTURAL ELEMENTS AND SPECIFICATIONS FOR THIS PROJECT.
- 20. ALL GYP. IN RESTROOMS SHALL BE MOISTURE RESISTANT GYP.
- 21.REFER TO A505 FOR AIR SEALING NOTES.

general notes

- Any conflicts in the drawings or between new and existing construction shall be referred to the Architect.
- 2. Contractor shall verify all dimensions and existing conditions in the field and shall advise Fukui Architects, Pc of any discrepancies between, additions to, deletions from, or alterations to any and all conditions prior to proceeding with any phase of work. Do not scale

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Pittsburgh, Pennsylvania 15219

ph 412.281.6001 fx 412.281.6002

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- 3. All work shall be installed in accordance with applicable codes and regulations.
- 4. Contractor shall be responsible for the patching, repairing, and preparations of all existing floor, wall, and ceiling surfaces as required to receive scheduled finishes.
- 5. All items shown on drawings are finished construction assemblies. Contractor shall provide and install all material required for finished assemblies.
- 6. All reports, plans, specifications, computer files, field data, notices, and other documents and instruments prepared by the Architect as instruments of service shall remain the property of the Architect. The Architect shall retain all common law statutory, and other reserved rights, including the copyright thereto.

revisions

project title

Owner:

HACP 200 Ross Street Pittsburgh,PA,15219

Client:

Allies & Ross Management and Development Corporation (ARMDC) 200 Ross Street Pittsburgh, PA 15219

Project Location:

Northview Heights Midrise 246 Penfort Street Pittsburgh, PA 15214

drawing title


FIRST FLOOR PLAN

As Noted December 3rd, 2023

Sheet No.

A102

70 | 233 | Project #2040

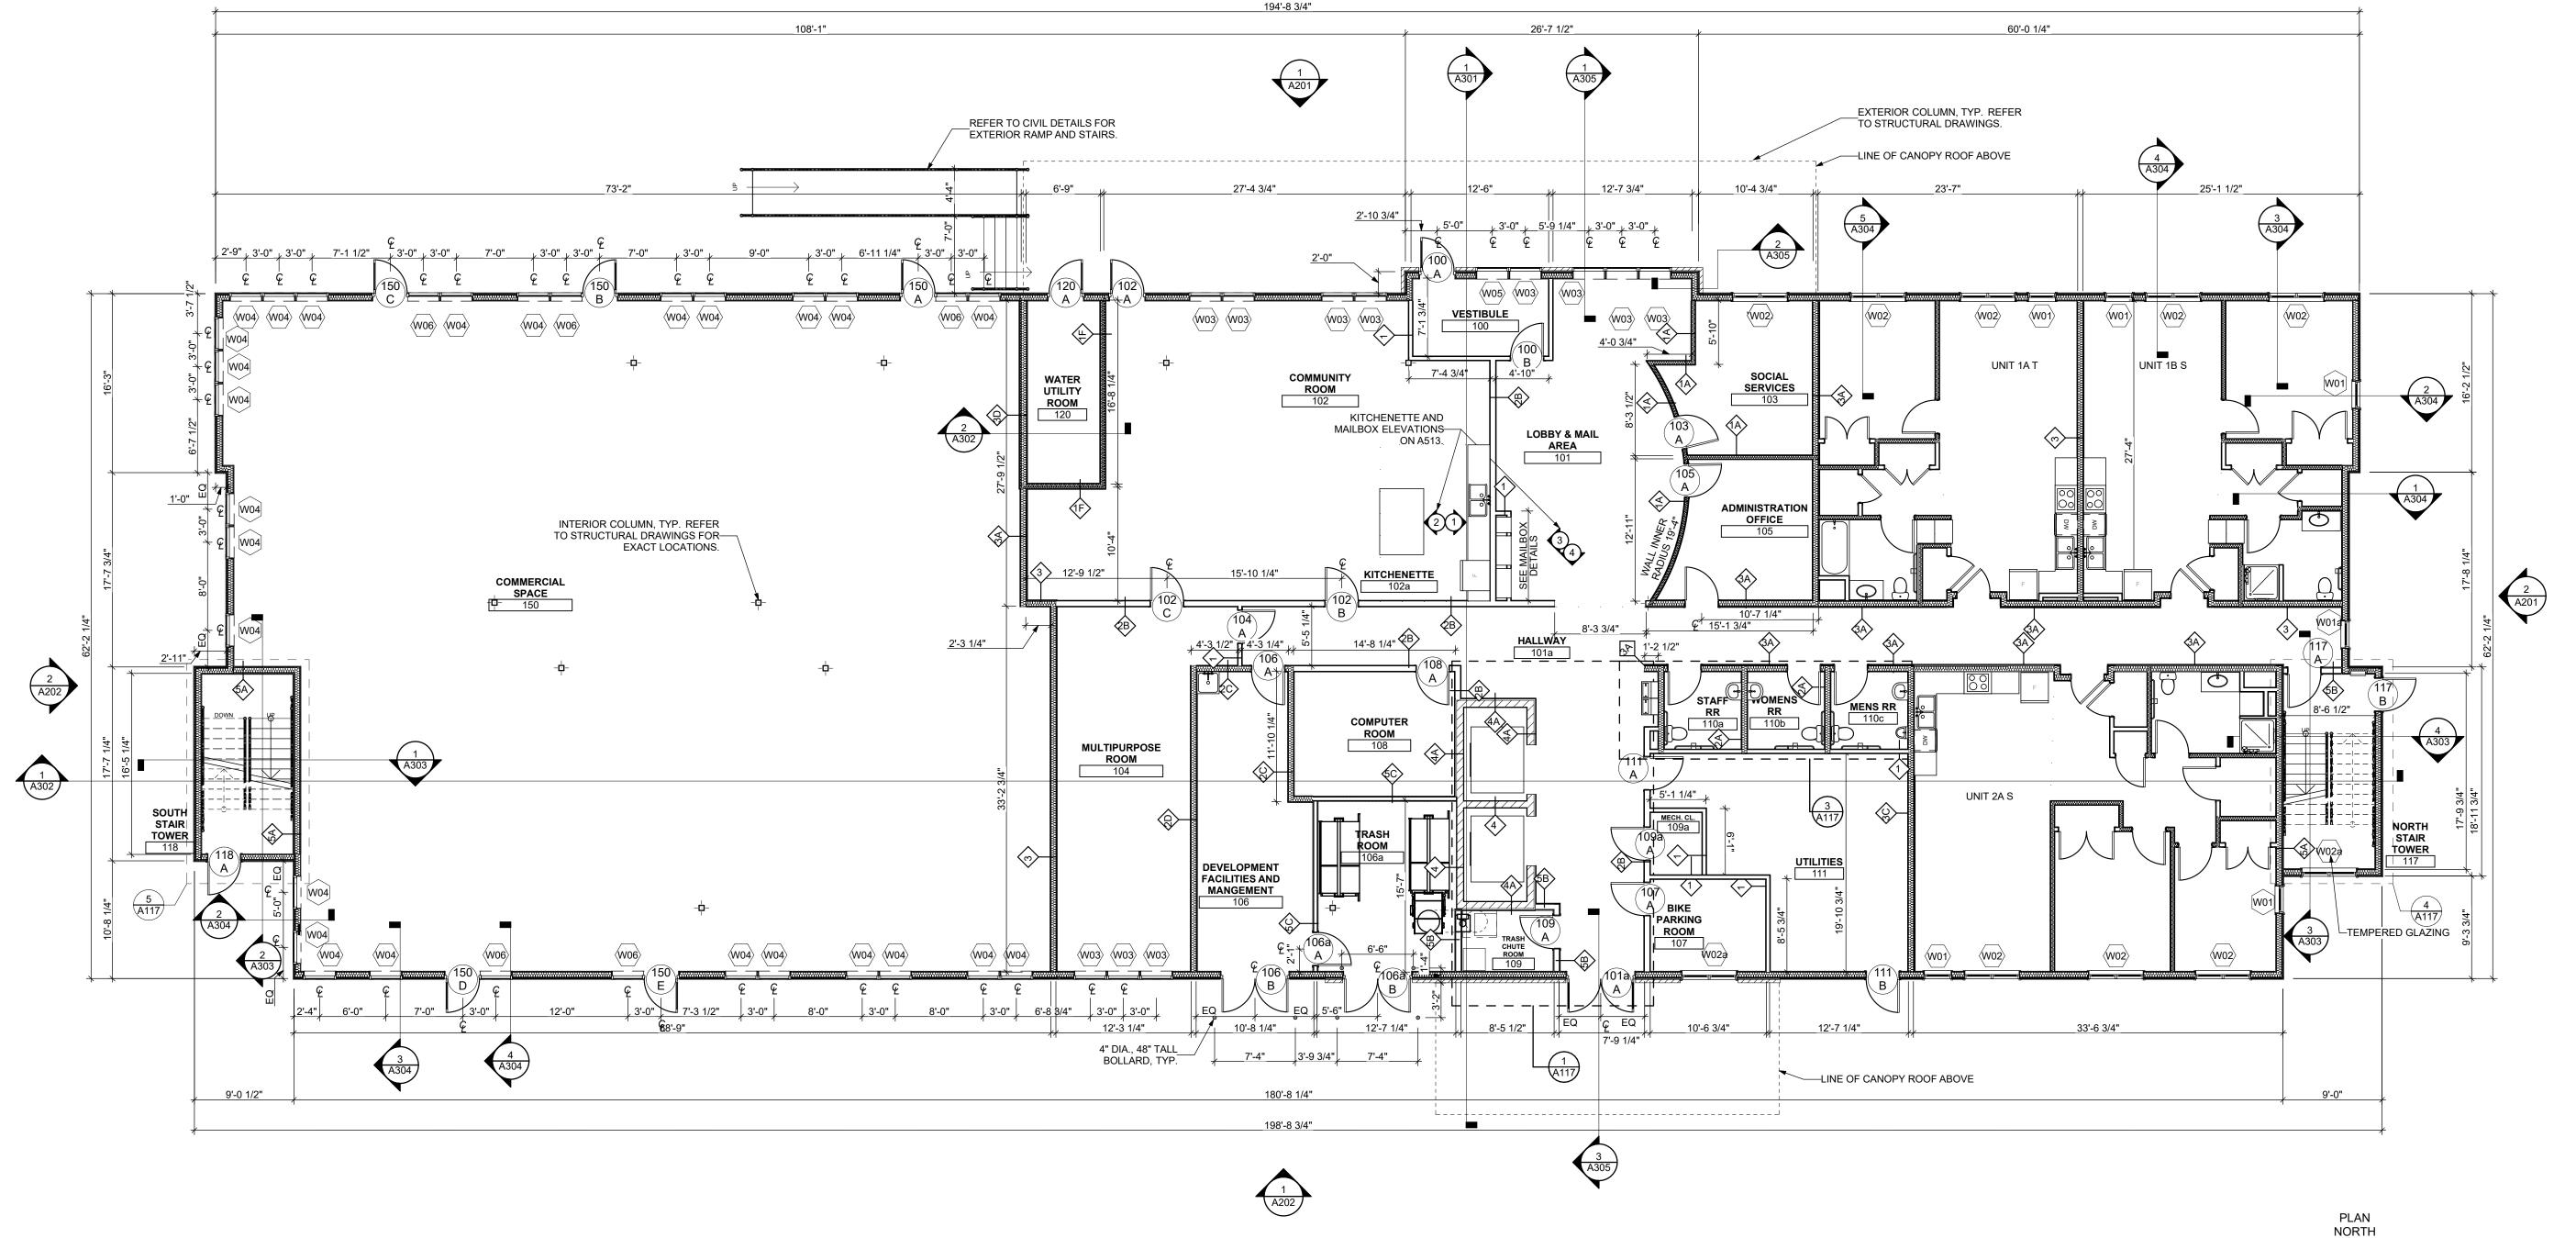

1ST FLOOR
SCALE: 1/8" = 1'-0"



WINDOW AND WINOW NUMBER, REFER TO WINDOW SCHEDULE

WALL TYPE, REFER TO WALL TYPES SHEET 13. PROVIDE WALL CORNER GUARDS (TEXTURED, VINYL 2" X 2" MIN.) ATALL OUTSIDE CORNERS IN ALL

REFER TO FINISH SCHEDULE. 14. PROVIDE SOLID BLOCKING FOR SUPPORT OF ALL BATH AND KITCHEN CABINETS, ALL TOILET ACCESSORIES. STAIR HANDRAILS. TOWEL BARS. BLINDS, CURTAIN RODS, MEDICINE CABINETS,

9. REFER TO ELEVATIONS AND SCHEDULE FOR WINDOW

10. REFER TO PLUBMING AND CIVIL PLANS FOR ALL

11. RADON STACK - PASSIVE RADON MIGITAGATION

SYSTEM. REFER TO PLUMBING DRAWINGS FOR

TYPICAL VENTING DETAIL. SYSTEM TO BE ACTIVATED

DRAIN AND CLEAN-OUT LOCATIONS.

TYPES AND SIZES.

IF NECESSARY.

- 15. FINISH ALL WALLS AND SIDES AROUND REMOVEABLE
- 16.ALL FIRST FLOOR ENTRANCES SHAL HAVE ZERO-
- 17.ALL UNIT WINDOWS MUST BE EQUIPPED WITH A CURTAIN ROD AND HORIZONTAL BLINDS, VERTICAL BLINDS, OR OTHER OPAQUE BLINDS. REFER TO
- PROTECTION CONTRACTORS TO COORDIATE WITH THE GENERAL CONTRACTOR FOR THE LOCATION OF ALL ELECTRICAL, MECHANICAL, PLUMBING, FIRE PROTECTION EQUIPMENT PRIOR TO INSTALLATION. REFER TO M.E.P.FP DRAWINGS. VERIFY REQUIRED ADEQUATE CLEARANCES FOR MECHANICAL AND PLUMBING EQUIPMENT WITH SUPPLIERS SPECIFICATIONS BEFORE INSTALLATION OF EQUIPMENT AND LOCATING UTILITY ROOM WALLS AND DOORS.
- STRUCTURAL ELEMENTS AND SPECIFICATIONS FOR THIS PROJECT.
- RESISTANT GYP. 21.REFER TO A505 FOR AIR SEALING NOTES.

Any conflicts in the drawings or between new and existing construction shall be referred to the Architect. 2. Contractor shall verify all dimensions and existing

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- conditions in the field and shall advise Fukui Architects, Pc of any discrepancies between, additions to, deletions from, or alterations to any and all conditions prior to proceeding with any phase of work. Do not scale
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revisions

project title

general notes

Owner:

HACP 200 Ross Street Pittsburgh,PA,15219

Client:

Allies & Ross Management and Development Corporation (ARMDC) 200 Ross Street Pittsburgh, PA 15219

Project Location:

Northview Heights Midrise 246 Penfort Street Pittsburgh, PA 15214


drawing title


SECOND FLOOR PLAN

As Noted December 3rd, 2023

Sheet No.

A103 Project #2040

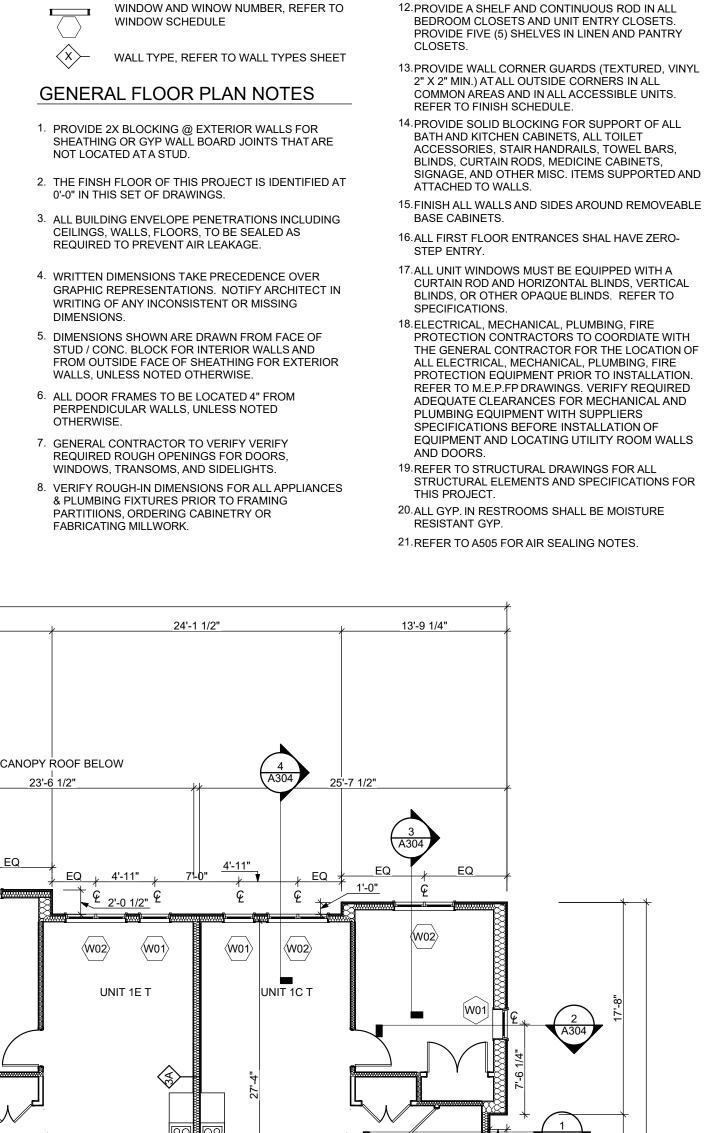

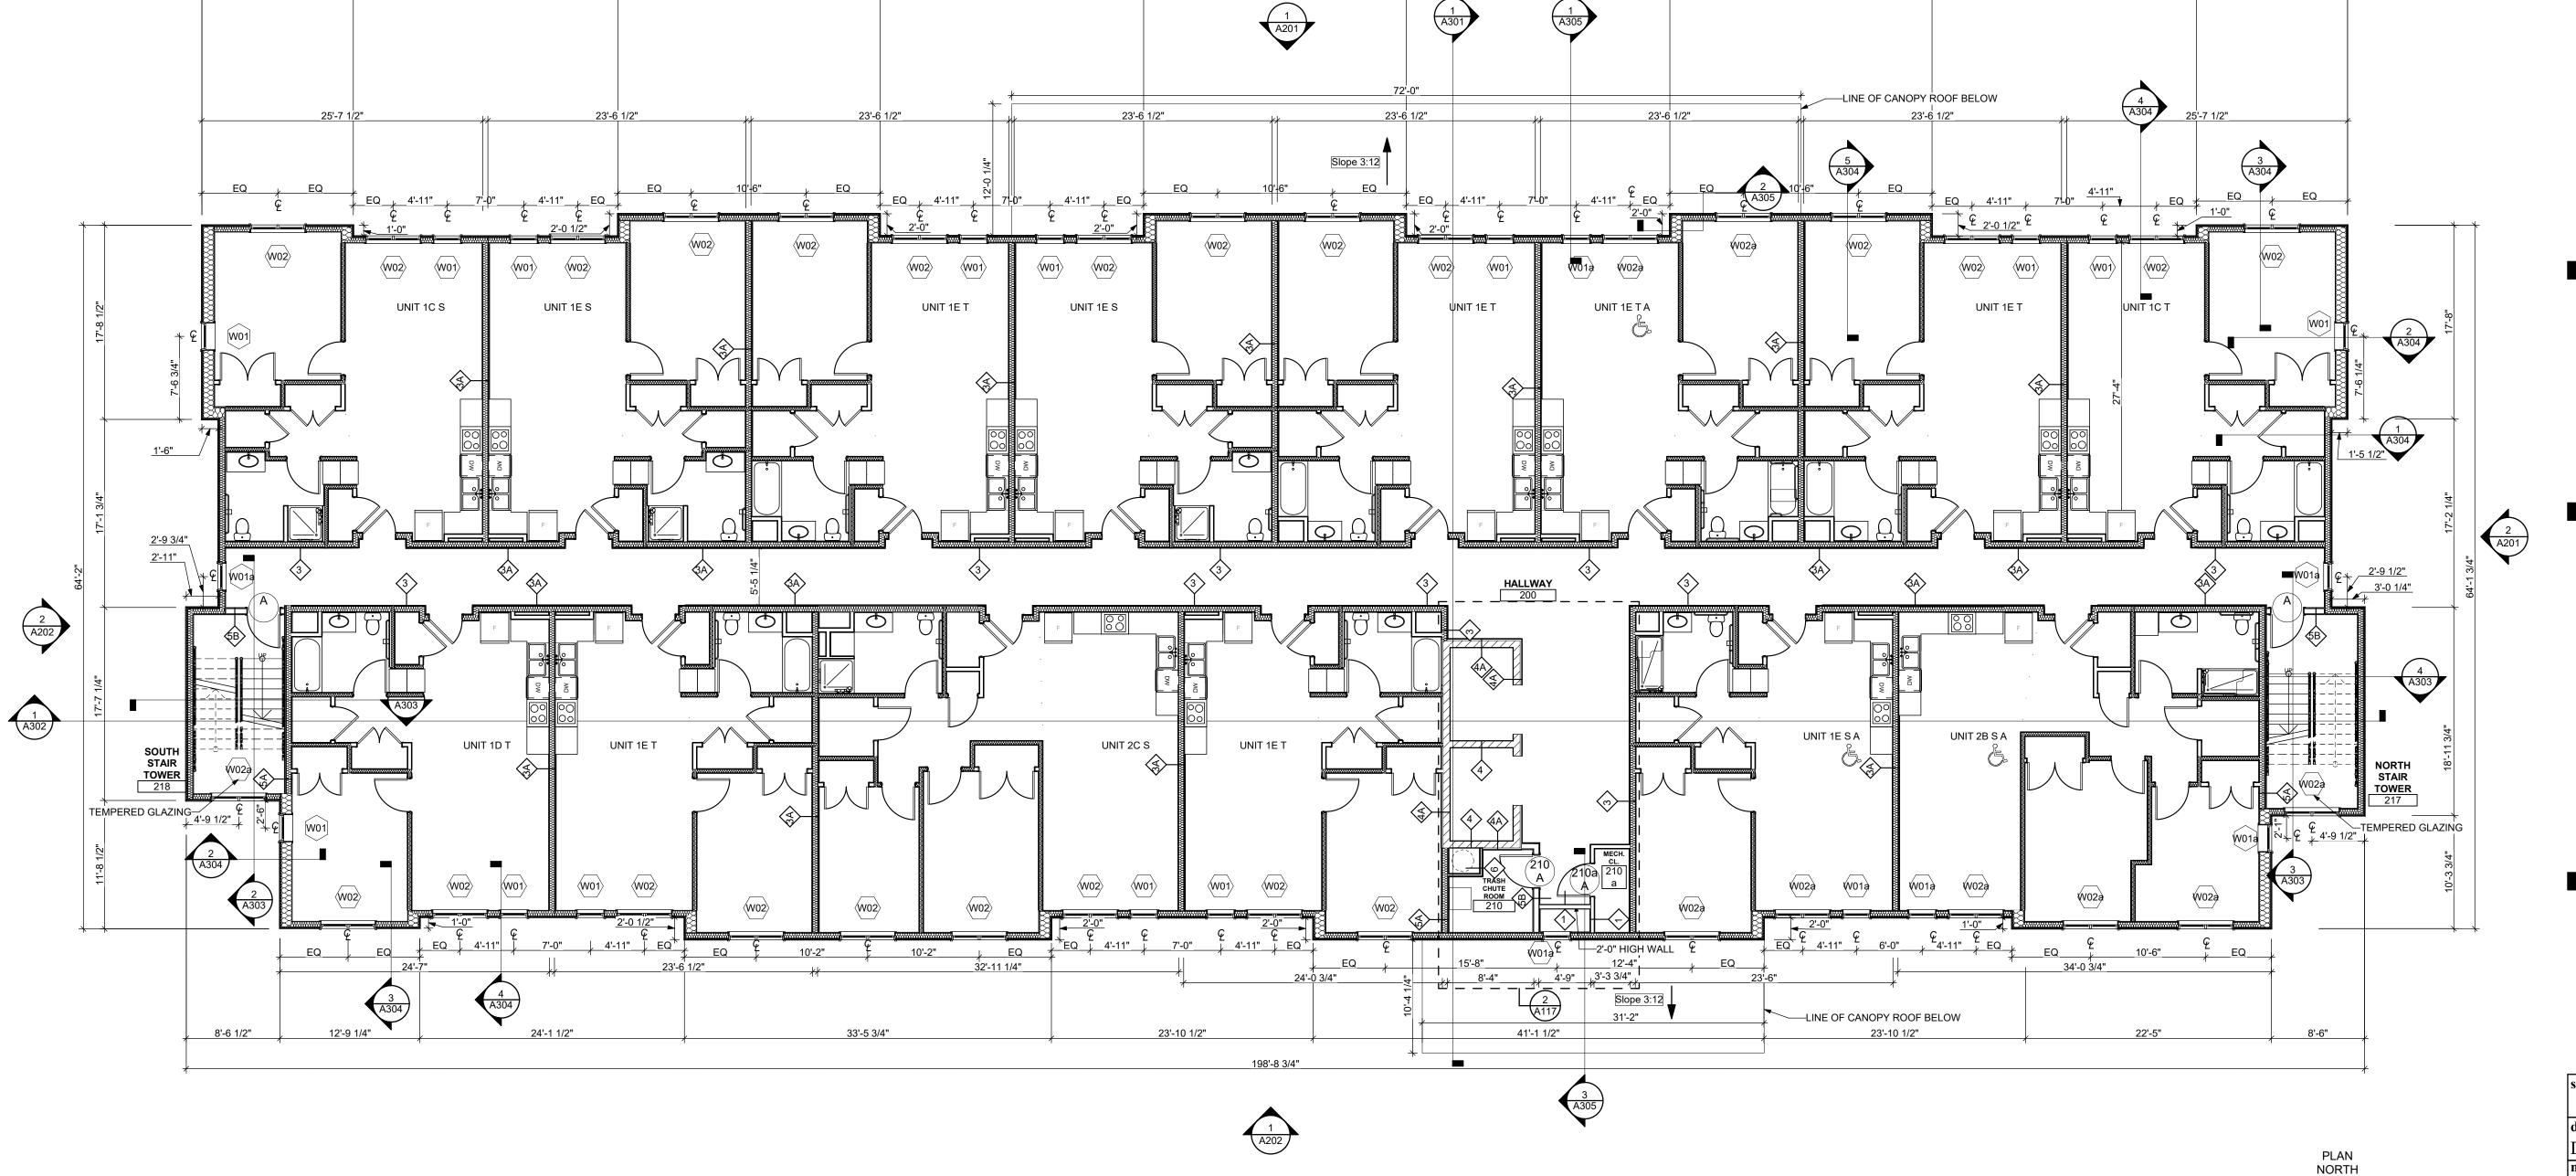

195'-8 3/4"

24'-0 1/2"

24'-0 1/2"

13'-9 3/4"

FLOOR PLAN LEGEND

ROOM NAME AND NUMBER

GENERAL FLOOR PLAN NOTES

PROVIDE 2X BLOCKING @ EXTERIOR WALLS FOR SHEATHING OR GYP WALL BOARD JOINTS THAT ARE NOT LOCATED AT A STUD.

2. THE FINSH FLOOR OF THIS PROJECT IS IDENTIFIED AT

3. ALL BUILDING ENVELOPE PENETRATIONS INCLUDING

CEILINGS, WALLS, FLOORS, TO BE SEALED AS

4. WRITTEN DIMENSIONS TAKE PRECEDENCE OVER

WRITING OF ANY INCONSISTENT OR MISSING

5. DIMENSIONS SHOWN ARE DRAWN FROM FACE OF

STUD / CONC. BLOCK FOR INTERIOR WALLS AND

FROM OUTSIDE FACE OF SHEATHING FOR EXTERIOR

GRAPHIC REPRESENTATIONS. NOTIFY ARCHITECT IN

REQUIRED TO PREVENT AIR LEAKAGE.

WALLS, UNLESS NOTED OTHERWISE.

6. ALL DOOR FRAMES TO BE LOCATED 4" FROM

7. GENERAL CONTRACTOR TO VERIFY VERIFY

REQUIRED ROUGH OPENINGS FOR DOORS, WINDOWS, TRANSOMS, AND SIDELIGHTS.

& PLUMBING FIXTURES PRIOR TO FRAMING

PARTITIONS, ORDERING CABINETRY OR

FABRICATING MILLWORK.

2'-0"

8. VERIFY ROUGH-IN DIMENSIONS FOR ALL APPLIANCES

24'-1 1/2"

PERPENDICULAR WALLS, UNLESS NOTED

0'-0" IN THIS SET OF DRAWINGS.

DIMENSIONS.

OTHERWISE.

—LINE OF CANOPY ROOF BELOW

—LINE OF CANOPY ROOF BELOW

23'-7 1/4"

23'-10 1/2"

DOOR AND DOOR NUMBER, REFER TO DOOR SCHEDULE

WINDOW AND WINOW NUMBER, REFER TO WINDOW SCHEDULE

BEDROOM CLOSETS AND UNIT ENTRY CLOSETS. PROVIDE FIVE (5) SHELVES IN LINEN AND PANTRY CLOSETS.

2" X 2" MIN.) ATALL OUTSIDE CORNERS IN ALL REFER TO FINISH SCHEDULE. 14. PROVIDE SOLID BLOCKING FOR SUPPORT OF ALL BATH AND KITCHEN CABINETS, ALL TOILET ACCESSORIES. STAIR HANDRAILS. TOWEL BARS.

ATTACHED TO WALLS. 15. FINISH ALL WALLS AND SIDES AROUND REMOVEABLE BASE CABINETS.

18. ELECTRICAL, MECHANICAL, PLUMBING, FIRE PROTECTION CONTRACTORS TO COORDIATE WITH THE GENERAL CONTRACTOR FOR THE LOCATION OF ALL ELECTRICAL, MECHANICAL, PLUMBING, FIRE PROTECTION EQUIPMENT PRIOR TO INSTALLATION. REFER TO M.E.P.FP DRAWINGS. VERIFY REQUIRED ADEQUATE CLEARANCES FOR MECHANICAL AND PLUMBING EQUIPMENT WITH SUPPLIERS SPECIFICATIONS BEFORE INSTALLATION OF EQUIPMENT AND LOCATING UTILITY ROOM WALLS AND DOORS.

19. REFER TO STRUCTURAL DRAWINGS FOR ALL STRUCTURAL ELEMENTS AND SPECIFICATIONS FOR THIS PROJECT.

21.REFER TO A505 FOR AIR SEALING NOTES.

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general notes

Any conflicts in the drawings or between new and existing construction shall be referred to the Architect.

2. Contractor shall verify all dimensions and existing conditions in the field and shall advise Fukui Architects, Pc of any discrepancies between, additions to, deletions from, or alterations to any and all conditions prior to proceeding with any phase of work. Do not scale

3. All work shall be installed in accordance with applicable codes and regulations.

4. Contractor shall be responsible for the patching, repairing, and preparations of all existing floor, wall, and ceiling surfaces as required to receive scheduled finishes.

5. All items shown on drawings are finished construction assemblies. Contractor shall provide and install all material required for finished assemblies.

6. All reports, plans, specifications, computer files, field data, notices, and other documents and instruments prepared by the Architect as instruments of service shall remain the property of the Architect. The Architect shall retain all common law statutory, and other reserved rights, including the copyright thereto.

revisions

project title

Owner:

A201

TEMPERED GLAZING

8'-6 1/2"

PLAN NORTH

HACP 200 Ross Street Pittsburgh,PA,15219

Client:

Allies & Ross Management and Development Corporation (ARMDC) 200 Ross Street Pittsburgh, PA 15219

Project Location:

Northview Heights Midrise 246 Penfort Street Pittsburgh, PA 15214


drawing title

THIRD FLOOR PLAN

Sheet No. As Noted December 3rd, 2023

A104

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WALL TYPE, REFER TO WALL TYPES SHEET

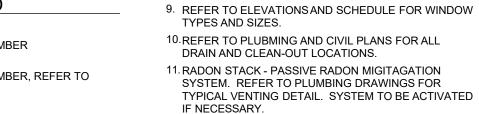12. PROVIDE A SHELF AND CONTINUOUS ROD IN ALL

13. PROVIDE WALL CORNER GUARDS (TEXTURED, VINYL COMMON AREAS AND IN ALL ACCESSIBLE UNITS.

BLINDS, CURTAIN RODS, MEDICINE CABINETS, SIGNAGE, AND OTHER MISC. ITEMS SUPPORTED AND

16.ALL FIRST FLOOR ENTRANCES SHAL HAVE ZERO-STEP ENTRY.

17.ALL UNIT WINDOWS MUST BE EQUIPPED WITH A CURTAIN ROD AND HORIZONTAL BLINDS, VERTICAL BLINDS, OR OTHER OPAQUE BLINDS. REFER TO SPECIFICATIONS.

20. ALL GYP. IN RESTROOMS SHALL BE MOISTURE RESISTANT GYP.

13'-9 1/4"

A202 1 A302 UNIT 1E S A UNIT 2C S UNIT 1E T UNIT 1E T TEMPERED GLAZING-W02 W02a W01a W02 W01a 2'-0" HIGH WALL 23'-6 1/2" 32'-11 1/4" 4'-9" | 3'-3 3/4"

33'-6 3/4"

UNIT 1E S

24'-1 1/2"

23'-10 1/2"

195'-8 1/4"

1 3RD FLOOR SCALE: 1/8" = 1'-0"

24'-1 1/2"


UNIT 1C S

UNIT 1E S


13'-9 1/4"

1'-6"

FLOOR PLAN LEGEND ROOM NAME AND NUMBER

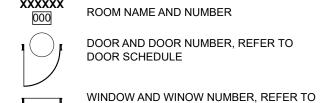

DOOR AND DOOR NUMBER, REFER TO DOOR SCHEDULE

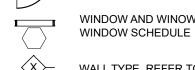

WALL TYPE, REFER TO WALL TYPES SHEET

GENERAL FLOOR PLAN NOTES

- PROVIDE 2X BLOCKING @ EXTERIOR WALLS FOR SHEATHING OR GYP WALL BOARD JOINTS THAT ARE NOT LOCATED AT A STUD.
- 2. THE FINSH FLOOR OF THIS PROJECT IS IDENTIFIED AT 0'-0" IN THIS SET OF DRAWINGS.
- 3. ALL BUILDING ENVELOPE PENETRATIONS INCLUDING CEILINGS, WALLS, FLOORS, TO BE SEALED AS

REQUIRED TO PREVENT AIR LEAKAGE.

- 4. WRITTEN DIMENSIONS TAKE PRECEDENCE OVER GRAPHIC REPRESENTATIONS. NOTIFY ARCHITECT IN WRITING OF ANY INCONSISTENT OR MISSING DIMENSIONS.
- 5. DIMENSIONS SHOWN ARE DRAWN FROM FACE OF STUD / CONC. BLOCK FOR INTERIOR WALLS AND FROM OUTSIDE FACE OF SHEATHING FOR EXTERIOR WALLS, UNLESS NOTED OTHERWISE.
- 6. ALL DOOR FRAMES TO BE LOCATED 4" FROM PERPENDICULAR WALLS, UNLESS NOTED OTHERWISE.
- 7. GENERAL CONTRACTOR TO VERIFY VERIFY REQUIRED ROUGH OPENINGS FOR DOORS, WINDOWS, TRANSOMS, AND SIDELIGHTS.

12'-4 3/4"

METAL FLASHED ROOF

UNIT 1G S

UNIT 2D S H/V

34'-0 1/4"

—LINE OF CANOPY ROOF BELOW

23'-10 1/2"

 $\begin{pmatrix} 5 \\ A304 \end{pmatrix}$

UNIT 1G T A

W01a

-LINE OF ROOF ABOVE

W02a

8. VERIFY ROUGH-IN DIMENSIONS FOR ALL APPLIANCES & PLUMBING FIXTURES PRIOR TO FRAMING PARTITIONS, ORDERING CABINETRY OR FABRICATING MILLWORK.

- 9. REFER TO ELEVATIONS AND SCHEDULE FOR WINDOW TYPES AND SIZES.
- 10. REFER TO PLUBMING AND CIVIL PLANS FOR ALL DRAIN AND CLEAN-OUT LOCATIONS.
- 11. RADON STACK PASSIVE RADON MIGITAGATION SYSTEM. REFER TO PLUMBING DRAWINGS FOR TYPICAL VENTING DETAIL. SYSTEM TO BE ACTIVATED IF NECESSARY.
- 12. PROVIDE A SHELF AND CONTINUOUS ROD IN ALL BEDROOM CLOSETS AND UNIT ENTRY CLOSETS. PROVIDE FIVE (5) SHELVES IN LINEN AND PANTRY CLOSETS.
- 13. PROVIDE WALL CORNER GUARDS (TEXTURED, VINYL 2" X 2" MIN.) ATALL OUTSIDE CORNERS IN ALL COMMON AREAS AND IN ALL ACCESSIBLE UNITS.
- REFER TO FINISH SCHEDULE. 14. PROVIDE SOLID BLOCKING FOR SUPPORT OF ALL BATH AND KITCHEN CABINETS, ALL TOILET ACCESSORIES, STAIR HANDRAILS, TOWEL BARS, BLINDS, CURTAIN RODS, MEDICINE CABINETS, SIGNAGE, AND OTHER MISC. ITEMS SUPPORTED AND
- ATTACHED TO WALLS. 15. FINISH ALL WALLS AND SIDES AROUND REMOVEABLE BASE CABINETS.
- 16.ALL FIRST FLOOR ENTRANCES SHAL HAVE ZERO-STEP ENTRY.
- 17.ALL UNIT WINDOWS MUST BE EQUIPPED WITH A CURTAIN ROD AND HORIZONTAL BLINDS, VERTICAL BLINDS, OR OTHER OPAQUE BLINDS. REFER TO SPECIFICATIONS.
- 18. ELECTRICAL, MECHANICAL, PLUMBING, FIRE PROTECTION CONTRACTORS TO COORDIATE WITH THE GENERAL CONTRACTOR FOR THE LOCATION OF ALL ELECTRICAL, MECHANICAL, PLUMBING, FIRE PROTECTION EQUIPMENT PRIOR TO INSTALLATION. REFER TO M.E.P.FP DRAWINGS. VERIFY REQUIRED ADEQUATE CLEARANCES FOR MECHANICAL AND PLUMBING EQUIPMENT WITH SUPPLIERS SPECIFICATIONS BEFORE INSTALLATION OF EQUIPMENT AND LOCATING UTILITY ROOM WALLS AND DOORS.
- 19. REFER TO STRUCTURAL DRAWINGS FOR ALL STRUCTURAL ELEMENTS AND SPECIFICATIONS FOR THIS PROJECT. 20. ALL GYP. IN RESTROOMS SHALL BE MOISTURE

A304 F

TEMPERED GLAZING

RESISTANT GYP. 21.REFER TO A505 FOR AIR SEALING NOTES.

13'-10 3/4"

MECH.
ROOF DECK
415a

B LAUNDRY W01a ROOM 415

general notes

Any conflicts in the drawings or between new and existing construction shall be referred to the Architect. 2. Contractor shall verify all dimensions and existing

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- conditions in the field and shall advise Fukui Architects, Pc of any discrepancies between, additions to, deletions from, or alterations to any and all conditions prior to proceeding with any phase of work. Do not scale
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- 4. Contractor shall be responsible for the patching, repairing, and preparations of all existing floor, wall, and ceiling surfaces as required to receive scheduled finishes.
- 5. All items shown on drawings are finished construction assemblies. Contractor shall provide and install all material required for finished assemblies.
- 6. All reports, plans, specifications, computer files, field data, notices, and other documents and instruments prepared by the Architect as instruments of service shall remain the property of the Architect. The Architect shall retain all common law statutory, and other reserved rights, including the copyright thereto.

revisions

project title

Owner: HACP

A201

200 Ross Street Pittsburgh,PA,15219

Client:

Allies & Ross Management and Development Corporation (ARMDC) 200 Ross Street Pittsburgh, PA 15219

Project Location:

Northview Heights Midrise 246 Penfort Street Pittsburgh, PA 15214

drawing title


FOURTH FLOOR PLAN

As Noted December 3rd, 2023

Sheet No.

A105 Project #2040

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195'-9"

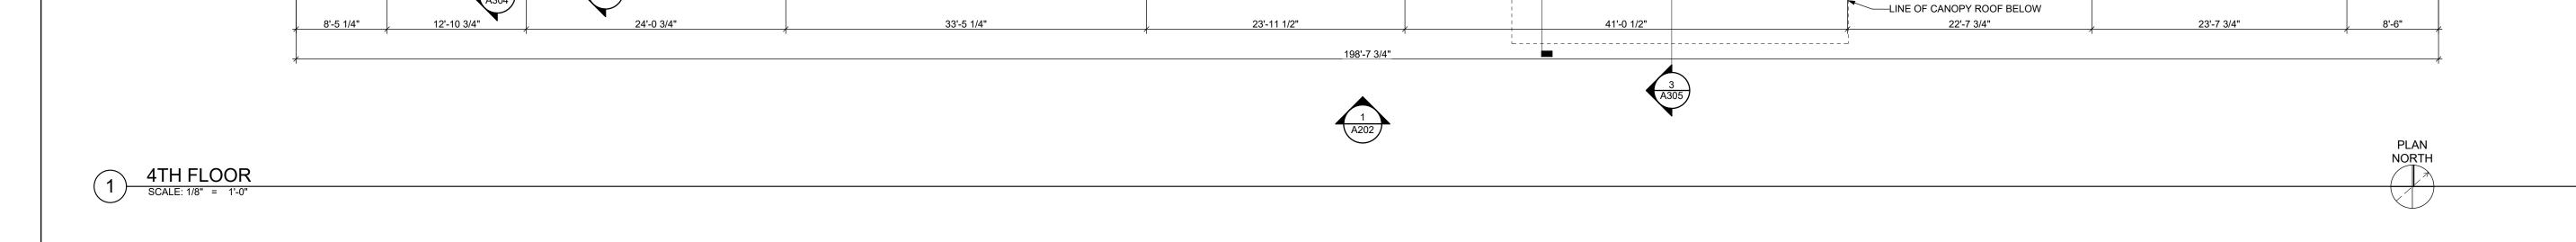 $\begin{pmatrix} 1 \\ A301 \end{pmatrix}$

FLASHED ROOF

UNIT 1G S

A305

UNIT 1G T

W01a 2'-0" HIGH WALL

4'-9" | 3'-3 3/4"

24'-0 3/4"

UNIT 1G S

W02

METAL FLASHED ROOF

UNIT 1G T

UNIT 2E T

W02

UNIT 1G S

METAL FLASHED ROOF

23'-10 1/2"

METAL FLASHED ROOF

UNIT 1G T

METAL FLASHED ROOF

UNIT 1F S

COMMUNAL ROOM 402

13'-8 3/4"

1'-6"

SOUTH STAIR TOWER 418

TEMPERED GLAZING-

2 A202

1 A302

VENTILATION CALCULATIONS

RIDGE VENTS:

TOTAL ATTIC AREA: 12,450 * 1/300 = 41.5 SQ. FT. = REQUIRED VENTED AREA.

41.5 * 0.4 = 16.6 SQ. FT. 41.5 * 0.5 = 20.75 SQ. FT.

@ 18 SQ. IN./LF = 20 SQ. FT. EAVE VENTS: 6+24+20+40+20+34+10+26+12+20+20+20+20+20+20+20+20 = 352 LIN. FT @ 9 SQ. IN./LF = 22 SQ. FT.

20+125+10+5 = 160 LIN. FT.

TOTAL VENTILATION: 20+22 = 42 SQ. FT.

RIDGE VENTS PROVIDE AT LEAST 40% AND NOT MORE THAN 50% OF THE REQUIRED VENTING AREA. RIDGE VENTS ARE LOCATED NOT MORE THAN 3 FEET BELOW TO RIDGE OR HIGHEST POINT IN THE ATTIC SPACE.

ROOF PLAN LEGDEND

ICE AND WATER SHIELD UNDERLAYMENT

ASPHALT SHINGLE ROOF, REFER TO

SPECIFICATIONS 12" X 12" BLOCK PATIO PAVERS, REFER TO

SPECIFICATIONS

1. ROOF PLANS ARE GRAPHICAL REFERANCES. USE DIMENSIONS OF FLOOR PLAN DRAWINGS TO DETERMINE TRUSS/JOIST LENGTHS. DIMENSIONS SHOWN ARE DRAWN FROM FINISHED FACE TO FINISHED FACE.

GENERAL ROOF PLAN NOTES

- 2. ALL ROOF PENETRATIONS SHALL BE PAINTED TO MATCH THE ROOF COLOR.
- 3. D.S. 3X4 DOWNSPOUT. REFER TO PLUMBING AND CIVIL DRAWINGS FOR DOWNSPOUT TERMINATION (SPLASH BLOCK OR STORMWATER TIE-IN).
- 4. EXACT ROOF TRUSS/JOIST LAYOUT AND DIMENSIONS ARE THE RESPONSIBILITY OF THE TRUSS FABRICATOR AND FRAMING SUBCONTRACTOR. TRUSS/JOIST LAYOUT SHALL BE COORDINATED WITH THE MECHANICAL, ELECTRICAL, PLUMBING CONTRACTORS PRIOR TO SUBMISSION OF TRUSS SHOP DRAWINGS, FABRICATION AND INSTALLATION TO ENSURE THE PROPSOED LAYOUT PROVIDES NECESSARY CLEARANCES FOR THE MECHANICAL, ELECTRICAL, AND PLUMBING TRADE ELEMENTS, FIXTURES, DUCTING, AND PIPING.
- 5. NO ROOF PENETRATIONS OR OR OPENINGS ARE PERMITTED WITHIN 4'-0" OF THE 1-HOUR DEMISING
- 6. ROOF SHEATHING TO BE 5/8" OSB SHEATHING EXCEPT FOR AREAS WITHIN 4'-0" OF THE 1-HOUR DEMISING WALLS. SHEATHING WITHIN 4'-0" OF THE 1-HOUR DEMISING WALLS TO BE 5/8" FIRE RETARDANT TREATED SHEATHING.
- 7. ALL ROOFS TO BE SLOPED 1/4" PER FT. MIN. ALL GUTTERS SHALL SLOPE 1/8" PER FT. TOWARDS DOWNWARD UNLESS NOTED OTHERWISE.
- 8. PROVIDE ICE AND WATER SHIELD UNDERLAYMENT AT ALL SHINGLED ROOF AREAS WITH SLOPES LESS THAN 4:12.

general notes

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revisions

project title

drawing title

Owner: HACP

200 Ross Street Pittsburgh,PA,15219

Client:

Allies & Ross Management and Development Corporation (ARMDC) 200 Ross Street Pittsburgh, PA 15219

Project Location:


Northview Heights Midrise 246 Penfort Street Pittsburgh, PA 15214


ROOF PLAN

As Noted December 3rd, 2023

A106

Sheet No.

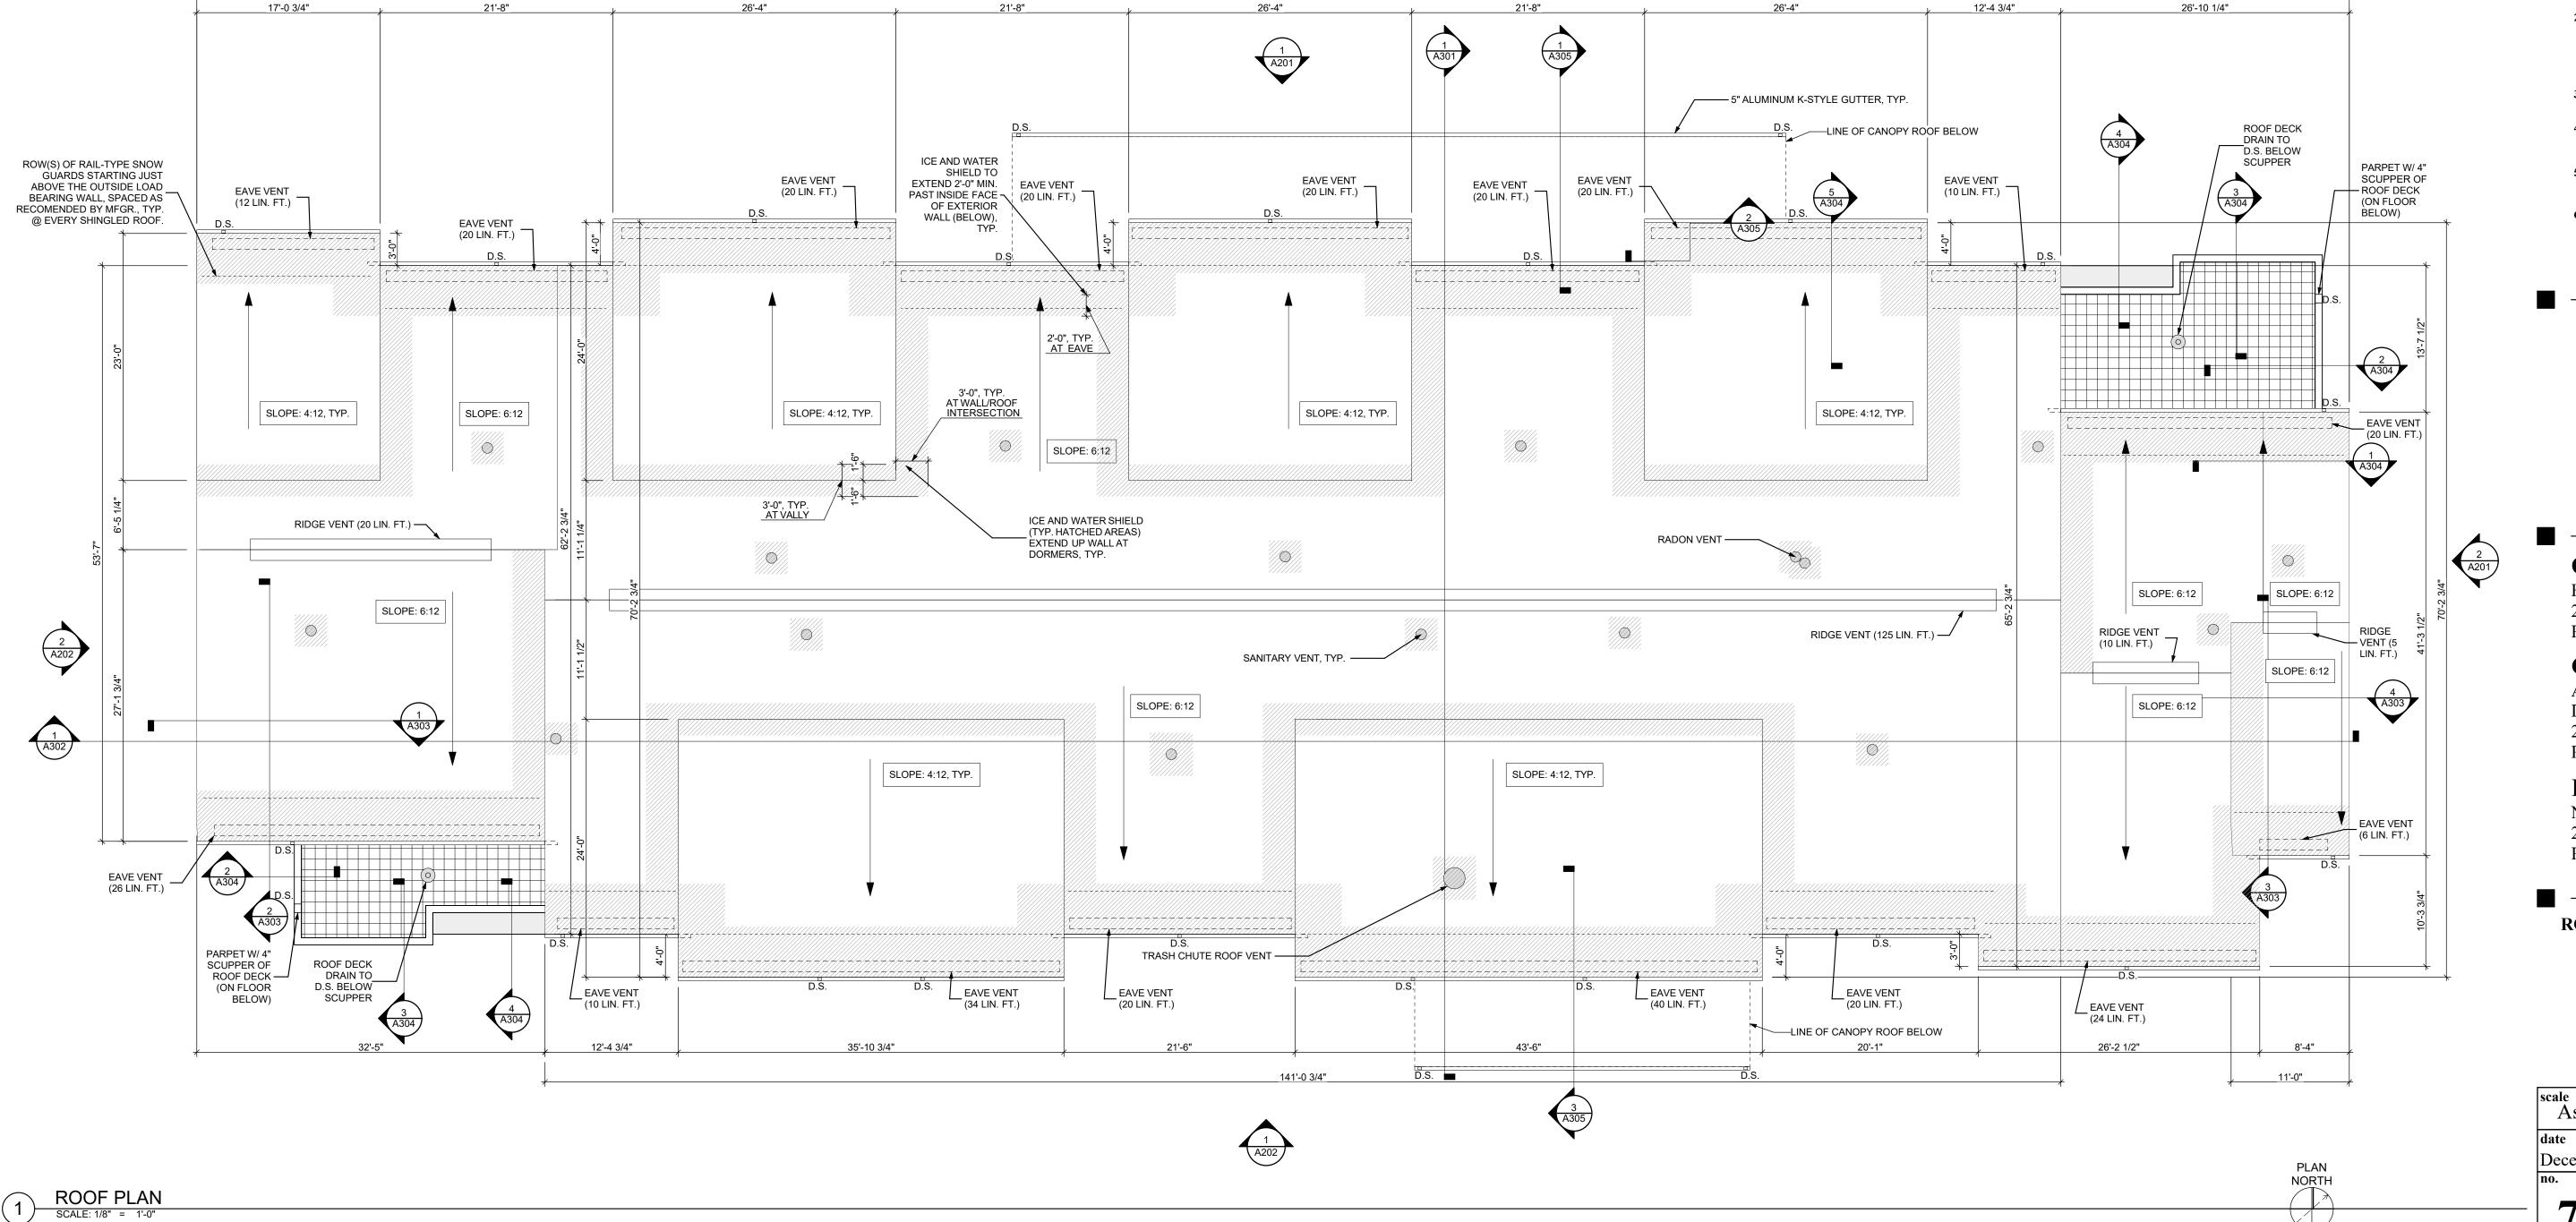

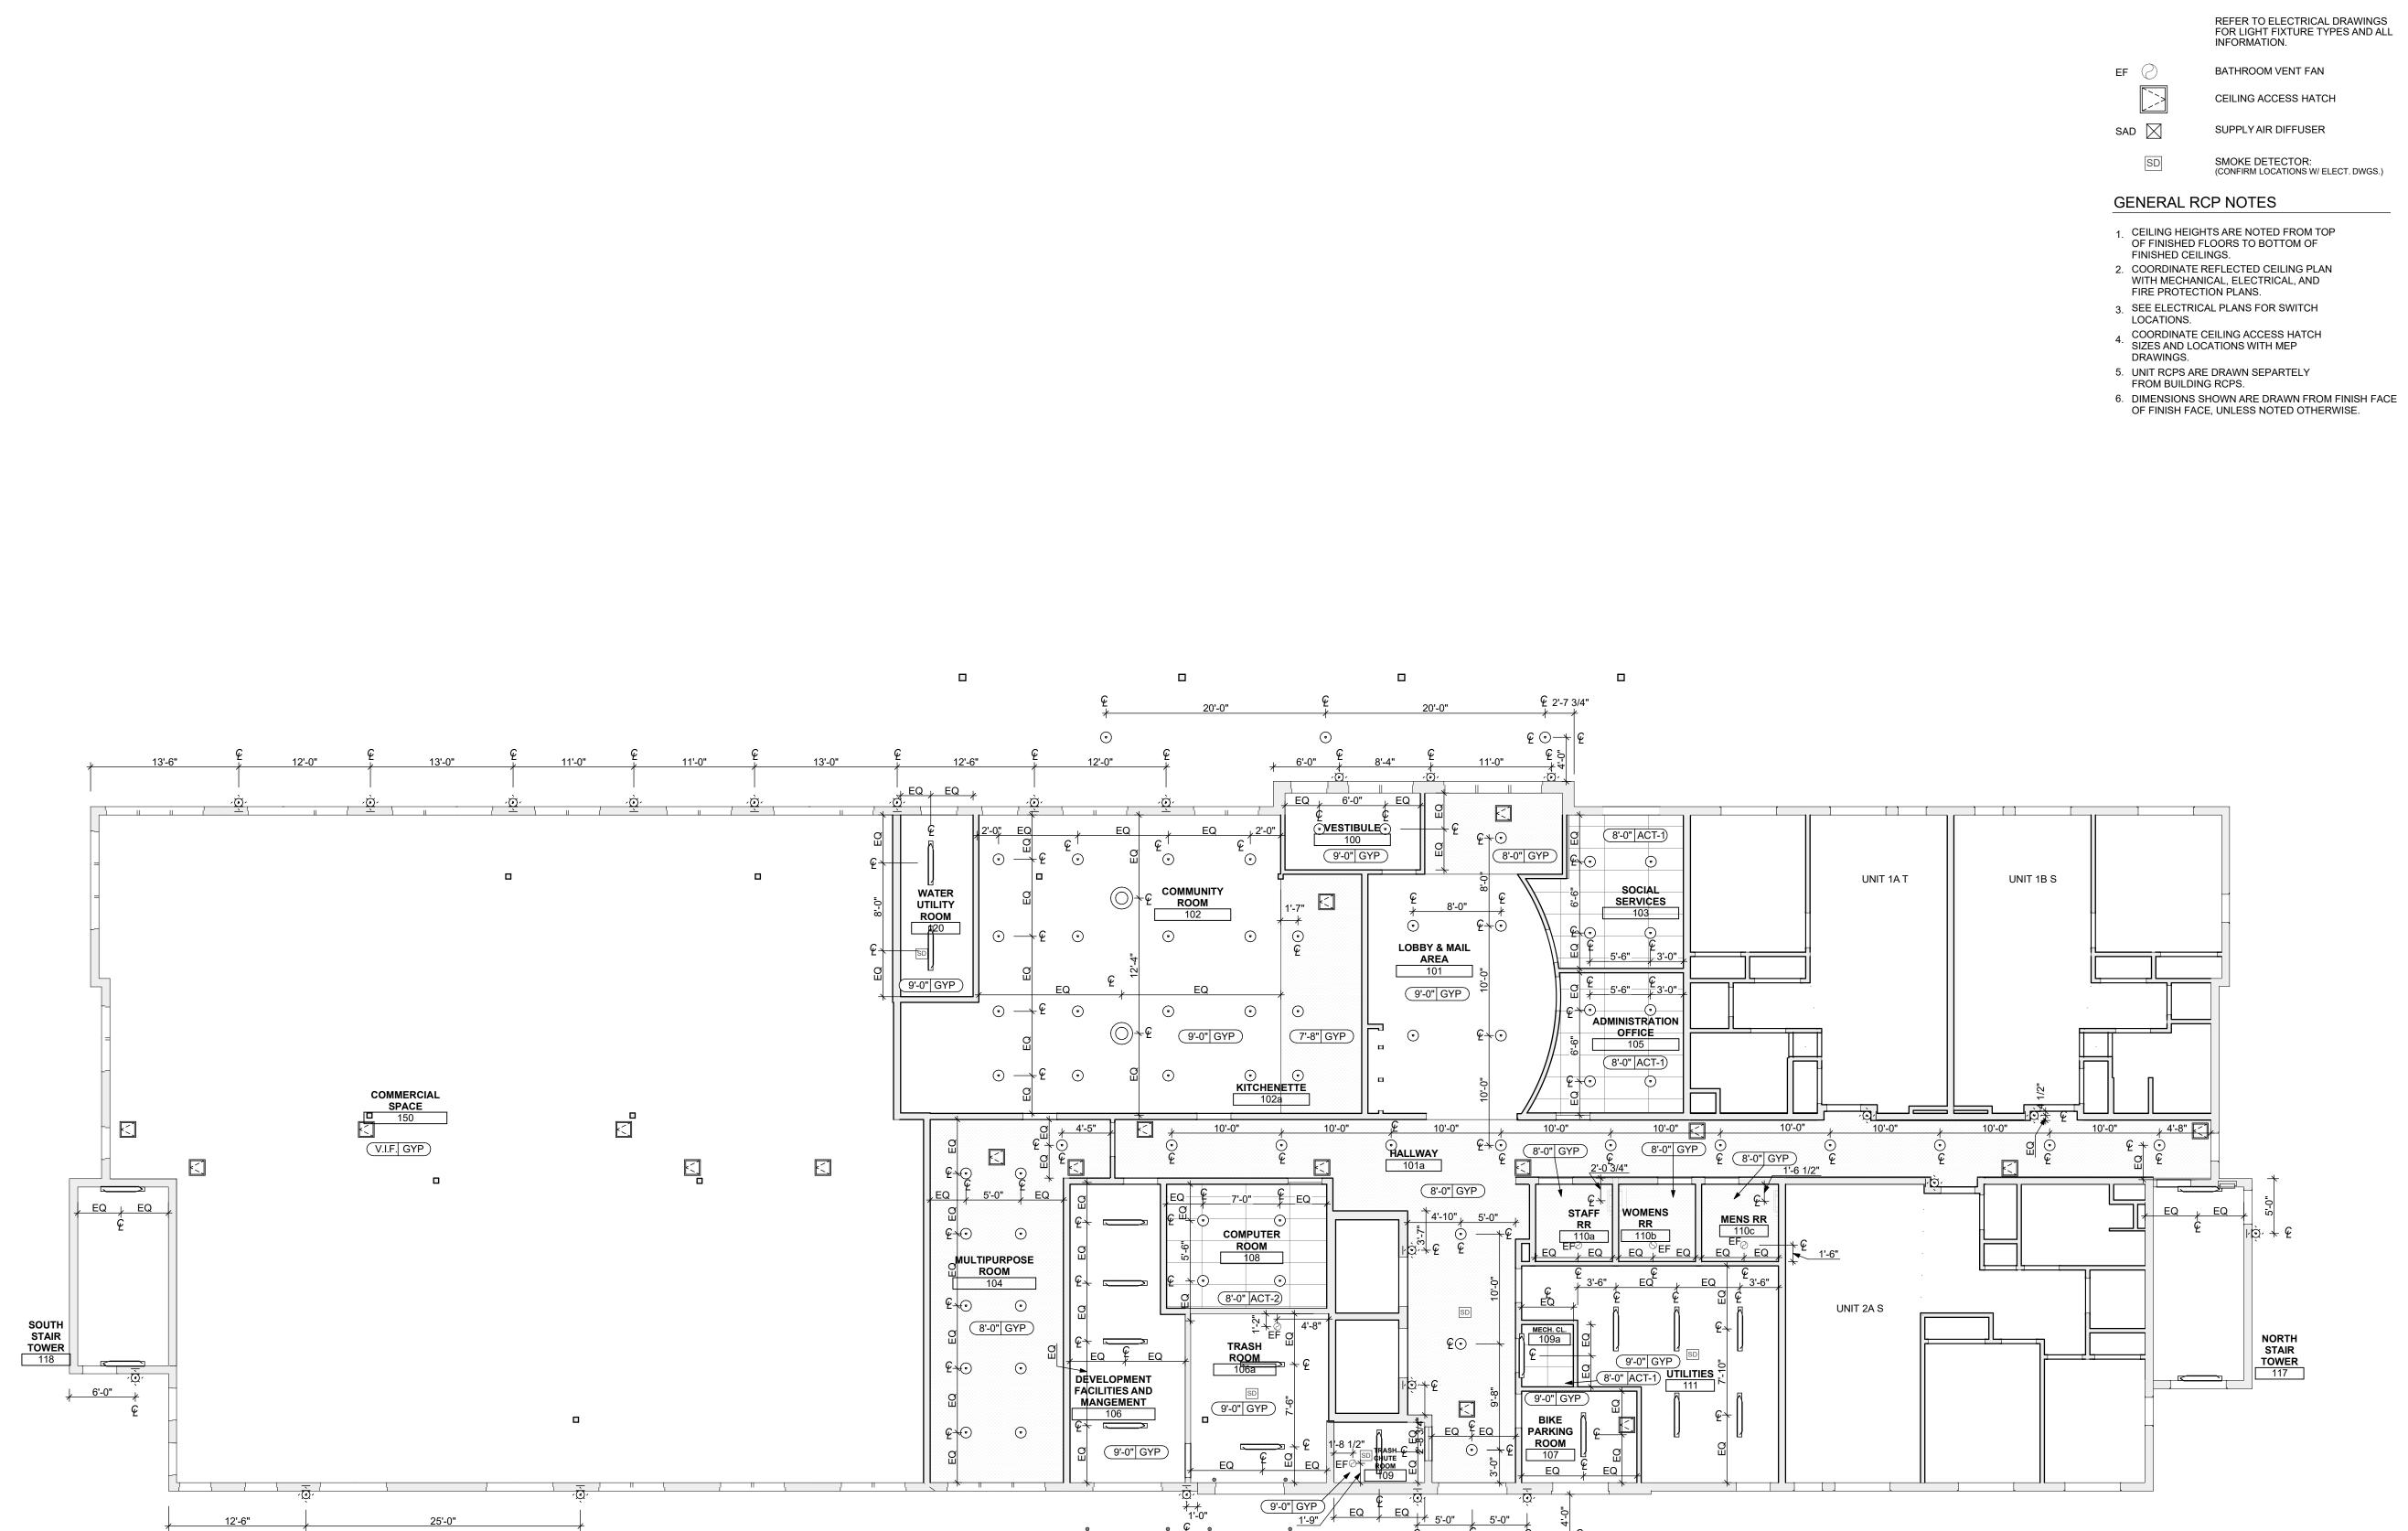

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CEILING TYPES

X 0'-0" CEILING MATERIAL AND HEIGHT

REFLECTED CEILING PLAN LEGEND

CEILING SOFFIT.

24" x 48" ACOUSTIC CEILING TILES

LIGHTING TYPES AND EQUIPMENT

sea

general notes

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revisions

project title

Owner:

HACP 200 Ross Street Pittsburgh,PA,15219

Client:

Allies & Ross Management and Development Corporation (ARMDC) 200 Ross Street Pittsburgh, PA 15219

Project Location:

Northview Heights Midrise 246 Penfort Street Pittsburgh, PA 15214

drawing title

FIRST FLOOR REFLECTED CEILING PLAN

As Noted

date
December 3rd, 2023


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PLAN NORTH A107

Project #2040

Sheet No.

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Fukui Architects Pc

CEILING TYPES

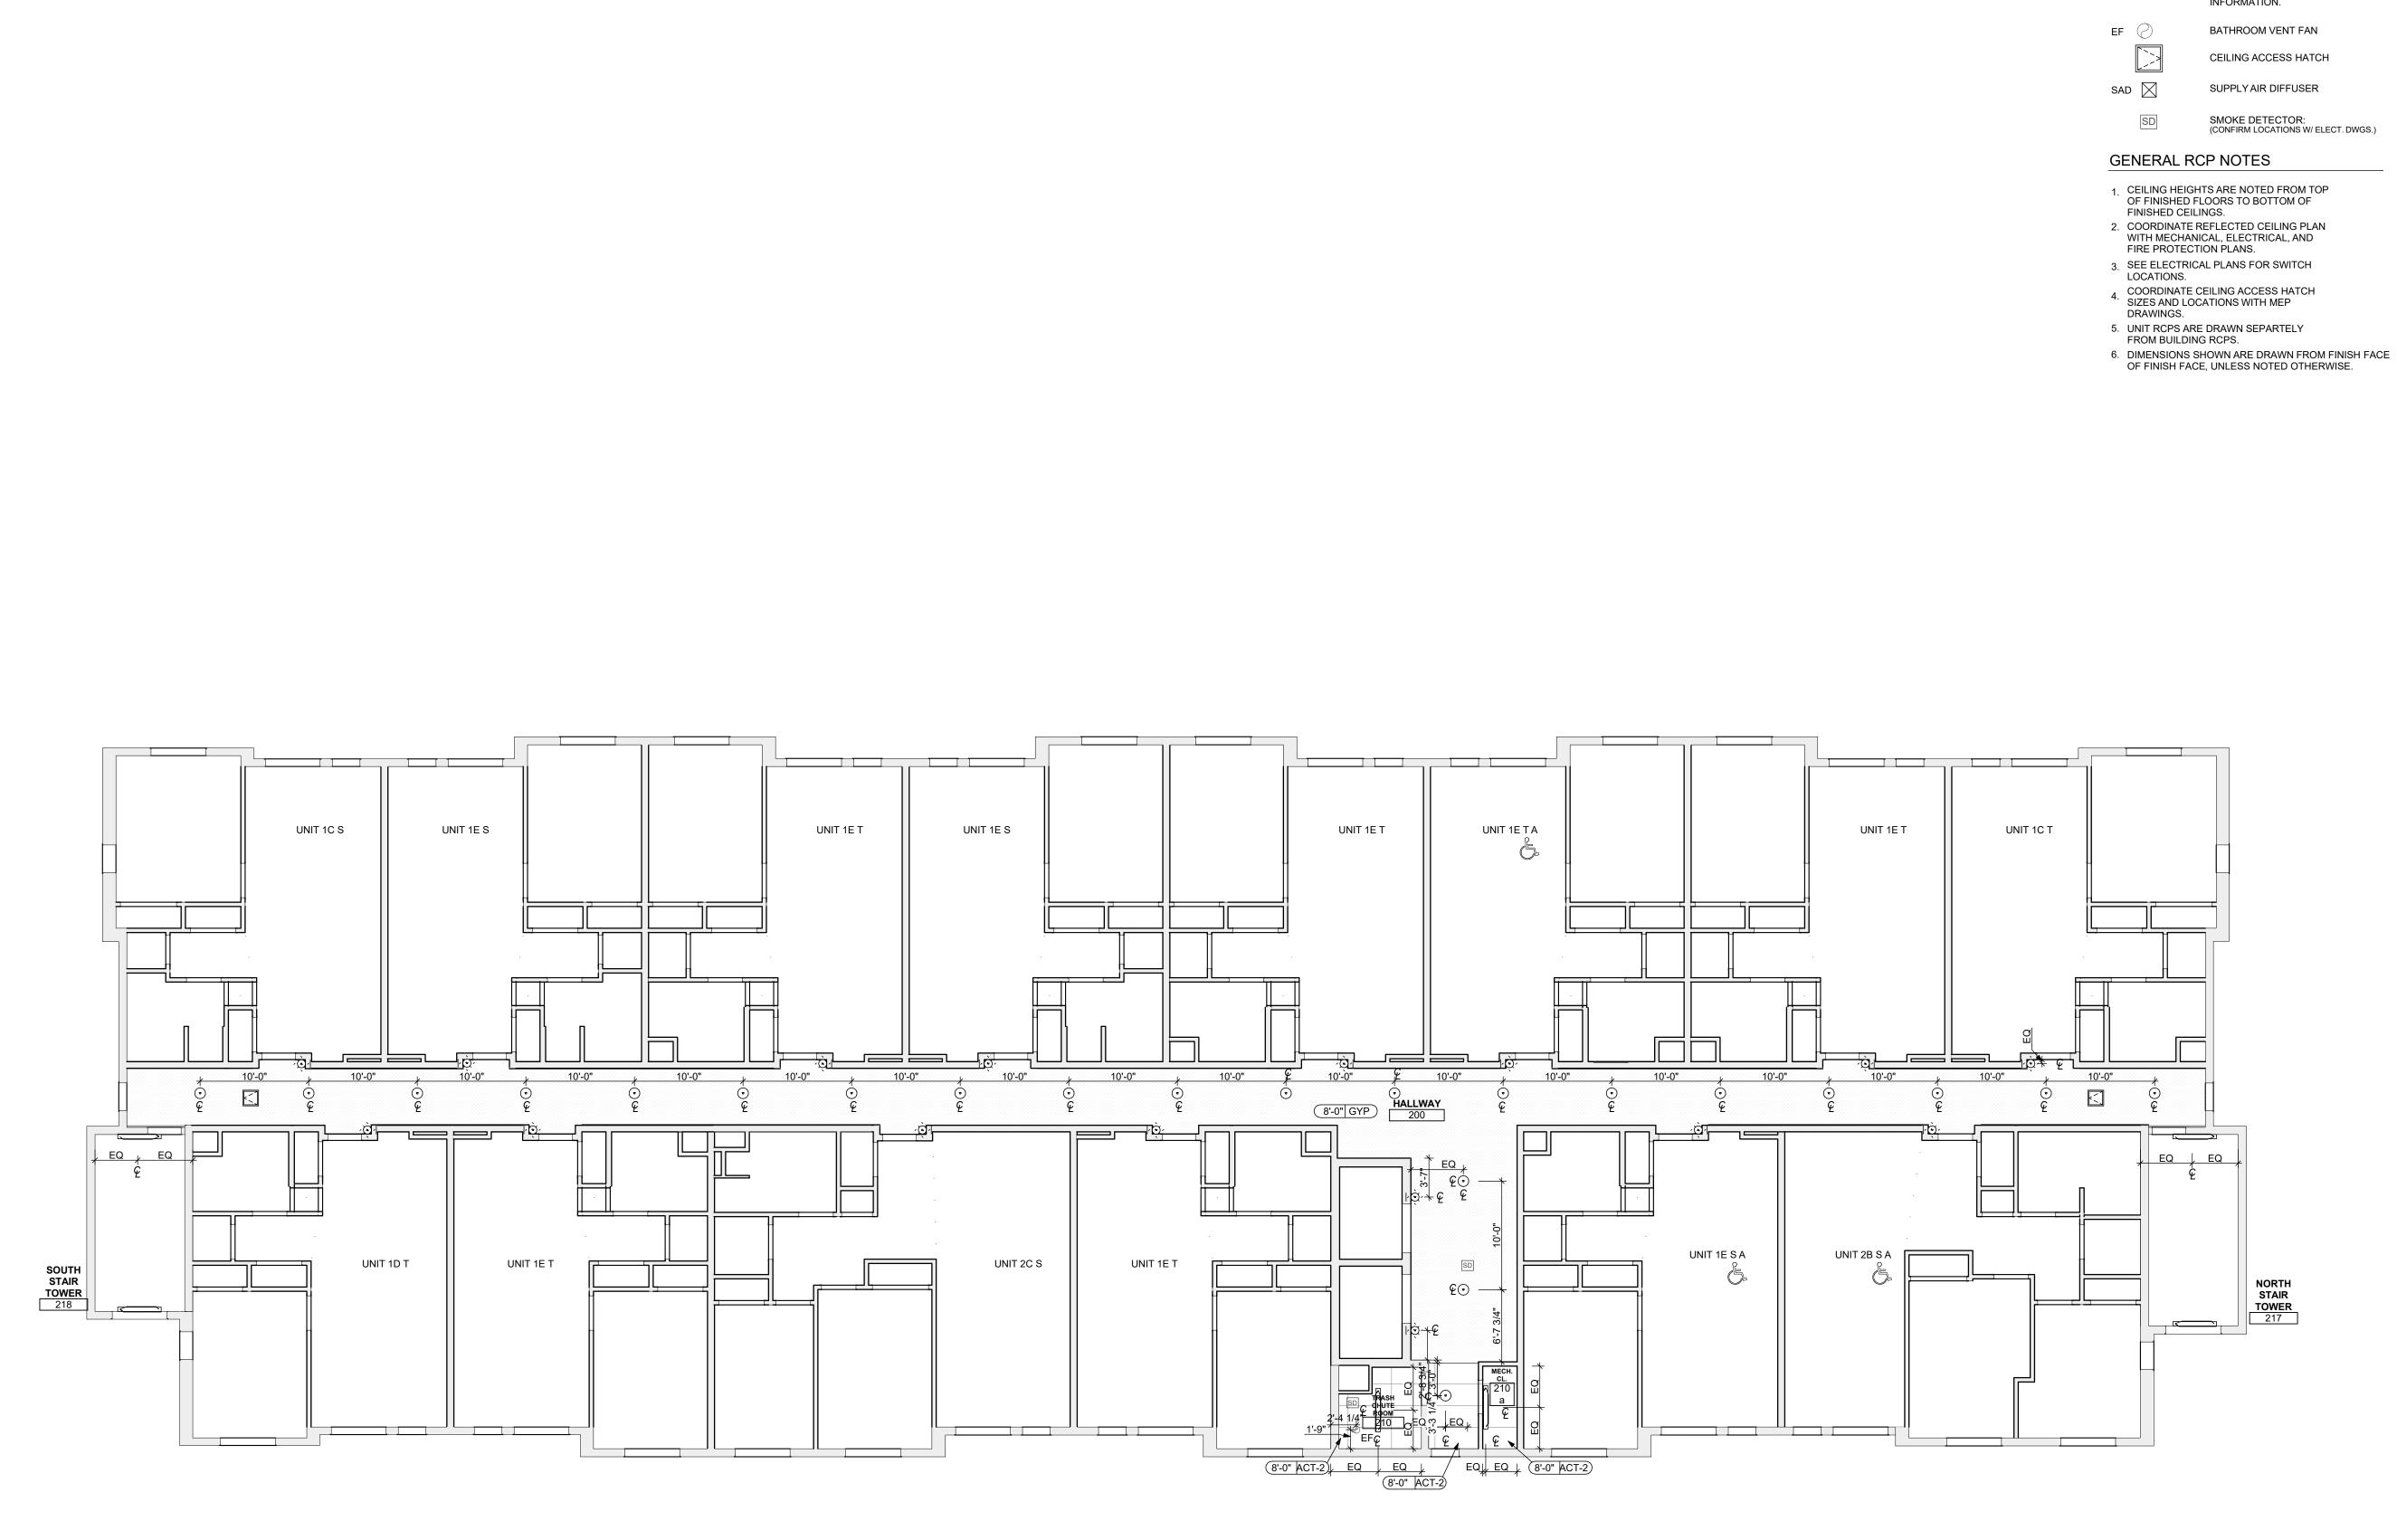X 0'-0" CEILING MATERIAL AND HEIGHT

REFLECTED CEILING PLAN LEGEND

CEILING SOFFIT.

24" x 48" ACOUSTIC CEILING TILES

LIGHTING TYPES AND EQUIPMENT

REFER TO ELECTRICAL DRAWINGS FOR LIGHT FIXTURE TYPES AND ALL INFORMATION.

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general notes

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revisions

project title

Owner:

HACP 200 Ross Street Pittsburgh,PA,15219

Client:

Allies & Ross Management and Development Corporation (ARMDC) 200 Ross Street Pittsburgh, PA 15219

Project Location:

Northview Heights Midrise 246 Penfort Street Pittsburgh, PA 15214

drawing title

SECOND FLOOR REFLECTED **CEILING PLAN**

As Noted December 3rd, 2023

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PLAN NORTH

Sheet No.

A108 Project #2040