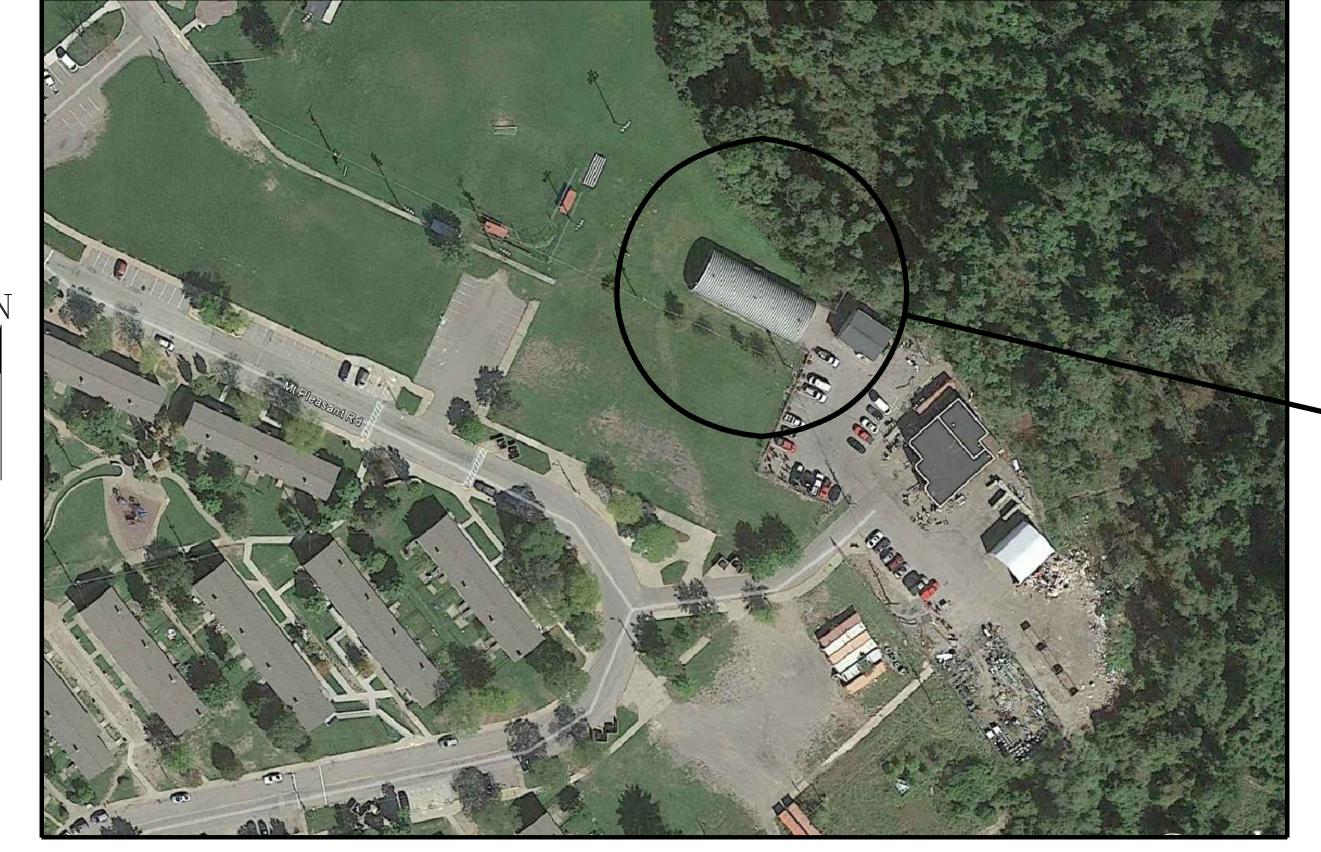
# HOUSING AUTHORITY of the CITY of PITTSBURGH

DEVELOPMENT AND MODERNIZATION DEPARTMENT 100 ROSS STREET, 2ND FLOOR PITTSBURGH, PENNSYLVANIA 15219


**HACP MANAGEMENT # 7381 TASK ORDER #38** REBUILDING OF THE **QUONSET HUT** NORTHVIEW HIGHRISE FACILITY **SERVICES SITE** 

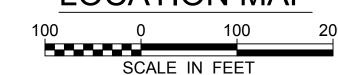**FEBRUARY 1, 2017** 



**NORTHVIEW HEIGHTS QUONSET HUT** 

## **LOCATION MAP**




## DRAWING INDEX

DRAWING NO. DESCRIPTION COVERSHEET CS ARCHITECTURAL - REPAIR WORK FLOOR PLAN, DETAILS AND PICTURES A-02 ARCHITECTURAL - REPAIR WORK ELEVATIONS AND DETAILS ARCHITECTURAL - REPAIR WORK FLOOR PLAN AND DETAILS A-03 HVAC - HVAC NOTES, SYMBOLS, LEGENDS, DETAILS AND SCHEDULES H-01 HVAC - PLAN AND NOTES E-01 ELECTRICAL - GENERAL NOTES, LEGEND, ABBREVIATIONS, DETAILS, BUILDING CODE, LIGHT FIXTURE SCHEDULE AND SITE PLAN ELECTRICAL - NEW WORK FLOOR PLAN AND SECTIONS E-02

ELECTRICAL - PICTURES, DETAILS AND PANELBOARD SCHEDULE
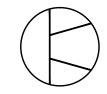
## PROJECT TEAM:



D & D ENGINEERING, INC.



## Tusick & Associates Architects, Inc.

21 WINDSOR ROAD PITTSBURGH, PA 15215

412-781-6947 email: info@tusickarchitects.com

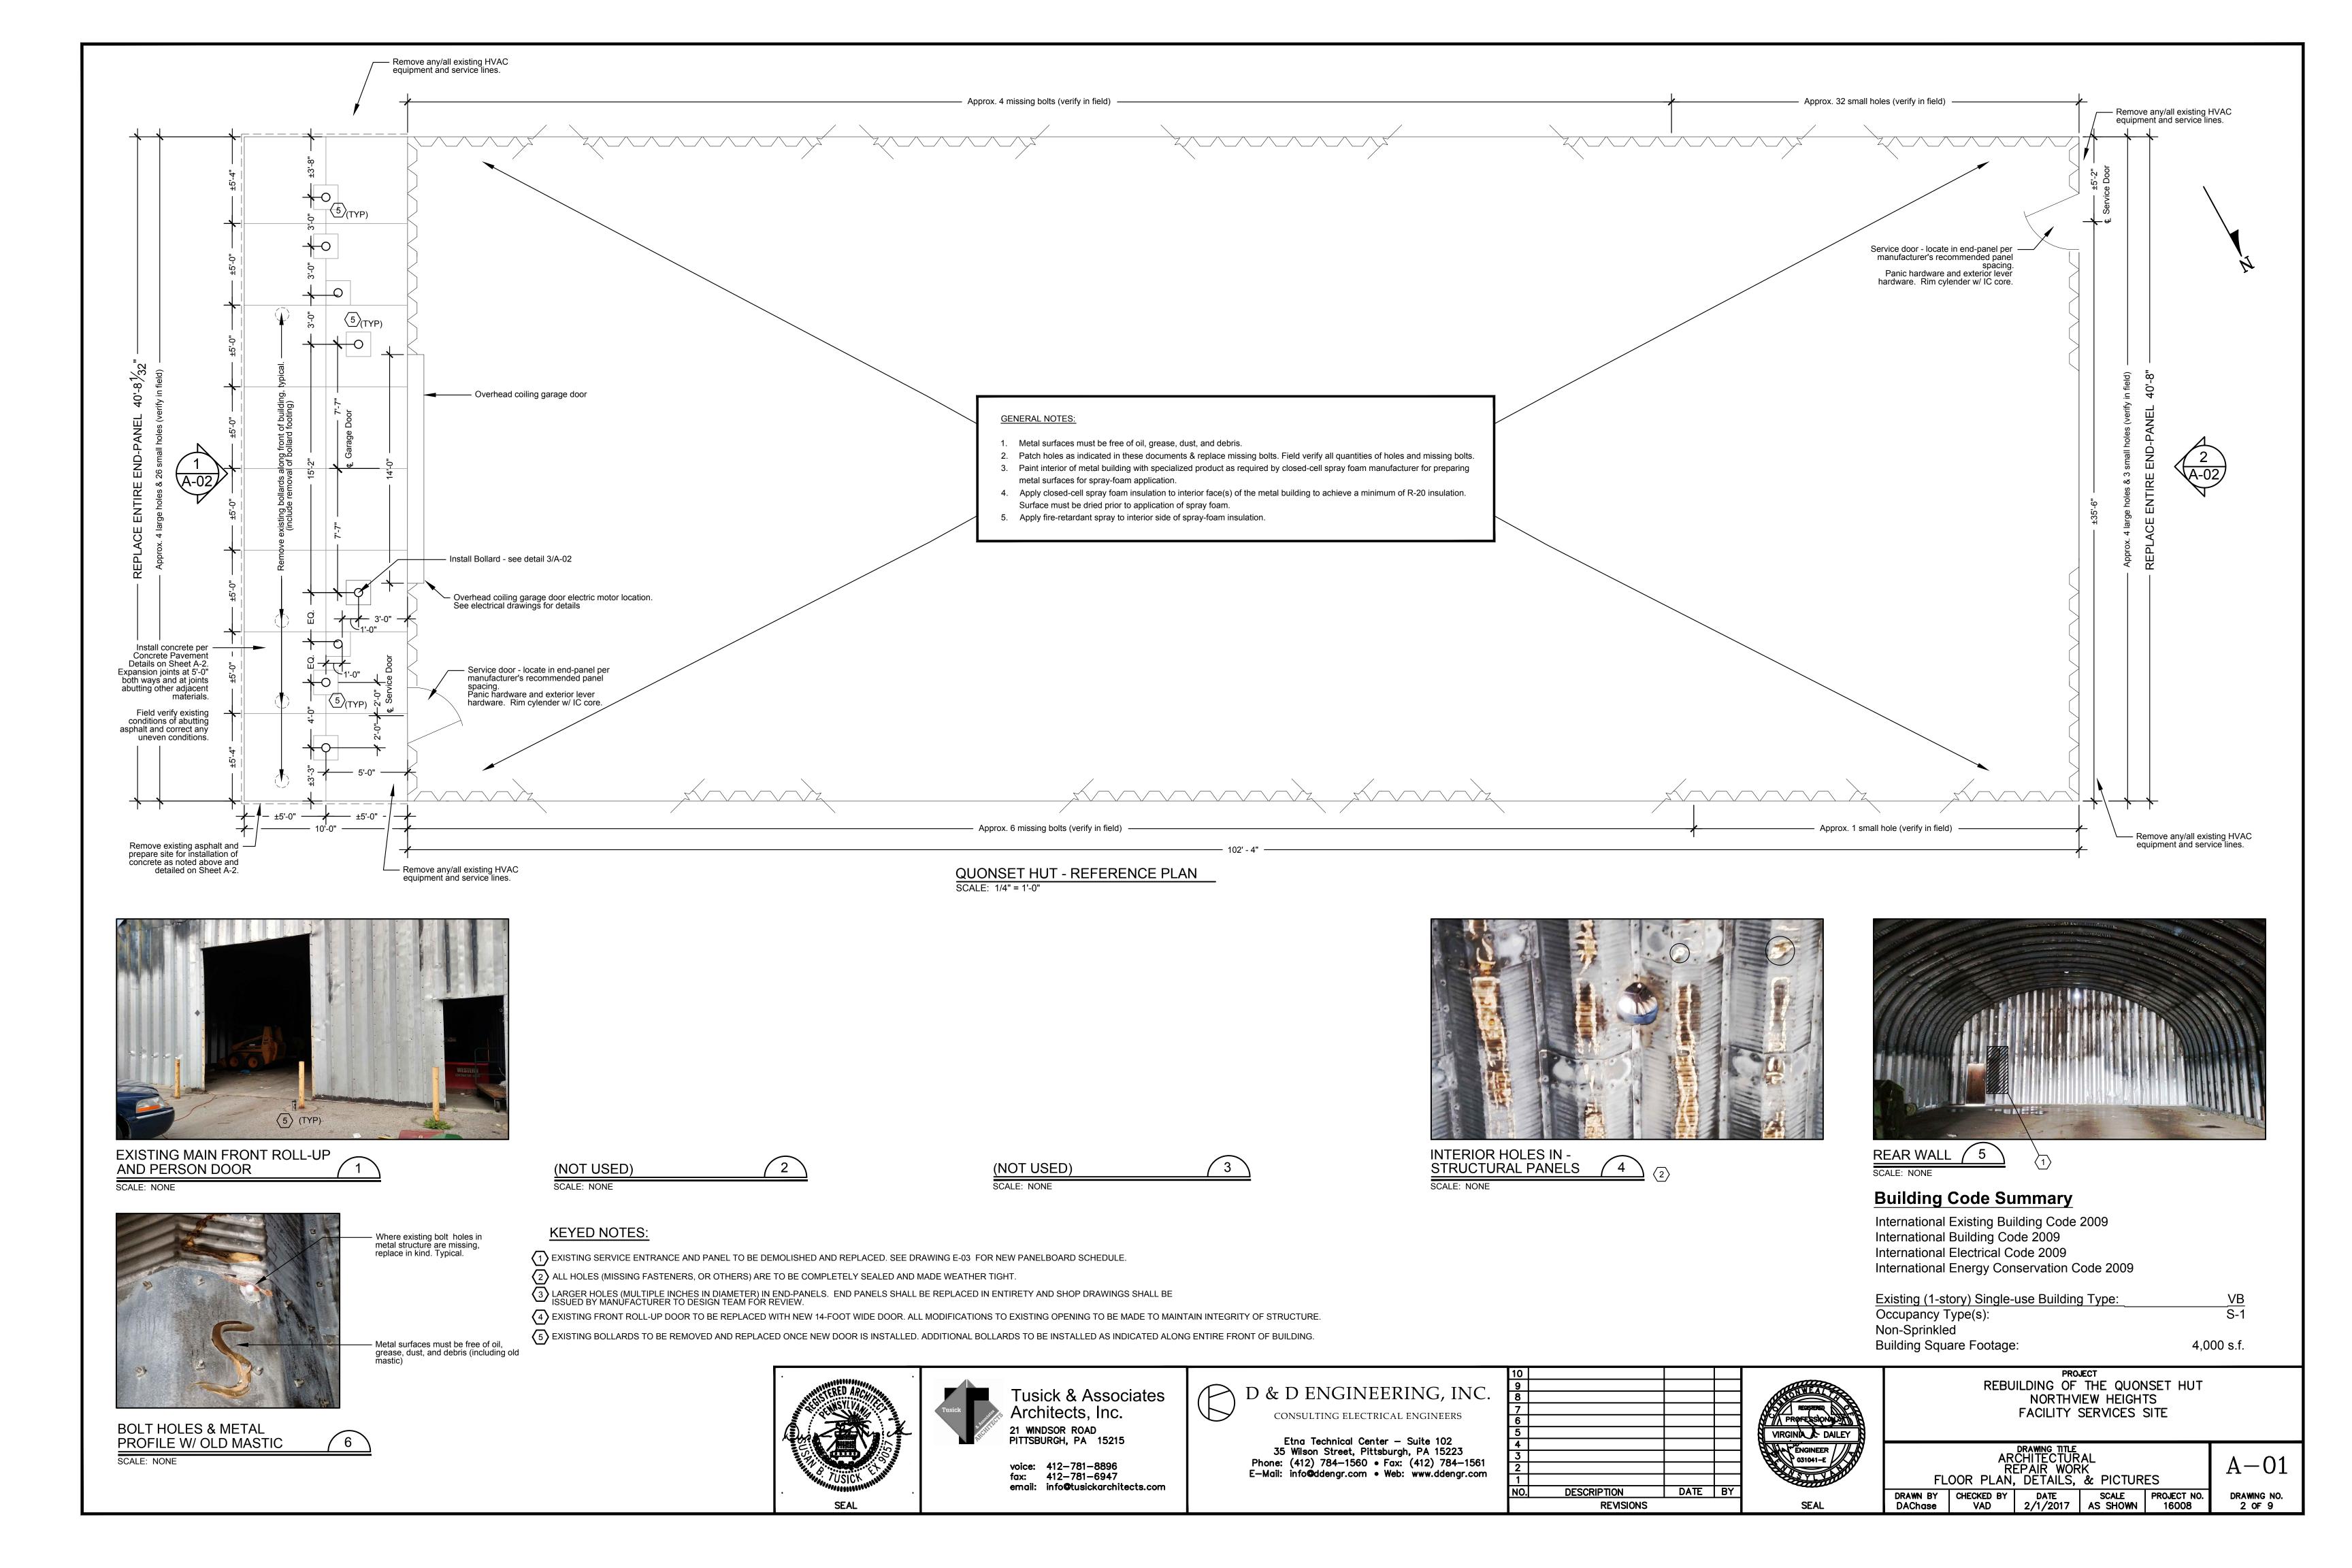


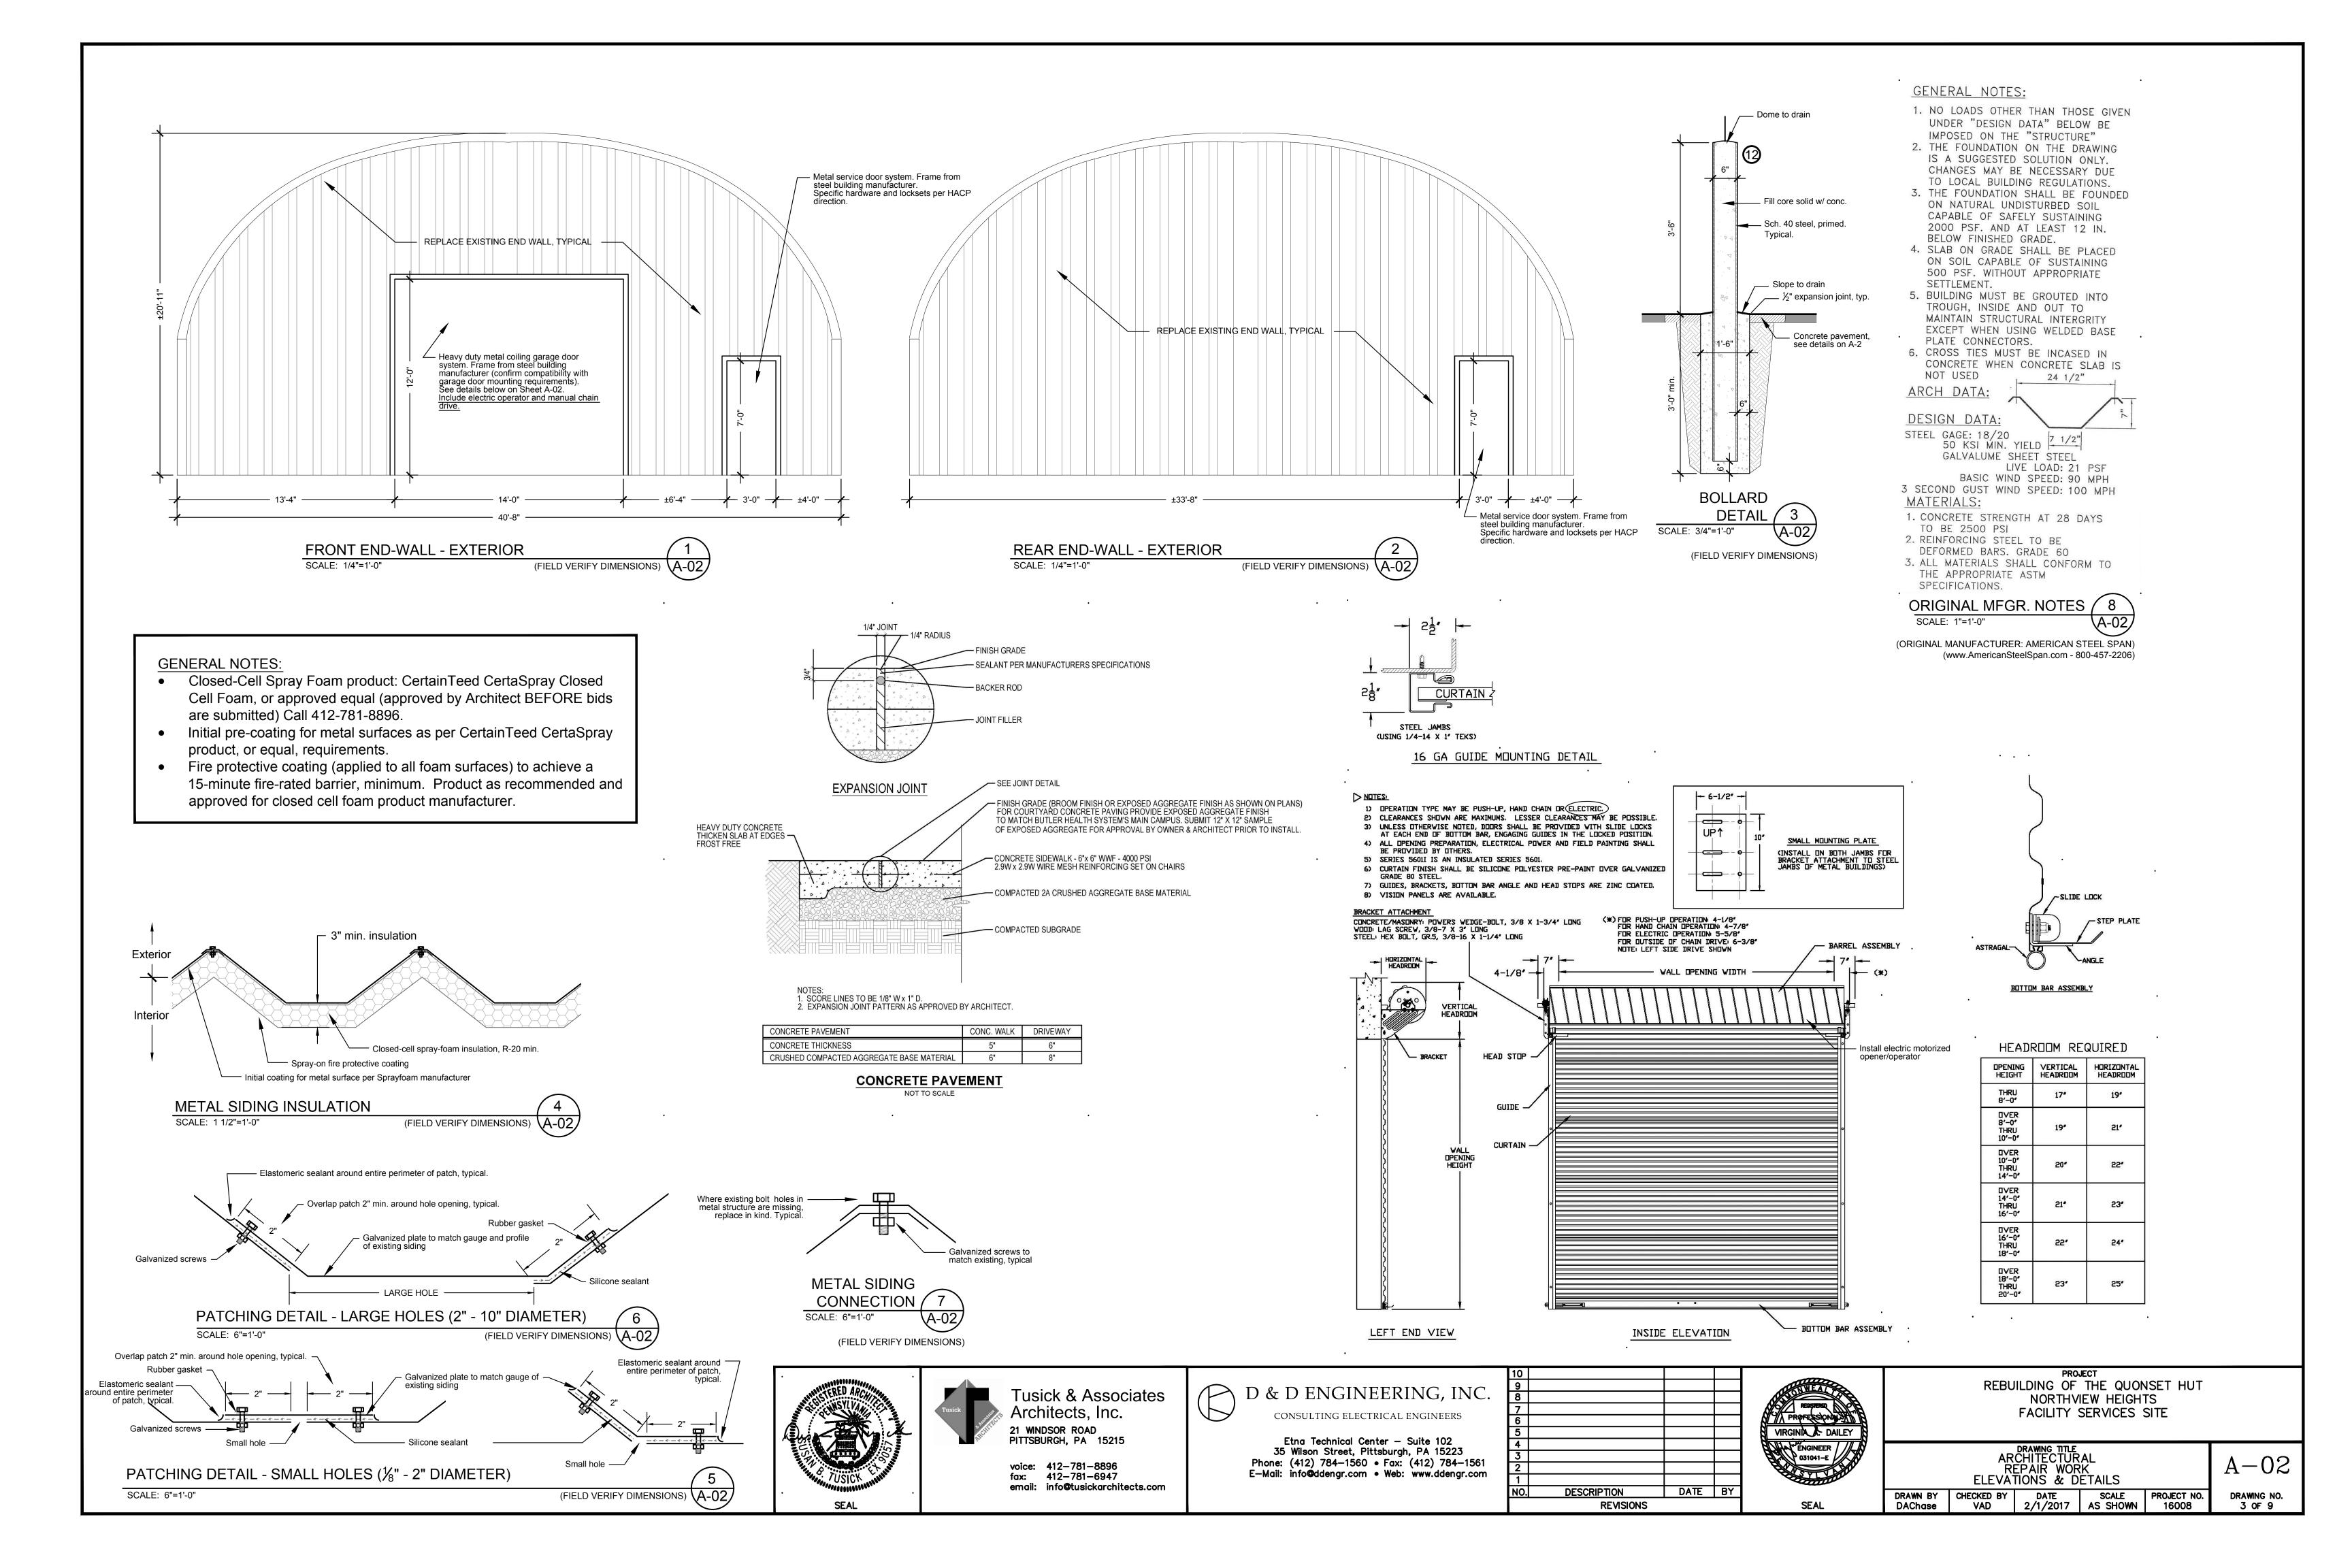
OLANDER Engineering, Inc. 227 E. Main Street Carnegie, Pa 15106 Phone: (412) 279-1810 Fax: (412) 279-1865

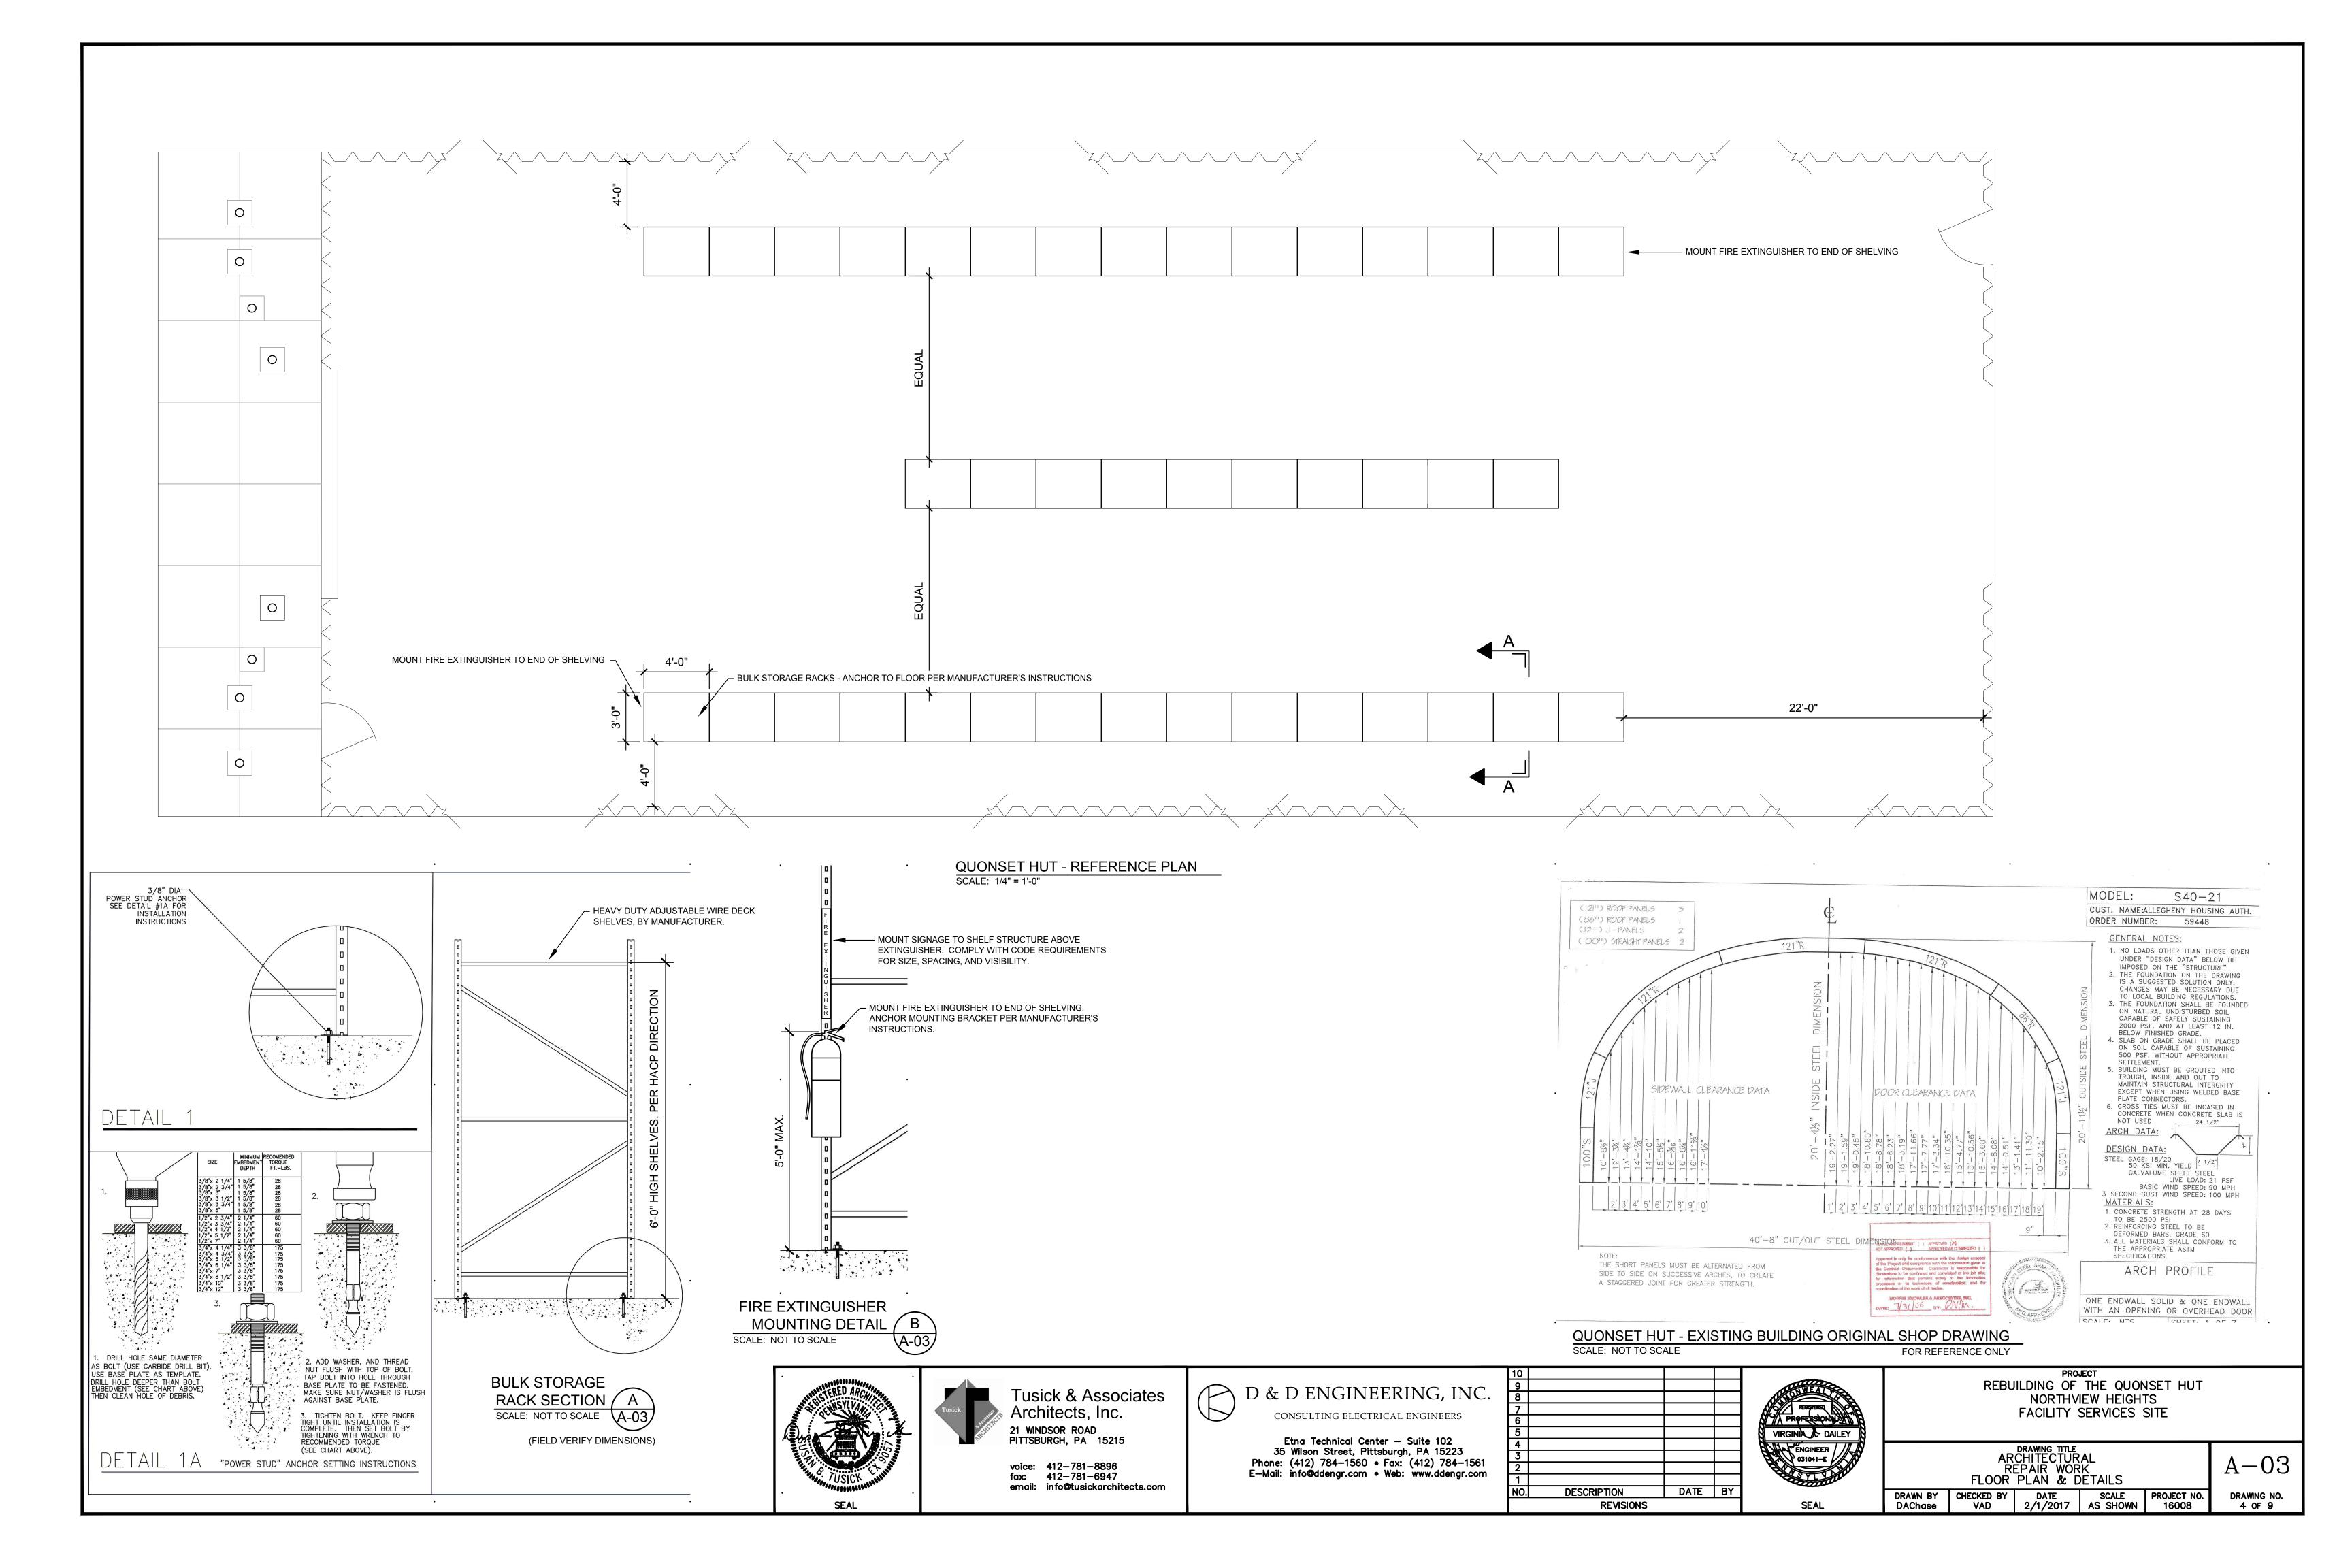
DRAWING NUMBER



SHEET NUMBER 1 OF 9







SYSTEMS/STRUCTURES.

GENERAL SYMBOLS

PIPING SYMBOLS:

( x )

X-X

- 1. THE MECHANICAL DRAWINGS ARE DIAGRAMMATIC AND ARE NOT INTENDED TO SHOW EXACT LOCATION OF EQUIPMENT, PIPING, DUCTWORK AND OTHER DEVICES UNLESS DIMENSIONS ARE GIVEN OR OTHERWISE IMPLIED. CONTRACTOR SHALL CONFORM TO ACTUAL BUILDING CONDITIONS.
- 2. TRANSITIONS, OFFSETS, DROPS, ETC. SHALL BE PROVIDED AS REQUIRED FOR DUCTWORK AND PIPING, WHETHER SHOWN OR NOT ON PLANS. THE CONTRACTOR SHALL FULLY COORDINATE THE MECHANICAL WORK WITHIN ITSELF AND WITH THE WORK OF ALL OTHER TRADES TO PROVIDE COMPLETE AND OPERABLE SYSTEMS WITHOUT INTERFERENCES.
- 3. PROVIDE ACCESS PANELS/DOORS WHERE REQUIRED FOR ADEQUATE ACCESS TO ALL CONCEALED EQUIPMENT, VALVES, DAMPERS AND CONTROLS WHETHER SHOWN OR NOT ON DRAWINGS.
- 4. INSTALL DUCTWORK AND PIPING MAINS TIGHT TO UNDERSIDE OF STRUCTURE UNLESS OTHERWISE
- INDICATED. 5. ALL WORK SHALL BE PERFORMED IN AN ORDERLY MANNER WITHOUT DAMAGE TO EXISTING
- 6. AS AN INTEGRAL PART OF THESE DOCUMENTS, THE CONTRACTOR SHALL REFER TO THE SPECIFICATIONS FOR ADDITIONAL INFORMATION.
- 7. SYSTEMS SHALL BE DESIGNED AND INSTALLED FOR EFFICIENT UTILIZATION OF ENERGY IN ACCORDANCE
- 8. PIPING SHALL NOT BE INSTALLED ABOVE ELECTRICAL PANELS.

WORK WITH MATERIALS AND FINISHES TO MATCH EXISTING.

**DETAIL NUMBER** 

THERMOSTAT

WALL SWITCH

SHEET LOCATION

WITH THE INTERNATIONAL ENERGY CONSERVATION CODE (IECC).

- 9. ALL PIPING DISCONNECTED AND INTENDED FOR RE-USE SHALL BE TEMPORARILY CAPPED UNTIL NEW CONNECTIONS ARE COMPLETED.
- 10. CONTRACTOR SHALL REFER TO FLOW DIAGRAMS, DETAILS, PLANS AND SPECIFICATIONS FOR ALL MECHANICAL SYSTEM CONNECTIONS.
- 11. SLEEVES SHALL BE INSTALLED AT ALL WALL AND FLOOR PENETRATIONS FOR PIPING AND DUCTWORK WHETHER SHOWN ON DRAWINGS OR NOT.
- 12. PATCH AND SEAL ALL OPENINGS IN FLOORS, WALLS AND ROOF RESULTING FROM DEMOLITION OR NEW
- 13. CONTRACTOR SHALL VISIT THE SITE AND VERIFY EXISTING CONDITIONS PRIOR TO THE BEGINNING OF ANY WORK. FAILURE TO VISIT THE SITE SHALL IN NO WAY RELIEVE THE CONTRACTOR FROM ANY
- 14. ALL WORK SHALL BE INSTALLED IN ACCORDANCE WITH APPLICABLE CODES AND REGULATIONS.
- 15. CONTRACTOR SHALL USE CARE WHEN PERFORMING SELECTIVE DEMOLITION. THE CONTRACTOR SHALL BE RESPONSIBLE FOR DAMAGE TO BUILDING FINISHES, EQUIPMENT, STRUCTURE, AND MEP SYSTEMS AND EQUIPMENT. SHOULD ANY DAMAGE OCCUR, THE CONTRACTOR SHALL RESTORE ITEMS/AREA TO ITS
- 16. CONTRACTOR SHALL NOTIFY AND COORDINATE WITH THE OWNER ANY UTILITY OUTAGES.

**EQUIPMENT TAG FOR SCHEDULES** 

SPECIFIC DRAWING NUMBERED NOTE

NEW TO EXISTING CONNECTION

CAPPED LINE

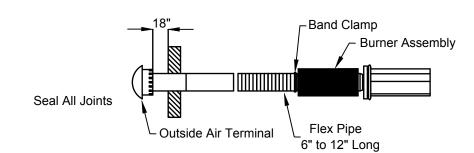
PIPE BREAK

ELBOW TURNING DOWN

45° OR 90° BOTTOM CONNECTION


45° OR 90° TOP CONNECTION

ELBOW TURNING UP



A field supplied 4" O.D. single wall combustion air pipe must be attached to the heater(s) as depicted on the plans. The duct may be up to 45 ft. maximum length or 2 ft. minimum length with no more than 2 elbows. When heater extension packages are used they directly effect maximum vent length. Refer to installation, operation and service manual for requirements. The outside air terminal shall be provided by the infrared heating equipment manufacturer.

**∖OUTSIDE COMBUSTION AIR DETAIL** 

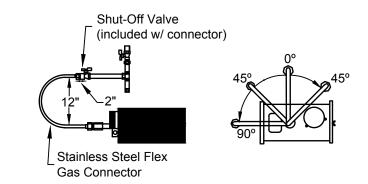


Follow these instructions to ensure a professional gas supply system installation: a) All gas piping must be supported with suitable pipe hanging materials. b) Use wrought iron or wrought steel pipe and malleable iron fittings. All pipe and fittings must be new and free from defects. Carefully ream the pipe and tubing ends to remove obstructions and burner. c) LP-gas-resistant joint compound must be used on all threads.

d) Check the pipe and tubing ends for leaks before placing heating equipment into service. When checking for gas leaks, use a soap and water solution; never use an e) Install the flex gas connector as shown. The flex gas connector accommodates expansion of the heating system and allows for easy installation and service of the

f) Shut-Off Valve must be parallel to burner inlet. The 2" (5cm) displacement shown is for the cold condition. This displacement may reduce when the system is fired.

**GAS CONNECTION DETAIL** 

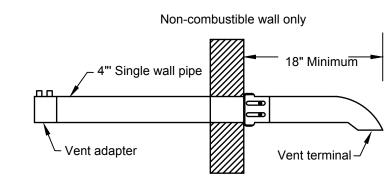

a) Refer to installation, operation and service manual for proper vent design. b) In combustible or noncombustble walls use insulated vent terminal. Follow vent manufacturer's instructions for proper installation. c) 4" O.D. vent pipe, maximum 45 ft.(13.7m) in length may be used as shown above with an approved vent cap. When heater extension packages are used they directly effect maximum vent length. Refer to installation, operation and service manual for requirements. d) Vent terminal should be installed at a height sufficient to prevent blockage by snow. Building materials should be protected from degradation by vent gases.

e) Vent lengths 20' and longer require insulation and other vent sealing methods.

f) Vent terminal shall be provided by infrared heating equipment manufacturer.

HORIZONTAL VENTING DETAIL H-01 SCALE: NTS

## 1-1/2" X 1-1/2" X 1/8" ALUMINUM OR STEEL X FRAME WALL CLIP ANGLE, 4" LONG. CAULK #10-16 X 1" 1" LG. HWH SELF DRILL SCREW (2 PER CLIP) BIRDSCREEN — <u>INSIDE</u> <u>OUTSIDE</u> LOUVER -**FASTENERS** - DAMPER MOTOR CAULK\_ EXTENDED SILL —— LINKAGE FRAME WALL

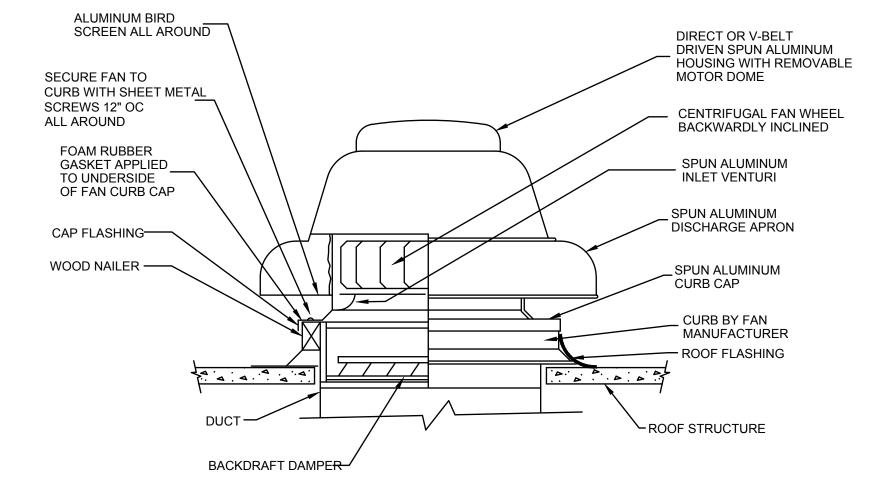
## **LOUVER & DAMPER DETAIL**

1. THE LOUVER/DAMPER INSTALLATION SHALL BE IN ACCORDANCE WITH MANUFACTURERS INSTRUCTIONS FOR METAL BUILDINGS.

INFRARED HEATER BURNER SCHEDULE											
MARK	MODEL	INPUT (MBH)	MOUNTING HT.	FUEL TYPE	VC	LTAGI	Е				
					V	Ø	HZ				
IR-1	BH115N-30H	115.0	16' AFF	NATURAL GAS	115	1	60				
IR-2	BH115N-30H	115.0	16' AFF	NATURAL GAS	115	1	60				

	LOUVER SCHEDULE										
TAG SERVICE SIZE SF FACE VEL. MFGR./MODEL NO. REMARKS (W X H) FREE AREA (FPM)											
L-1	EF-1/2 EXHAUST	34 X 20	2.07	600	GREENHECK ESD-403	12					
L-2	EF-1/2 EXHAUST	34 X 20	2.07	600	GREENHECK ESD-403	12					
L-3	EF-1/2 EXHAUST	34 X 20	2.07	600	GREENHECK ESD-403	12					
L-4	EF-1/2 EXHAUST	34 X 20	2.07	600	GREENHECK ESD-403	12					
1) BIR	DSCREEN 2 MOTORIZED D	AMPER									

EXHAUST FAN SCHEDULE (EF)													
MARK	ARK SERVICE C.F.M TYPE EXT. DRIVE FAN H.P. VOLTAGE WT. MANUFACTURER REMARKS S.P. R.P.M. V Ø HZ LBS. AND MODEL NO.												
EF-1	QUONSET HUT	2,500	ROOF CENT. EXH.	0.375	DIRECT	1140	3/4	208	3	60	101	GREENHECK G-163-B	1 2
EF-2	QUONSET HUT	2,500	ROOF CENT. EXH.	0.375	DIRECT	1140	3/4	208	3	60	101	GREENHECK G-163-B	12



**ABBREVIATIONS:** 

EFF

EX SP

FPM

MCA

MOCP

RTU

CUBIC FEET PER MINUTE

ENTERING AIR TEMPERATURE

EXTERNAL STATIC PRESSURE

INCHES OF WATER COLUMN

LEAVING AIR TEMPERATURE

MAXIMUM CIRCUIT AMPACITY

REVOLUTIONS PER MINUTE

MAX. OVERCURRENT PROTECTION

DRY BULB

EXHAUST FAN

FEET PER MINUTE

INFRARED HEATER

HORSEPOWER

KILOWATT LOUVER

1000 BTU/H

OUTSIDE AIR REFRIGERANT

ROOFTOP UNIT

SMOKE DETECTOR

SENSIBLE

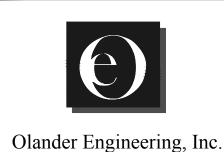
TYPICAL

WET BULB

**EFFICIENCY** 

ROOF EXHAUST FAN DETAIL

1. THE ROOF EXHAUST FAN INSTALLATION SHALL BE IN ACCORDANCE WITH MANUFACTURERS INSTRUCTIONS FOR METAL BUILDINGS.



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> Etna Technical Center — Suite 102 35 Wilson Street, Pittsburgh, PA 15223 Phone: (412) 784-1560 • Fax: (412) 784-1561 E-Mail: info@ddengr.com • Web: www.ddengr.com

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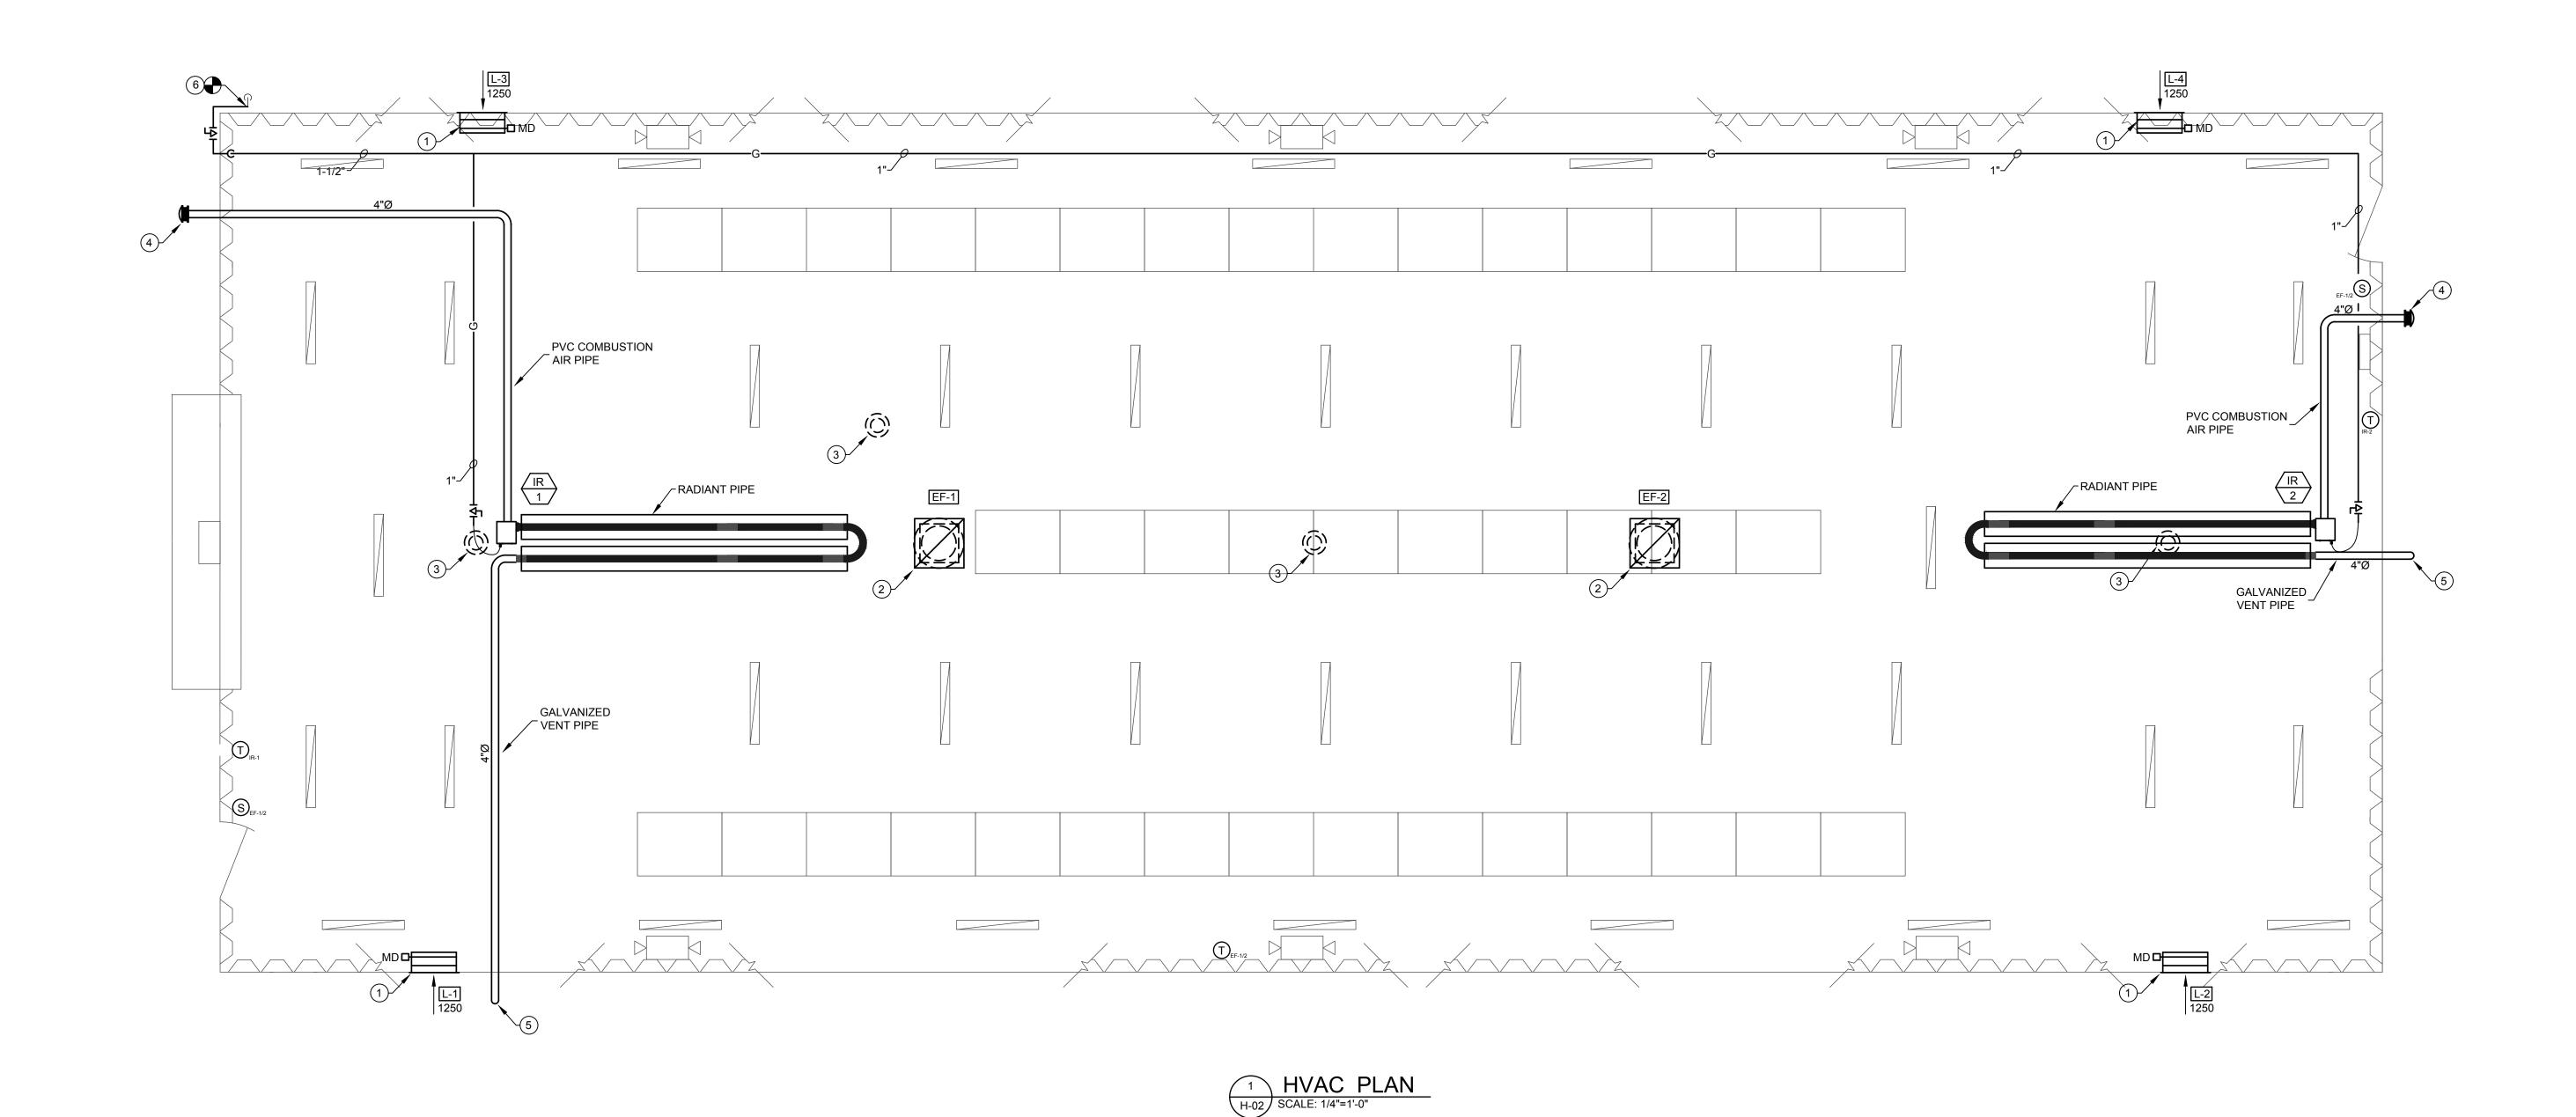
PROFESSIONAL  JEFFREY A. OLANDER  ENGINEER  NO. 045232-F	
SFAI	

PROJECT REBUILDING OF THE QUONSET HUT NORTHVIEW HIGHRISE FACILITY SERVICES SITE

DRAWING TITLE							
HVAC NOTES, SYMBOLS, LEGENDS,							
DETAILS AND SCHEDULES							
DRAWN BY	CHECKED BY	DATE	SCALE	PROJECT NO.			
JAO	JAO	2/01/2017	AS SHOWN	16008			

DRAWING NO.

5 OF 9



## NEW WORK CODED NOTES:

- 1) INSTALL NEW LOUVER W/ MOTORIZED DAMPER IN WALL ACCORDING TO MANUFACTURERS INSTRUCTIONS FOR METAL BUILDINGS. PROVIDE WALL OPENING TO ACCOMMODATE NEW EQUIPMENT, MIN. 18" ABOVE GRADE.
- 2 INSTALL NEW EXHAUST FAN ON ROOF ON CURB, ACCORDING TO MANUFACTURERS INSTRUCTIONS FOR METAL BUILDINGS, WITH BACKDRAFT DAMPER. TRANSITION FROM FAN CONNECTION DOWN THRU ROOF AND TRANSITION TO 28/28 HIGH TO CEILING WITH SCREEN ON OPEN END. FIELD VERIFY FAN LOCATION AND ROOF OPENING PRIOR TO INSTALLATION.
- 3 REMOVE VENT ON ROOF IN ITS ENTIRETY AND SEAL ROOF AIR/WATER TIGHT WITH LIKE MATERIALS. REFER TO ARCHITECTURAL DRAWINGS FOR SEALING INFORMATION.
- 4 INFRARED HEATER COMBUSTION AIR INTAKE. SEE DETAIL NO. 1, DWG. H1 AND REFER TO MANUFACTURERS INSTRUCTIONS.
- (5) INFRARED HEATER HORIZONTAL VENT SYSTEM. SEE DETAIL NO. 3, DWG. H1 AND REFER TO MANUFACTURERS INSTRUCTIONS.
- 6 CONNECT NEW 1-1/2" NATURAL GAS PIPING TO EXISTING AND ROUTE THRU WALL THRU EXISTING OPENING. SEAL OPENING AIRTIGHT.





## D & D ENGINEERING, INC. CONSULTING ELECTRICAL ENGINEERS

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			NWEA
			REGISTERED
			PROFESSIONAL
			JEFFREY A. OLANDE
			ENGINEER //
			NO. 045232-E
			SYLVE
ESCRIPTION	DATE	BY	
REVISIONS			SEAL

PROJECT
REBUILDING OF THE QUONSET HUT NORTHVIEW HIGHRISE FACILITY SERVICES SITE

DRAWING TITLE H - 02HVAC PLAN AND NOTES DRAWN BY CHECKED BY DATE SCALE PROJECT NO. JAO 2/01/2017 AS SHOWN 16008 DRAWING NO. 6 OF 9

**GENERAL NOTES:** 

F. INSTITUTE OF ELECTRICAL AND ELECTRONIC ENGINEERS G. NATIONAL ELECTRICAL MANUFACTURER'S ASSOCIATION H. NATIONAL BOARD OF FIRE UNDERWRITERS INSULATED POWER CABLE ENGINEERS ASSOCIATED SPECIFICATIONS

AMERICAN SOCIETY FOR TESTING MATERIALS AND SPECIFICATIONS FEDERAL DEPARTMENT OF LABOR OCCUPATIONAL SAFETY AND HEALTH STANDARDS AS CONTAINED IN THE FEDERAL REGISTER VOLUME 36, NUMBER 105, DATED MAY 29, 1971 OR

IF THE ELECTRICAL CONTRACTOR PERFORMS ANY WORK CONTRARY TO ANY OF THE ABOVE CODES AND REGULATIONS, THE CONTRACTOR SHALL BE HELD FULLY RESPONSIBLE FOR SUCH VIOLATIONS, AND SHALL ASSUME ANY AND ALL COSTS ASSOCIATED IN CORRECTING THE VIOLATIONS.

ELECTRICAL CONTRACTOR SHALL VISIT THE SITE TO LEARN OF ALL EXISTING CONDITIONS, WHICH IN ANY WAY WILL AFFECT THE EXECUTION OF THIS WORK AND THE REQUIREMENTS OF THIS CONTRACT AS SHOWN OR REASONABLY INFERRED ON THE DRAWINGS AND IN THE PROJECT SPECIFICATIONS.

ELECTRICAL CONTRACTOR SHALL DOCUMENT ANY REQUEST OR DEVIATION FROM THE CONTRACT DOCUMENTS ON ANY ITEM THAT MAY HAVE BEEN DISCUSSED IN THE FIELD, OR DIRECTED BY OTHERS, REGARDING MATERIALS OR INSTALLATION METHODS.

ELECTRICAL CONTRACTOR SHALL COORDINATE ALL ELECTRICAL WORK (AS DESCRIBED ON THE DRAWINGS AND IN THE PROJECT SPECIFICATIONS) WITH ALL OTHER TRADES AND SUBCONTRACTORS ON THE PROJECT. THIS MAY INCLUDE, BUT NOT BE LIMITED TO, PROVIDING COMPLETE DRAWINGS AND SPECIFICATIONS TO GENERAL TRADES TO ENSURE COORDINATION WITH ALL TRADES AND CONSTRUCTION

ELECTRICAL CONTRACTOR SHALL PROVIDE TEMPORARY WIRING AS NECESSARY, TO ENSURE THAT NO DISRUPTION IN SERVICE OCCURS. TEMPORARY WIRING SHALL BE OF SIMILAR TYPE AND INSULATION WITH

6. PROVIDE TYPE OF CONDUIT FOR THE FOLLOWING

A. BUILDING EXTERIOR - RGS B. BUILDING INTERIOR - EMT

ANY CUTTING, ROUGH AND FINISHED PATCHING, AS WELL AS ALL PAINTING FOR ALL WORK IS TO BE PERFORMED BY THE ELECTRICAL CONTRACTOR.

LINKSEAL ALL CONDUIT PENETRATIONS OF EXTERIOR WALLS ABOVE AND BELOW GRADE.

ALL MATERIALS SHALL BEAR THE LABEL OF UNDERWRITER'S LABORATORIES AND MEET THE CURRENT U.L. STANDARD FOR THAT TYPE OF MATERIAL.

ELECTRICAL CONTRACTOR SHALL OBTAIN AND PAY FOR ALL LICENSES, PERMITS, AND INSPECTIONS, INCLUDING BUT NOT LIMITED TO, THE CERTIFICATE OF FINAL INSPECTION AND APPROVAL FROM THE OCAL INSPECTION AUTHORITIES. FEES SHALL BE INCLUSIVE FOR ALL WORK TO BE PERFORMED WHETHER ONE OR MORE THAN ONE PERMIT/LICENSE IS REQUIRED.

ALL CONDUCTORS SHALL BE COPPER WITH TYPE THHN/THWN INSULATION. CONDUCTORS (#10 AND SMALLER) SHALL BE SOLID. CONDUCTORS (#8 AND LARGER) SHALL BE STRANDED. THE MINIMUM CONDUCTOR SIZE FOR POWER CONDUCTORS SHALL BE #12.

12. ALL GROUND CONDUCTORS SHALL BE FULLY INSULATED WITH GREEN INSULATION.

13. THE WIRING METHODS FOR THIS PROJECT SHALL BE WIRE IN CONDUIT IN EXPOSED AREAS. THE CONDUIT SHALL BE ELECTRIC METALLIC TUBING (EMT) AND THE MINIMUM SIZE SHALL BE 3/4". CONDUIT PLACED BELOW GRADE AND/OR CONCRETE ENCASED SHALL BE SCHEDULE 40 PVC AND A MINIMUM SIZE SHALL BE 1". ALL EXPOSED WIRING CONDITIONS SHALL BE INSTALLED IN CONDUIT IN UNFINISHED SPACES.

ELECTRICAL CONTRACTOR SHALL PROVIDE ADEQUATELY SIZED WIREWAYS, JUNCTION BOXES, AND OUTLET BOXES FOR RESPECTIVE APPLICATIONS. THESE ITEMS SHALL BE SIZED IN ACCORDANCE WITH THE LATEST EDITION OF THE 2008 NATIONAL ELECTRICAL CODE AND BE READILY ACCESSIBLE. THESE ITEMS SHALL BE OF GALVANIZED STEEL CONSTRUCTION UNLESS SPECIFIED OTHERWISE.

CONDUCTORS, EQUIPMENT AND/OR DEVICES OF DIFFERENT VOLTAGES SHALL NOT BE INSTALLED IN THE SAME OUTLET OR JUNCTION BOX. EACH CIRCUIT SHALL HAVE ITS OWN NEUTRAL CONDUCTOR. DO NOT SHARE NEUTRALS. COVER PLATES SHALL BE PROVIDED ON ALL BLANK OUTLET BOXES FOR FUTURE USE PROVIDE ADDITIONAL INSULATION BEHIND EACH JUNCTION OR OUTLET BOX LOCATED ON EXTERIOR

LOCATION OF ITEMS AND DIMENSIONS SHOWN ON DRAWINGS ARE APPROXIMATE. MOUNTING HEIGHTS OF EQUIPMENT AND ROUTING OF RACEWAYS SHALL BE COORDINATED WITH THE EQUIPMENT REQUIREMENTS,

17. EXACT LOCATIONS OF ELECTRICAL DEVICES AND EQUIPMENT SHALL BE VERIFIED.

FIELD CONDITIONS AND APPROVED BY THE OWNER/ENGINEER.

18. ALL DIMENSIONS AND EXISTING CONDITIONS SHALL BE CHECKED AND VERIFIED BY THE CONTRACTOR AT

THESE DRAWINGS DO NOT INCLUDE NECESSARY COMPONENTS OR INSTRUCTIONS FOR CONSTRUCTION SAFETY. THE ELECTRICAL ENGINEER ASSUMES NO RESPONSIBILITY FOR ANY WORKER'S OR TRANSIENT'S SAFETY, OR FOR THE ADEQUACY OF EQUIPMENT, BUILDING COMPONENTS, SCAFFOLDS, FORMS, OR OTHER WORK ANY NECESSITY TO WORK ON "LIVE" ELECTRICAL COMPONENTS. FURTHER, NO SUPERINTÉNDENCE IS INCLUDED OR INTENDED.

THE ELECTRICAL CONTRACTOR SHALL BE REQUIRED TO PROTECT ALL OPEN EXCAVATIONS DURING ANY DEMOLITION AND/OR CONSTRUCTION.

DEVIATION FROM MANUFACTURER'S NAMES, CATALOG/MODEL/PARTS NUMBERS SHOWN ON THE DRAWINGS AND IN THE PROJECT SPECIFICATIONS SHALL NOT BE PERMITTED WITHOUT PRIOR WRITTEN APPROVAL FROM THE OWNER AND/OR ENGINEER.

ELECTRICAL CONTRACTOR IS RESPONSIBLE FOR ANY CUTTING AND/OR PATCHING REQUIRED BY ELECTRICAL WORK RESULTING FROM THE FAILURE TO INSTALL EMBEDDED OR BUILT-IN ITEMS AS AND

ELECTRICAL CONTRACTOR SHALL VERIFY THAT THE WORK IS FEASIBLE AS SHOWN ON THE DRAWINGS AND IN THE PROJECT SPECIFICATIONS. ELECTRICAL CONTRACTOR SHALL VERIFY LOCATION OF ELECTRICAL ITEMS IN RELATION TO ARCHITECTURAL AND STRUCTURAL ITEMS AS REQUIRED. ELECTRICAL CONTRACTOR SHALL NOTIFY THE ENGINEER OF ANY DISCREPANCIES BEFORE PROCEEDING WITH WORK.

ELECTRICAL CONTRACTOR SHALL PROVIDE ANY ADDITIONAL JUNCTION BOXES AND/OR HANDHOLES, NOT SHOWN ON THE PLANS, BUT REQUIRED TO COMPLETE CONSTRUCTION. THESE ITEMS SHALL BE IN STRICT CONFORMANCE TO THE REQUIREMENTS OF THE LATEST EDITION OF THE NATIONAL ELECTRICAL CODE. LOCATIONS OF ADDITIONAL HANDHOLES SHALL REQUIRE APPROVAL BY THE ENGINEER BEFORE INSTALLATION. ELECTRICAL CONTRACTOR MAY BE REQUIRED TO REMOVE OR RELOCATE ANY INSTALLATION OF ADDITIONAL HANDHOLES THAT ARE NOT APPROVED, AND AT NO ADDITIONAL COST TO

POWER AND CONTROL CABLES ARE TO BE SEPARATED AT ALL TIMES. SOME JUNCTIN BOXES MAY REQUIRE A MECHANICAL BARRIER TO MAINTAIN SEPARATION OF POWER FROM CONTROL.

#### **BUILDING CODE COMPLIANCE BUILDING DATA BUILDING NAME:** QUONSET HUT ELECTRICAL WORK AT PROJECT NAME: **QUONSET HUT** BUILDING ADDRESS: 525 MOUNT PLEASANT ROAD PITTSURGH, PA. 15214-2427 BUILDING CODE: NATIONAL ELECTRICAL CODE 2011 HVAC INT'L MECHANICAL, FUEL GAS, ENERGY CONSERVATION CODE 2009 INT'L BUILDING CODE 2009 & 2012 INT'L EXISTING (1-STORY) SINGLE-USE BUILDING (OR MOST CURRENT CODE ENFORCED BY CITY OF PITTSBURGH) **BUILDING OCCUPANCY** USE AND OCCUPANCY CLASSIFICATION: S-1 LOCAL CODE REVIEW JURISDICTION: CITY OF PITTSBURGH BUREAU OF BUILDING INSPECTION

## **ELECTRICAL LEGEND**

JUNCTION BOX ONDUIT ELLED UP

SINGLE-PHASE HOMERUN TO PANEL, NOTED

THREE-PHASE HOMERUN TO PANEL, NOTED

--•- GROUNDING WIRE

☐ - • - ■ GROUNDING CONNECTION

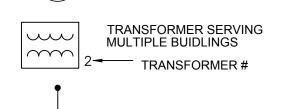
DUPLEX, 4-PLEX RECEPTACLE, (G) GROUND FAULT CIRCUIT INTERRUPTOR, (WP) WEATHERPROOF ₩P (EXP) EXPLOSION PROOF, (IG) ISOLATED GROUND

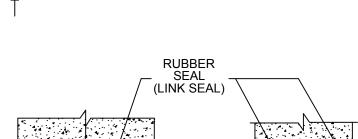
EXISTING FACILITIES/EQUIPMENT

NEW FACILITIES/EQUIPMENT

KEYNOTES


"#" INDICATES PHOTO NUMBER ON DRAWING. ARROW INDICATES DIRECTION OF VIEW.





SOUTHERN STATES CUTOUTS

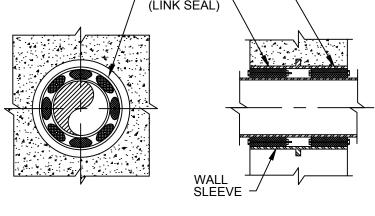WITH FUSE/FUSELINKS





SCALE: NONE

## **ABBREVIATIONS**

**AMPERES** AIR CONDITIONING ABOVE FINISHED FLOOR CONDUIT CIRCUIT BREAKER CKT CIRCUIT **EMERGENCY** 

ELECTRICAL CONTRACTOR EXISTING TO BE REMOVED AND **RELOCATED** FIRE HOSE FUSE(S)

G OR GND GROUND GROUND FAULT INTERRUPTING HORSEPOWER

MCB MAIN CIRCUIT BREAKER MLO MAIN LUG ONLY NORMALLY CLOSED NEC NATIONAL ELECTRIC CODE NORMAL/EMERGENCY

NON FUSED NORMALLY OPEN PUMP OR POLE PANEL

POWER PANEL REMOVED AND RELOCATED EQUIPMENT

#2/0 COPPER GROUND

WIRE CONNECTED TO

(3) 3/4"x10" GROUND

10' SPACING. -

SCALE: NONE

RODS A MINIMUM OF

**GROUNDING COUNTERPOISE DETAIL** 

IN NEW LOCATION SURFACE MOUNT SWITCH VOLTS WATTS OR WIRE

WITH WIRE GUARD WEATHERPROOF

RAINTIGHT SERVICE HEAD BY CONTRACTOR. MAINTAIN 3'-0" CLEARANCE FROM WINDOWS, DOORS, AND SIMILAR ACCESSIBLE AREAS.

LEAVE A MINIMUM 36" OF SERVICE ENTRANCE CONDUCTORS FOR

SERVICE DROP CONNECTION BYCONTRACTOR. RIGID GALVANIZED STEEL CONDUIT RISER MAST BY CONTRACTOR. COUPLINGS SHALL NOT BE USED IN TOP 10' OF MAST OR ABOVE ROOF. PROVIDE 2" MAST FOR UP TO 2'-6" EXTENSION, 2 1/2" MAST FOR UP TO 4'-0" EXTENSION.

SECURELY ANCHOR SERVICE BRACKET TO STRUCTURAL FRAME MEMBERS OF WALL, BY CONTRACTOR.

SERVICE BRACKET SUPPLIED AND INSTALLED BY CONTRACTOR. ABOVE 100A, 5/8" THRU BOLT MAY BE REQUIRED FOR ADEQUATE SUPPORT.

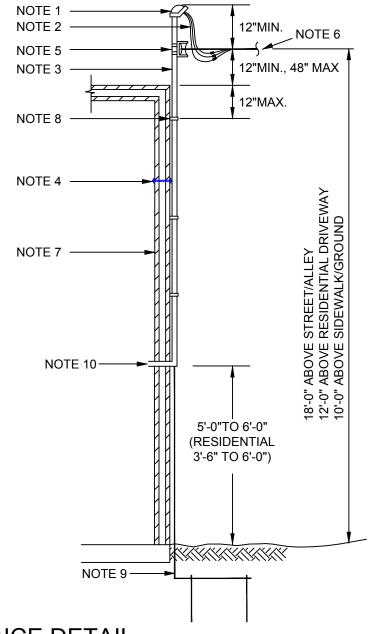
ROOF EAVE/OVERHANG NOT TO EXCEED 8". LENGTH OF SERVICE DROP CROSSING OVER ROOF PERPENDICULAR TO 8" EAVE NOT TO EXCEED 4'. FOR SERVICE DROP CROSSING OVER ROOF >4', MAST SEALENE SUFFICIENT HEIGHT TO PROVIDE CLEARANCES SPECIFIED IN NEC SECTION 230.24.

NOTE 7 WALL MUST BE DESIGNED TO WITHSTAND STRAINS IMPOSED BY SERVICE DROP, OR MODIFIED WITH SUPPORTS.


2-HOLE CONDUIT STRAPS AT NOT MORE THAN 32" INTERVALS ANCHORED BY 5/16" MINIMUM DIAMETER LAG SCREW OF SUFFICIENT LENGTH TO HOLD MAST SECURELY. TOP STRAP TO LOCATED WITHIN 12" OF ROOF.

CONTINUOUS GROUNDING CONDUCTOR, #6 INSULATED COPPER MINIMUM, CONNECTED TO (2) 5/8" x 8' COPPER GROUNDING RODS SPACED 6', BY CONTRACTOR

NOTE 10 TO SERVICE EQUIPMENT. INSTALL GROUNDING SYSTEM IN ACCORDANCE WITH N.E.C. REQUIREMENTS BY CONTRACTOR.



## SERVICE ENTRANCE DETAIL

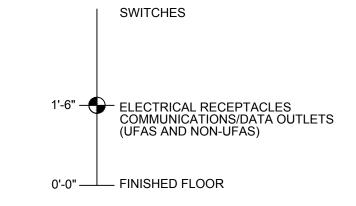



## **DETAIL - MOUNTING HEIGHT SCHEDULE**

A \_\_\_\_\_SERVICE TRANSFORMER TRANSFORMER GROUND EQUIPMENT BONDING JUMPER SIZED PER NEC 250.102(C) PANELBOARD 120/208VAC ARTICLE 680.26 (A), (B) AND (C) INCLUSIVE CIRCUIT NEUTRAL LOAD - MAIN BONDING JUMPER 00000 EQUIPMENT GROUNDING CONDUCTOR INSTALLED PER NEC 250.130 AND - GROUND SIZED PER NEC 250.122

## BUILDING AND EQUIPMENT GROUNDING SYSTEM DETAIL

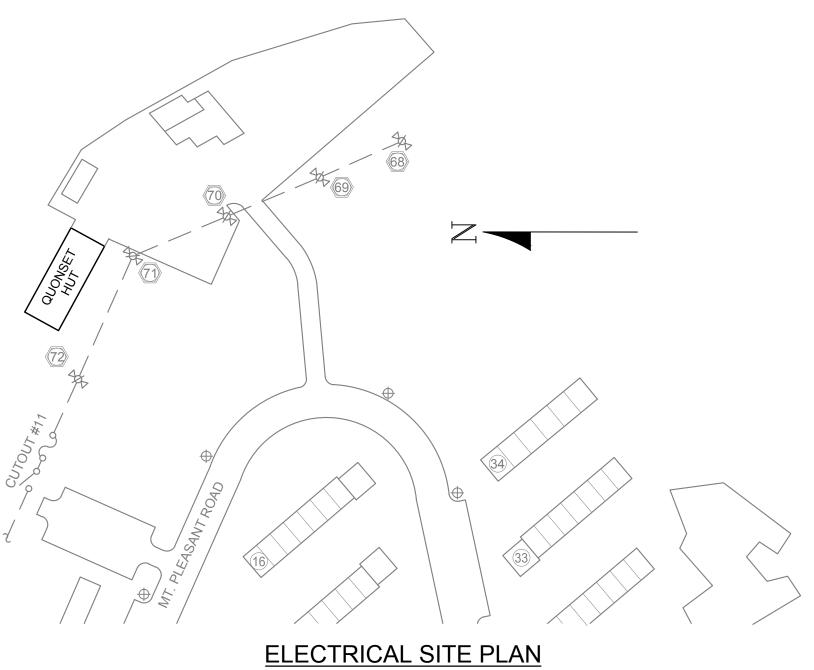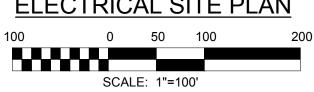	LIGHTING FIXTURE SCHEDULE										
FIXTURE No.	SYMBOL	MANUFACTURER	SERIES NAME	CATALOG No.	BALLAST	LAMP	LLF	WATTS	MOUNTING		
А	A	LITHONIA LIGHTING	MSL SERIES	MSL-8000LM-L/LV-120V-35K-80CRI-PLR22G-WH	_	LED	_	75	AIR CRAFT CABLE - SURFACE		
В	В	LITHONIA LIGHTING	WALLPACK	TWH-LED-20C-1000-50K-T3M-MVOLT-PE-TP	2 ENGINE	LED	_	72	EXTERIOR WALL		
EM	<b>D</b> EM ✓	LITHONIA LIGHTING	EMERGENCY LIGHT	ELM2 LED	_	LED	_	1.44	SURFACE		
EX	EX	LITHONIA LIGHTING	EXIT SIGN	EXR LED EL M6	_	LED	_	.8	CEILING		

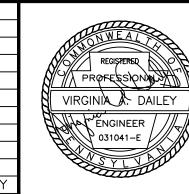






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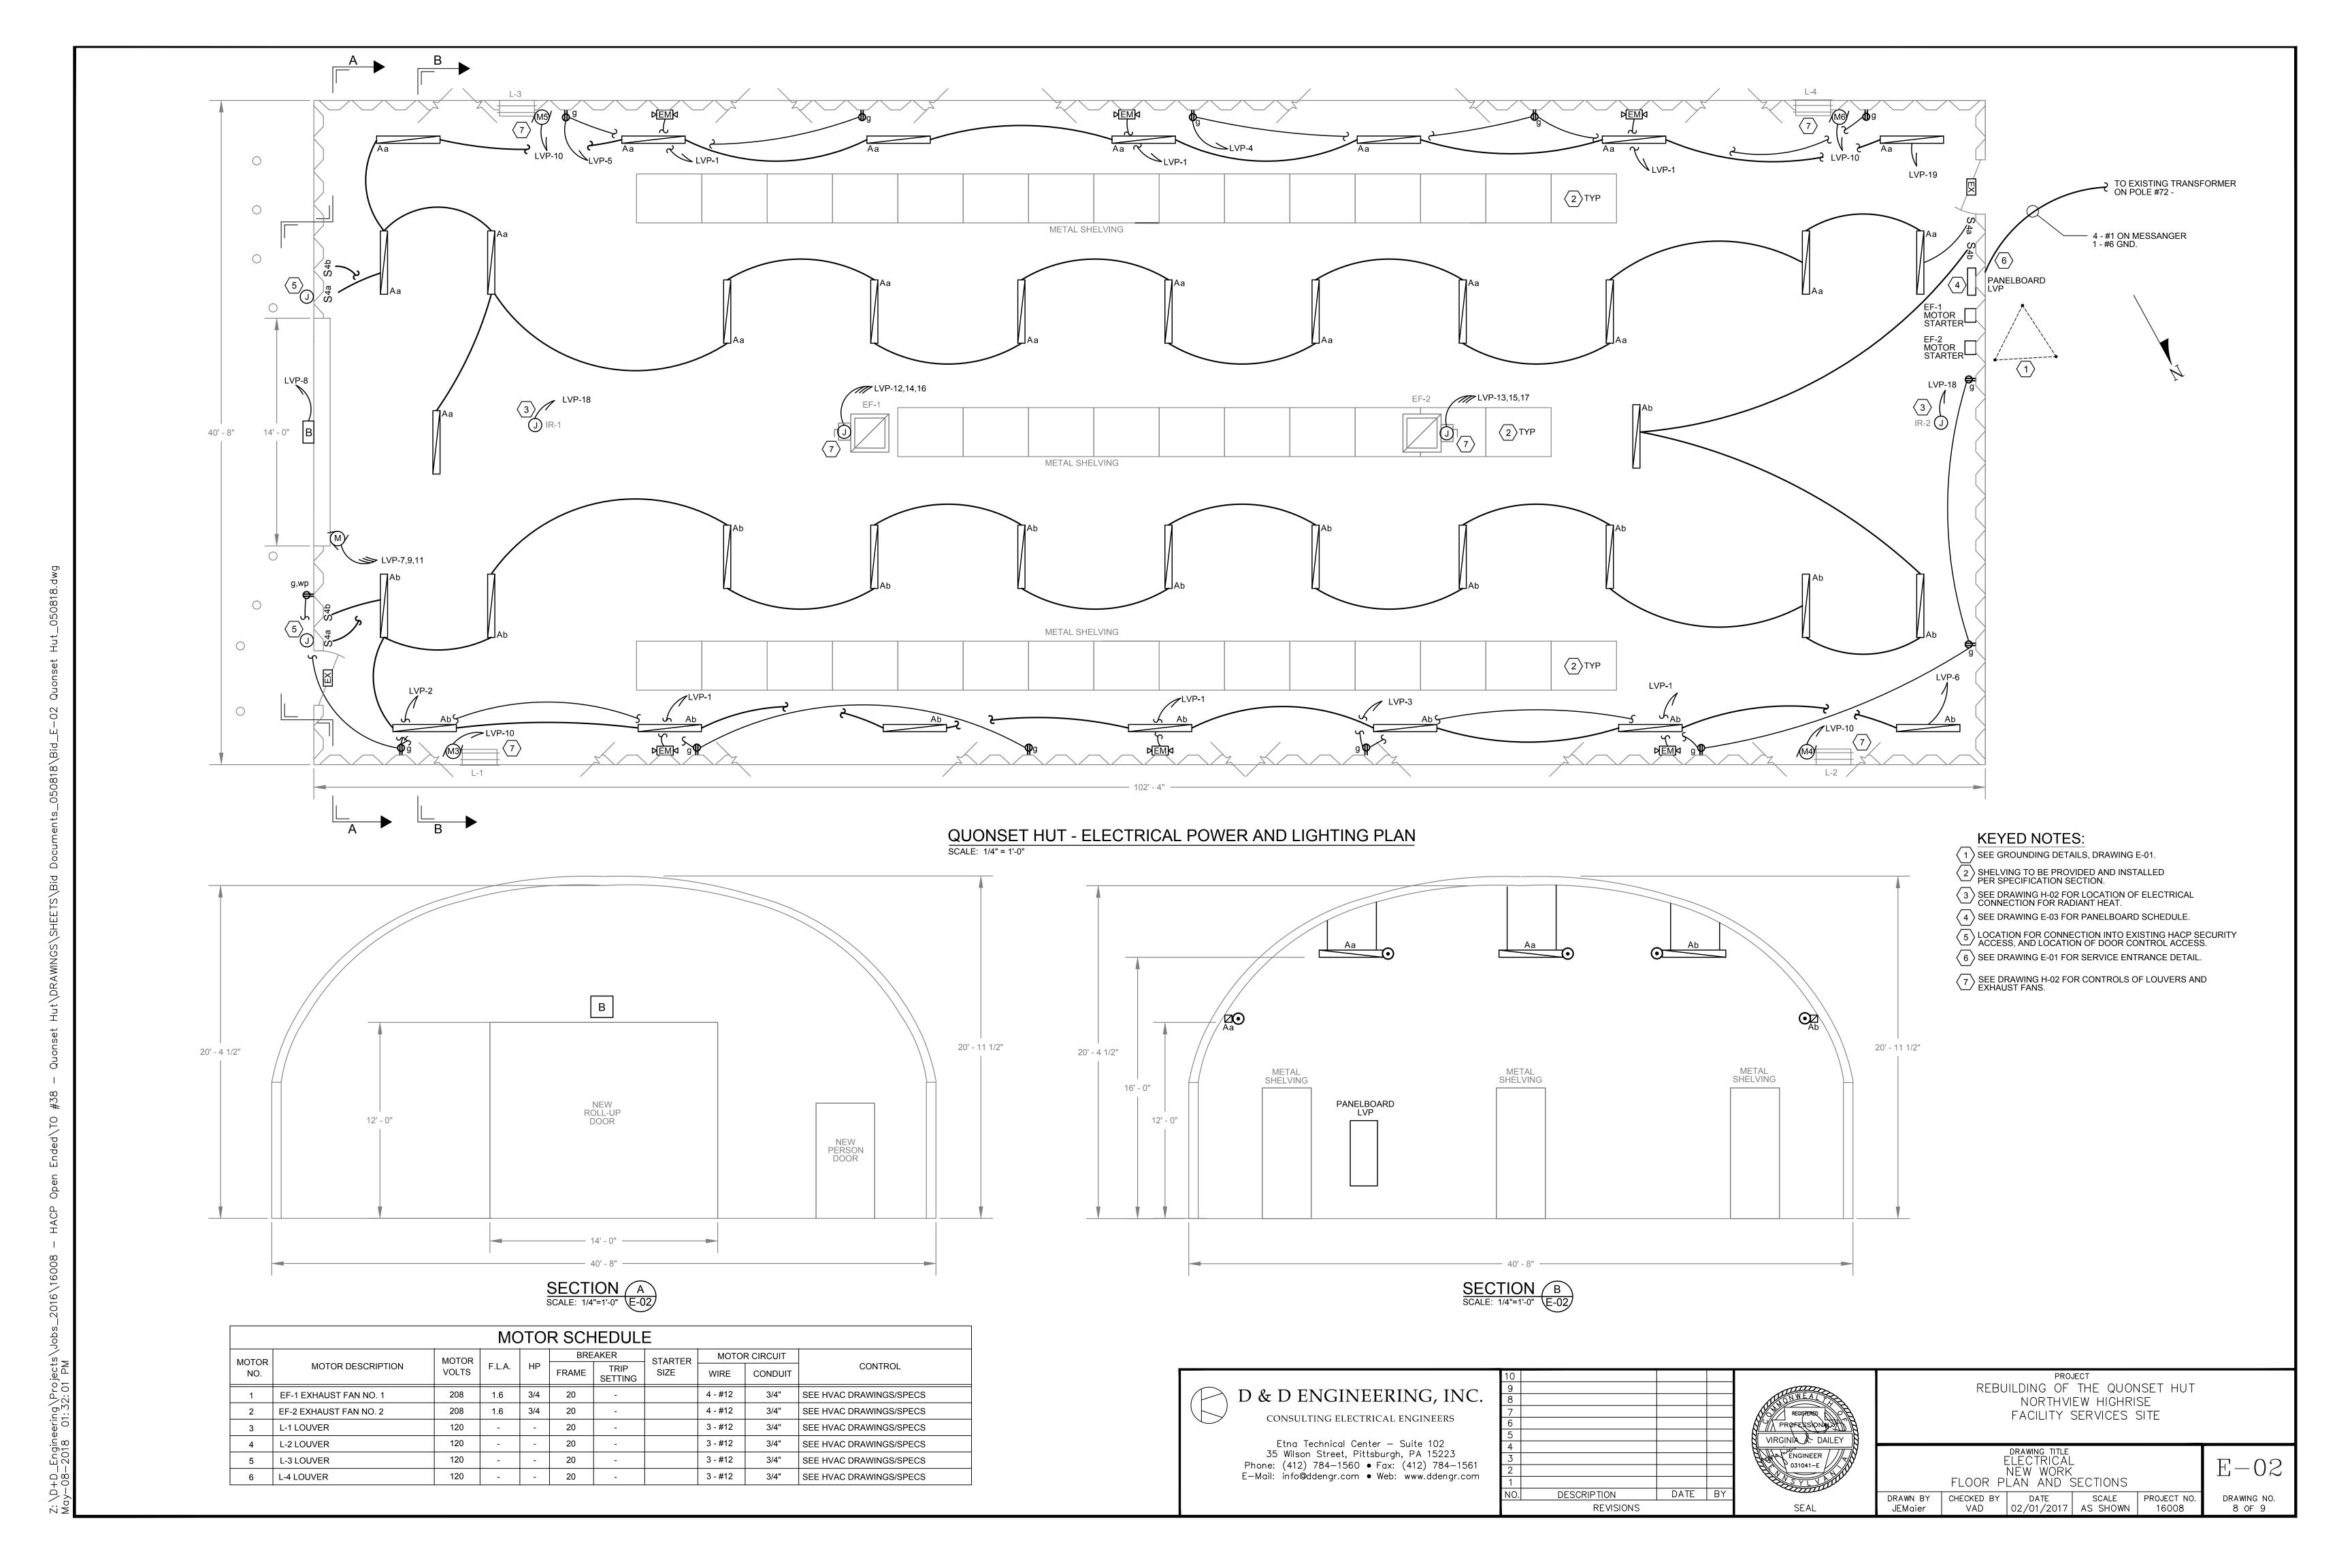
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REBUILDING OF THE QUONSET HUT NORTHVIEW HIGHRISE FACILITY SERVICES SITE

ABBR	EVIATIONS,	DRAWING TITLE ENERAL NO DETAILS, SCHEDULE	BUILDING	COĎE,	E
DRAWN BY JEMaier	CHECKED BY VAD	DATE 11/10/2016	SCALE AS SHOWN	PROJECT NO. 16008	DI

RAWING NO. 7 OF 9






EXISTING MAIN FRONT ROLL-UP AND PERSON DOOR 2

## KEYED NOTES:

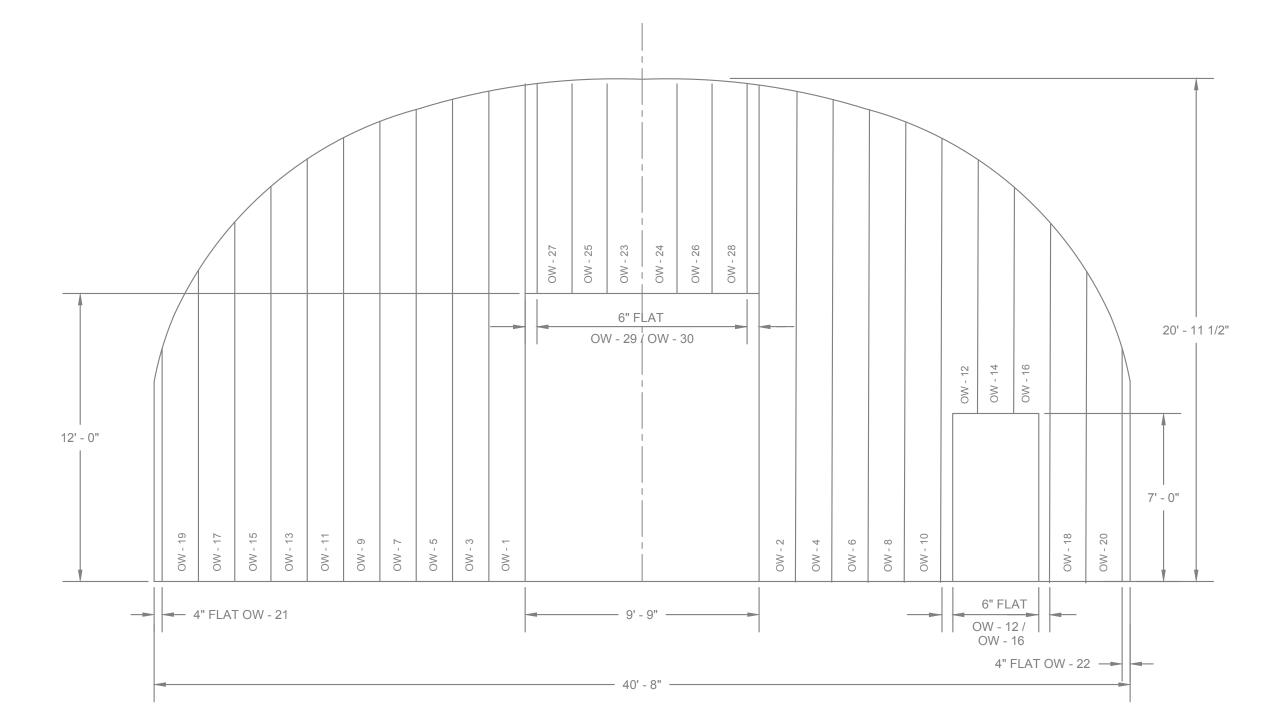
- 1) EXISTING SERVICE ENTRANCE AND PANEL TO BE DEMOLISHED AND REPLACED. SEE THIS DRAWING FOR NEW PANELBOARD SCHEDULE.
- 2 EXISTING FRONT ROLL-UP DOOR TO BE REPLACED WITH NEW 14-FOOT WIDE DOOR. ALL MODIFICATIONS TO EXISTING OPENING TO BE MADE TO MAINTAIN INTEGRITY OF STRUCTURE.
- EXISTING BOLLARDS TO BE REMOVED AND REPLACED ONCE NEW DOOR IS INSTALLED. ADDITIONAL BOLLARDS TO BE INSTALLED AT THREE-FOOT INTERVALS ALONG ENTIRE FRONT OF BUILDING.

   THIS DRAWING INFORMATION PROVIDED BY SHOP DRAWINGS SUPPLIED BY HOUSING AUTHORITY, CITY OF PITTSBURGH. CONTRACTOR SHALL VERIFY INFORMATION AS IT PERTAINS TO INSTALLATION OF NEW ROLL-UP DOOR.



DETAIL - FRONT ENDWALL WITH EXISTING DOOR SIZE - 12'H X 10'W OPENING

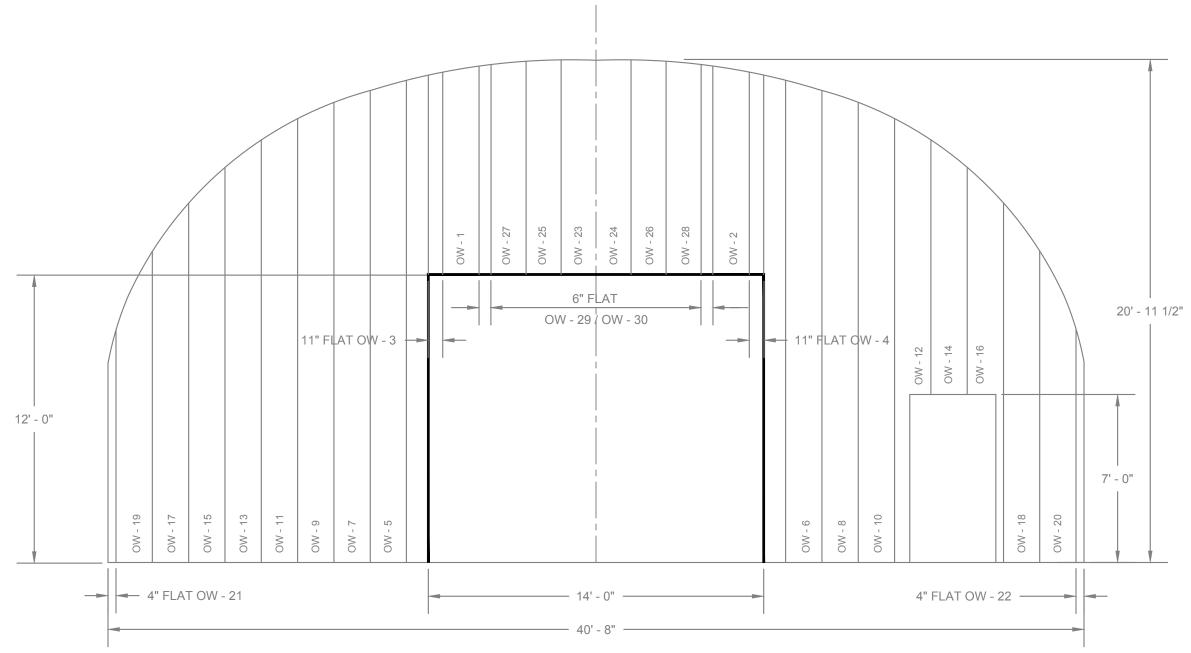SCALE: 1/4" = 1'-0"



2 DETAIL - FRONT ENDWALL WITH NEW DOOR SIZE - 12'H X 14'W OPENING SCALE: 1/4" = 1'-0"

MAIN	s·	100A	MCB					MOUNTING:	SURFACE		
VOLT		208/120V	m ob					AIC	10000		
PHAS		3	WIRES: 4					REMARKS	10000		
			DESCRIPTION		0/0	0/0	LOM	DESCRIPTION	T	BU	NO
NO	PH	KW			C/B	C/B	KW			PH	NO
1	Α	1.20	EMERGENCY LIGHTING	<del></del>	20/1	20/1	0.80	OUTLETS		Α	2
3	В	0.80	OUTLETS		20/1	20/1	0.80	OUTLETS		В	4
5	С	0.80	OUTLETS		20/1	20/1	0.80	LIGHTING		С	6
7	Α					20/1	0.40	EXTERIOR LIGHTING		Α	8
9	В	1.50	ROLL UP DOOR		20/3	20/1	0.10	LOUVERS		В	10
11	С									С	12
13	Α					20/3	1.50	EF-1		Α	14
15	В	1.50	EF-2		20/3					В	16
17	С					20/1	0.20	IR CONTROL BOXES		С	18
19	Α	0.80	LIGHTING		20/1	20/1		SPARE		Α	20
21	В		SPARE		20/1	20/1		SPARE		В	22
23	С		SPARE		20/1	20/1		SPARE		С	24
25	Α		SPARE		20/1	20/1		SPARE		Α	26
27	В		SPARE		20/1	20/1		SPARE		В	28
29	С		SPARE		20/1	20/1		SPARE		С	30
	Α	2.00		TOTALS	Α	4.70			2.70	Α	
	В	3.80			В	4.70	1		0.90	В	
	С	0.80			С	1.80	]		1.00	С	
		•	_				-		•		_
NOTE	S:										


LOCATION: CONNECTED LOAD 11.20 KW CONNECTED AMPS 31.12 A



## D & D ENGINEERING, INC. CONSULTING ELECTRICAL ENGINEERS
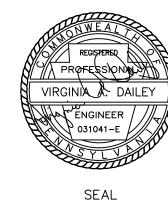
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PROJECT
REBUILDING OF THE QUONSET HUT
NORTHVIEW HIGHRISE
FACILITY SERVICES SITE

DRAWING TITLE ELECTRICAL PICTURES, DETAILS AND PANELBOARD SCHEDULE					E-03
DRAWN BY	CHECKED BY	DATE	SCALE	PROJECT NO.	DRAWING NO.
JEMaier	VAD	02/01/2017	AS SHOWN	16008	9 OF 9